

19 May 2017

Dear Sir / Madam,

Tender Reference No. (302) in P/AE/PUR/AGC Invitation to Tender for the Fitting Out Works for the Construction Innovation and Technology Application Centre (CITAC) for the Construction Industry Council

You are invited to submit a tender for the Fitting Out Works for the Construction Innovation and Technology Application Centre (CITAC) for the Construction Industry Council as specified in the tender documents.

- Your tender proposal, in copies specified in the tender, should be submitted in two separate sealed envelopes.
- The tenderer shall deposit two <u>separate</u> sealed envelopes with labels as specified below into the tender box located at CIC Headquarters - 38/F, COS Centre, 56 Tsun Yip Street, Kwun Tong, Kowloon, Hong Kong <u>not later than 12:00 noon</u> <u>on 9 June 2017.</u> Late tenders will NOT be considered.
 - a) Label with "Technical Proposal for Fitting Out Works for the Construction Innovation and Technology Application Centre (CITAC) for the Construction Industry Council"
 - b) Label with "Fee Proposal for Fitting Out Works for the Construction Innovation and Technology Application Centre (CITAC) for the Construction Industry Council"

Please note that the envelope labelled with "Technical Proposal" shall <u>NOT</u> include any pricing details. Failure to do so will render the tender null and void. Tenders submitted after the above time or tenders deposited at places other than that stated above will <u>NOT</u> be considered.

3. The tenderer shall provide the completed 'Application Form for Inclusion in the CIC Vendor List' as provided in the tender invitation, containing basic information of the interested tenderer (For Non-CIC Registered Vendor only).

- 4. In the event of Typhoon Signal No. 8 or above, or Black Rainstorm Warning is hoisted on the tender closing date, the closing time will be postponed to 12:00 noon of the next working day.
- 5. Construction Industry Council is not bound to accept any proposal it may receive. In addition, it will reject bids which are considered to have been priced unreasonably low.
- 6. It should be noted that the Council will not be responsible for the reimbursement of any cost incurred by you for the preparation of the submission.
- 7. The invited tenderer who has decided to decline the bid shall return the Reply Slip for Declining Bid provided in Appendix G of the Conditions of Tender.
- 8. There will be a briefing session and site visit session at 10:00 am on 26 May 2017, G/F, CIC Kowloon Bay Training Centre, 44 Tai Yip Street, Kowloon Bay, Kowloon, Hong Kong (Exit A, MTR Kowloon Bay Station). Interested tenderers shall complete and return the reply slip in Appendix F by fax 2100 9439 or e-mail: kelvinlee@cic.hk no later than 17:00 on 25 May 2017 confirming the attendance of the said tender briefing and site visit session and state clearly the number of attendees for CIC's arrangement.
- 9. The tender documents can be downloaded from CIC's website: http://www.cic.hk.
- For queries regarding this tender invitation or/and tender process, please contact Mr. Kelvin LEE, Senior Officer – Management Support, on telephone 2100-9425 or via e-mail: <u>kelvinlee@cic.hk</u>.

Yours sincerely,

Justin WONG

Manager – Projects & Contracts Administration

Encl.

Checklist for Submission of Tender

Please go through the following checklist to ensure that all necessary information and documents for the tender have been provided in your tender submission. Please note that the checklist is for guidance and reference purposes only and shall not be deemed to form part of the Tender Document. The address labels at the bottom of this checklist may be used on the envelopes for submitting the tender.

Tenderers should note that their tenders may be invalidated if the information in the tender submission is incorrect or the required documents are not provided together with the tender document.

	Particulars	Reference
Technica	I Proposal	
1. Organ	isation of Proposed Project Team	Conditions of Tender, Appendix A Clause 1.1
2. Qualifi	cations of Proposed Project Team	Conditions of Tender, Appendix A Clause 1.2
3. Tende Refere	,	Conditions of Tender, Appendix A Clause 2.1, 2.2, 2.3 and 2.4
fulfill t delive	ach and Work Programme to (i) he technical requirements and (ii) r all deliverables outlined in the nment Brief and its Annexes	Conditions of Tender, Appendix A Clause 3.1
	ly completed Standard Letter for ying with Anti-Collusion Clause	Conditions of Tender, Appendix B
of Cor	v signed CIC's General Conditions ntract and Guidelines for Works or es (2b)-CAR	CIC's General Conditions of Contract and Guidelines for Works or Services (2b)-CAR
	documents mentioned in the ical Assessment Marking Scheme	Conditions of Tender, Appendix E
115, Health Contra	nents of Convictions under Cap. Cap. 59 and Cap. 57, Outline a & Safety Plan, Minor Works actor Registration or General ag Contractor Registration	Special Conditions of Tender
Fee Prop	osal	
9. Form	of Tender	Conditions of Tender, Appendix C
10. Fee P	roposal	Conditions of Tender, Appendix D

Construction Industry Council

Fitting Out Works for the Construction Innovation and Technology Application
Centre (CITAC) for the Construction Industry Council

Please adhere the following labels on separate sealed envelope of your submitted tender.

Construction Industry Council (CIC)

The Tender Box 38/F, COS Centre,

56 Tsun Yip Street,

"Confidential"

Technical Proposal

	Kwun Tong, Kowlo	on, Hong Kong
	_	[(<u>302</u>) in P/AE/PUR/AGC] or the Construction Innovation and ation Centre (CITAC) for the Construction
Name of Tenderer:		_
	Closing Time and D	Date: <u>12:00 noon on 9 June 2017</u>
"Confidential"		
	Construction Indus	stry Council (CIC)
	The Tender Box	
Fee Proposal	38/F, COS Centre, 56 Tsun Yip Street,	
	Kwun Tong, Kowlo	
	Ref. No.:	[(302) in P/AE/PUR/AGC]
1	•	r the Construction Innovation and Technology (CITAC) for the Construction Industry Council
Name of Tenderer:		
	Closing Time and [Date: <u>12:00 noon on 9 June 2017</u>



Ref. No.:	
檔案編號:	

Application Form for Inclusion in the CIC Vendor List

建造業議會承辦商/供應商登記申請書

This form should be completed in FULL BLOCK LETTERS

請詳細填寫本申請書並交回:

and returned to:

Tel. No.:

Procurement Department香港九龍觀塘駿業街56號Construction Industry Council中海日升中心38樓38/F, COS Centre, 56 Tsun Yip Street建造業議會

 Kwun Tong, Kowloon, Hong Kong
 採購部

 2100 9000
 電話號碼:
 2100 9000

 2100 9439
 圖文傳真號碼:
 2100 9439

Department. 如查詢此表格內的資料,包括查閱途徑及修訂資料,請與上述部門聯絡。

PART I - DETAILS OF THE COMPANY 第一部 - 公司資料

i)	Company Name:	(English) 【Company na	ume should correspond with that registered under the Business Registrat	tion Ordinance (Cap 310)]
	公司名稱:	(中文)【公司名稱須與	商業登記條例(第310章)內所登記的名稱相同】	
ii)	Company Address	: (English)		
	公司地址:	(中文)		
iii)	E-mail 電子郵件	:	(iv) Website	到址:
v)	Tel. No. 電話號碼	·	(vi) Fax. No.	圖文傳真號碼:
	otherwise.		all future CIC notifications will be dispatched by means 求,所有議會通訊將以電郵傳遞。	of email, unless specifically requested in writing to the CIC
		PART II	- ORGANISATIONS AND STAFF 第二語	部 - 公司組織及職員資料
i)	A partnership (uni A sole proprietorsh		獨資(非屬法團)	2章)註冊的法人團體
	Members of organ Directors / Proprie 董事 / 東主 / 合夥		English Name 英文姓名	Chinese Name 中文姓名
	* Delete where inappropri	ate 將不適用者刪去		



Ref. No.:	
當案編號:	

Application Form for Inclusion in the CIC Vendor List

(iii)	Person(s) to contact on mate 獲授權回答有關投標 / 合			s:			
	Name(s) 姓名	Off	icial Capacity 職位			Tel. No. 電話號碼	Mobile No. 流動電話號碼
(1)							
(2)							
(3)							
(iv)	Please confirm whether you Scheme (SRS). 請貴公司確認是否在分包		J			under the CIC's Subcontractor Registra	ation
	□ Yes,SRS Numb 是,分包商註冊		<u>:</u>			□ No 不是	
			PART III	- BU	SINE	SS TYPE 第三部 - 業務性質	
	Services and Goods which Please select your business Please tick ② as appro Business Type 業務性質	type and o				供應的服務及貨品 護選擇 <i>貴公司所屬的業務性質及相</i>	應的覆蓋範圍
	Type 1 - Supplier		Services 服務行業	_		(It I slot.) brol.	
	類別一 - 供應商	□ 1	Construction Materials			Accelerator (催乾劑)	
			(建築材料)		1.2	Acrylic Paint (亞加力漆) Air-conditioning & Ventilation Acce	esory (空調及通風配件)
				_	1.4	Adhesive / Sealant (膠漿 / 封邊膠)	SSOLY(王间)又通风化门
				_	1.5	Aggregates (石仔)	
				П		Air-conditioning & Ventilation (空訓	問及通風)
						Aluminium Bar / Hollow (鋁條 / 通)	
					1.8	Aluminium Foamwork Accessory (会	B模板配件)
					1.9	Aluminium Foamwork (鋁模板)	
					1.10	Aluminium Pipe (鋁管)	
					1.11	Aluminium Sheet (鋁板)	
					1.12	Anti-ant Paint (抗蟻油漆)	
					1.13	Asphalt (瀝青)	
					1.14	Bamboo & Accessory (竹料及配件)	
					1.15	Bar-bending & Fixing (鋼筋屈扎)	, Ald , Hr Ald Arts
				_	1.16	Bronze / Copper / Brass Pipe (青銅/	/ 刺 / 黄刺官)
				_	1.171.18	Bearing (啤令) Belt (坑帶)	
				_	1.19	Bitumen Compounds (瀝青混合物)	
				_	1.20	Boring Drill Accessory (岩土鑽探酢	7件)
				_	1.21	Bronze / Copper Bar (青銅 / 銅條)	3117
				_	1.22	Bronze / Copper Sheet (青銅 / 銅板))
					1.23	Bronze / Copper Wire (青銅 / 銅線)	
					1.24	Brushing Lacquer (手掃漆)	
					1.25	Bucket (桶 / 泥斗)	
					1.26	Cable Accessory & Trunking (電線]	配件及線槽)
					1.27	Cable (電線)	
					1.28	Canvas Goods (帆布及布帳製品)	
					1.29	Ceiling (天花)	



Ref. No.:	
檔案編號:	

Application Form for Inclusion in the CIC Vendor List

	1.30	Cement (水泥)
	1.31	Cement Paint (雪花英泥)
	1.32	Centre Punch (中心沖/賓子)
	1.33	Clear Lacquer (透明漆)
_	1.34	Clay Sand (黃花沙)
	1.35	Clear Varnish (透明清漆)
	1.36	Concrete Blocks (混凝土磚)
П	1.37	Concrete (混凝土)
П	1.38	Concrete Pipe (混凝土管道)
ū	1.39	Curtain Wall / External Cladding (幕牆/幕板)
	1.40	Drill Bit & Cutter Bit (鑽咀及刀咀)
ū	1.41	Door & Accessory (大門及配件)
	1.42	Dry Wall (石膏板)
	1.43	Electrode (電焊支)
	1.44	Electrical Supplies (電器材料)
П	1.45	Emulsion Paint / Latex (乳膠漆)
	1.46	Epoxy Coating (環氧塗料)
<u>-</u>	1.47	Epoxy (環氧樹脂漆)
		Fencing / Mesh / Chain (圍欄 / 鐵絲網 / 鎖鏈)
	1.48	-
	1.49	Fibre Glass Products (玻璃纖維產品)
	1.50	Filter (過濾器)
<u>_</u>	1.51	Fire Retardant Paint (防火漆)
<u>_</u>	1.52	Floor Board Coating (地台油)
<u>_</u>	1.53	Gaseous Fuels / Welding (氣體燃料 / 焊接)
	1.54	Glazed Ceramic Wall Tiles (牆壁瓷磚)
	1.55	Gloss Latex Paint (悅亮漆)
	1.56	Gloves (手套)
	1.57	Gold (金)
	1.58	Granite (麻石)
	1.59	Grinding / Polish (研磨 / 拋光)
	1.60	Hammertone Paint (鎚紋漆)
	1.61	Heat Insulating Materials (隔熱物料)
	1.62	Hot-dip Galvanizer (熱浸鍍鋅)
	1.63	Hose and Fittings (膠喉及配件)
	1.64	Homogeneous Floor Tiles (過底地磚)
	1.65	Hydrated Lime (熟石灰)
	1.66	Insulation Materials (絕緣體)
	1.67	Iron Work (訂製鐵器)
	1.68	Jointing (接□)
	1.69	Laminated Plywood (夾板)
	1.70	Luminous Paint (螢光漆)
	1.71	Marble & Accessory (雲石及配件)
	1.72	Metal / Plastic Container (金屬 / 塑膠容器)
	1.73	Metal Etching (金屬蝕刻)
	1.74	Mosaic Tiles (紙皮石)
	1.75	Multi-Colour Paint (多彩漆)
	1.76	Nail / Staple & Accessory (釘及配件)
	1.77	Non-slip Treatment (防滑處理)



Ref. No.:	
檔案編號:	

Application Form for Inclusion in the CIC Vendor List

/	1.78	Nylon (尼龍)
	_	
<u></u>	-	Pipe Fittings (管道配件)
<u></u>	-	Pipe (喉管)
<u> </u>	_	Pigment / Staining (色粉)
<u> </u>	-	Plastering (抹灰)
		Plastic Sheet / Board (膠片 / 膠板)
	1.84	Plastic / Wood Flooring (膠 / 木地板)
	1.85	Polyurethane Paint (聚脂漆)
	1.86	Polishing / Sharpening (拋光 / 磨石)
	1.87	Primer / Sealer (封底漆)
	1.88	Rain Gear (兩具)
	1.89	Red Bricks (紅磚)
	1.90	River Sand (淡水沙)
	1.91	Road Marking Paint (馬路劃線漆)
		Sanitary (潔具)
		Sanding Paper / Cloth (砂紙 / 布)
	-	Saw Blade / Wheel & Accessory (鋸片 / 碟及配件)
- T	-	Screw & Accessory (螺絲及配件)
	-	
		Scantling & Planking (什木枋板)
	-	Silk Screen (絲網)
<u> </u>	-	Stone Like Coating Paint (石頭漆)
	-	Solvent (溶劑)
		O Spraying Paint (噴漆)
	_	1 Steel / Iron Bar (鋼 / 鐵條)
	1.10	2 Steel / Iron Gate (鋼 / 鐵門)
	1.10	3 Steel / Iron Pipe (鋼 / 鐵管)
	1.10	4 Steel / Iron Sheet (鋼 / 鐵片)
	1.10	5 Steel / Iron Wire (鋼 / 鐵線)
	1.10	6 Stone (開山大石)
	1.10	7 Stopping (填補料)
	_	8 Steel Reinforcement (鋼筋)
-	_	9 Stainless Steel Bar (不銹鋼條)
	_	O Stainless Steel Pipe (不銹鋼管)
	-	1 Stainless Steel Sheet (不銹鋼片)
	_	2 Stainless Steel Wire (不銹鋼線)
<u> </u>	_	3 Steel Wire Rope / Nylon Webbing Sling (鋼絲繩 / 尼龍帆布帶)
L		
L		4 Surveying Supplies (測量材料)
<u>_</u>	_	5 Switch (掣)
	_	6 Synthetic Paint (合成油漆)
	_	7 Textured Latex (砂膠漆)
	1.11	8 Undercoat Pattern (底漆)
	1.11	9 Valve (閥門)
□	1.12	O Washable Distemper (可洗膠灰水)
	1.12	1 Wall Paper (牆紙)
	1.12	2 Water Proofing Material (防水物料)
	1.12	3 Water-boiled Proved Laminated Plywood (防水夾板)
	1.12	4 Weldmesh (馬路網)
	1.12	5 Window & Accessory (窗戶及配件)
_		



Ref. No.:	
檔案編號:	

Application Form for Inclusion in the CIC Vendor List

			1.126	Wire Rope (鋼纜)
			1.127	Wood Stripe (木線)
\square 2	Tools (手工具)		2.1	Brush & Accessory (刷及配件)
			2.2	Chisel (鑿)
			2.3	Crowbar (鐵筆)
			2.4	Drawing Instrument (繪圖工具)
			2.5	Electric Drill / Hammer Drill & Accessory (電鑽及配件)
			2.6	Edge Rule (壓尺)
			2.7	File (銼)
			2.8	Hammer (鎚仔)
			2.9	Masonry Tools (泥水工具)
			2.10	Meter / Tester (測試儀錶)
		П	2.11	Portable Electrical Tools & Accessory (手提式電動工具及配件)
		П	2.12	Pipe Bender & Expander (喉管屈曲器及掙大器)
		\Box		Pick (泥耙)
		\Box	2.14	Pipe Cutter (喉管剪鉗)
			2.15	Pipe Dies and Head (牙模及扳頭)
		_		Plane (刨)
			2.17	Plier / Pincer / Nipper (鉗子)
			2.18	Saw (鋸)
			2.19	Screwdriver (螺絲批)
		\Box	2.20	Spanner / Wrench (扳手)
		Н	2.21	Scraper / Shovel / Pottery Tool (刮 / 鏟 / 泥刮)
			2.22	Steel Snip/ Cutter (剪鉗)
			2.23	Surveying Level (測量平水儀)
			2.24	Surveying Scale (測量磅)
			2.25	Trowel (抹子 / 批匙)
		_	2.26	Vise (虎鉗 / 夾)
		_	2.27	Welding Tools (焊接工具)
□ 3	Industrial Safety &	_	3.1	Anti-Surge Protection (防電保護)
	Protective Products	_	3.2	Confined Space Equipment (密閉空間設備)
	(安全及防護產品)		3.3	Eye Protection (眼部保護)
			3.4	Fall Protection (高空防墮保護)
		_	3.5	First Aid Supplies (急救用品)
		_	3.6	Fire Extinguisher & Equipment (滅火筒及設備)
			3.7	Foot Protection (腳部保護)
			3.8	Gas & Radiation Detector (氣體及輻射探測器)
			3.9	Hand Protection (手部保護)
			3.10	Hearing Protection (聽覺保護)
			3.11	Head Protection (頭部保護)
		_	3.12	Noise Assessment Tools (噪音評估工具)
			3.13	Respiratory Protection (呼吸保護)
			3.14	Road Safety Equipment & Reflective Vest (交通安全用品及反光衣)
			3.15	Safety Net & Tool Box (安全網及工具箱)
			3.16	Safety Sign / Label (安全標貼/告示牌)
			3.17	Self-Contained Breathing Apparatus & Air Compressor (自供式呼吸器及空氣壓縮機)
			3.18	Welding Protection (燒焊保護)



Ref. No.:	
當案編號:	

Application Form for Inclusion in the CIC Vendor List

ш	i cu oicum & i uci	ш	And Rust Spruy (例如於 與物)
	Products	4.2	Brake Fluid (剎掣油)
	(石油及燃油產品)	4.3	Cutting Oil (切割油)
		4.4	Hydraulic Oil (液壓油)
		4.5	Industrial Diesel Oil (工業柴油)
		4.6	Lubricant Oil / Grease Oil (潤滑油/潤滑脂油)
		4.7	Transmission Oil (傳動油)
		4.8	Ultra Low Sulphur Diesel Oil - Ex-petroleum Filling Stations (超低含硫柴油 - 油站加油)
		4.9	Unleaded Petrol - Ex-petroleum Filling Stations (無鉛汽油 - 油站加油)
□ 5	Construction	5.1	Aluminium / Galvanized Iron Working Platform (高空工作台)
	Equipment &	5.2	Air Compressor & Blower (風機)
	Machinery (建築設備及機械)	☐ 5.3	Bolt & Pipe Threading Machine / Groove Machine (電動管紋機 / 壓坑機)
		5.4	Builder's Lift (建築工地升降機 - 工人籠)
		□ 5.5	Cable Dectector (地下電纜探測器)
		5.6	Concrete Mixers (混凝土攪拌機)
		5.7	Concrete Vibrator (混凝土震機)
		5.8	Crawler Crane (履帶式吊機)
		5.9	Dozers (推土機)
		5.10	Dust Collectors (集塵器)
		5.11	Forklifts and Tow Tractors (叉車及拖引車)
		5.12	Gantry Crane (龍門式吊機)
		5.13	Generator Set (發電機組)
		5.14	Gondola Systems (吊船)
		5.15	Hydraulic Punching / Shearing / Swing Beam Machine (液壓沖 / 剪 / 擺式剪板機)
		5.16	Hydraulic Excavators (液壓挖土機)
		5.17	Loaders (裝載機)
		5.18	Mobile / Trucks / Lorry Crane (汽車吊機)
		5.19	Metal Work Machine & Equipment (金屬工作機)
		5.20	Pipe Welding Machine (喉管熱熔對接焊機)
		5.21	Plate Compactor (壓路板)
		5.22	Pump (泵)
		5.23	Roller Shutter (捲閘)
		5.24	Spray Booth (噴漆柜)
		5.25	Surveying Measuring Instrument (測量儀器)
		5.26	Thicknessing Planer (壓鉋機)
		5.27	Tower Crane (塔式吊機)
		5.28	Wood Turning Lathe (木車床)
☐ 6	Repair &	6.1	Repair & Maintenance – Air-conditioning & Ventilation (空調及通風維修保養)
	Maintenance	6.2	Repair & Maintenance – Builders' Lift – Hoists (建築工地升降機維修保養)
	Equipment / Tools (維修及保養設備	6.3	Repair & Maintenance – Carpark System (停車場系統維修保養)
	或工具)	6.4	Repair & Maintenance – Cleaning Equipment (清潔設備維修保養)
		6.5	Repair & Maintenance – Construction Machine & Equipment (建築機械及設備維修保養)
		6.6	Repair & Maintenance – Crawler Crane (展帶式吊機維修保養)
		6.7	Repair & Maintenance – Diesel Generating Set (柴油發電機組維修保養)
		6.8	Repair & Maintenance – Drinking Facilities & Equipment (飲用水設施及設備維修保養)



Ref. No.:	
檔案編號:	

Application Form for Inclusion in the CIC Vendor List

	6.9	Repair & Maintenance – Electrical (电工工住継修休食)
	6.10	Repair & Maintenance – Fire Service Facilities & Equipment (消防設施及設備維修保養)
	6.11	Repair & Maintenance – Gantry Crane (龍門式吊機維修保養)
	6.12	Repair & Maintenance – Glass (玻璃維修保養)
	6.13	Repair & Maintenance – Gondola System (吊船系統維修保養)
	6.14	Repair & Maintenance – Hydraulic Mobile Crane (液壓輪胎式吊機維修保養)
	6.15	Repair & Maintenance – Kitchen Equipment & Facilities (廚房設備及設施維修保養)
	6.16	Repair & Maintenance – Lift & Escalator (升降機及扶手電梯維修保養)
	6.17	Repair & Maintenance - Lightning System (避雷系統維修保養)
	6.18	Repair & Maintenance – Lorry Crane (起重機貨車維修保養)
	— ☐ 6.19	Repair & Maintenance – Measurement Equipment (量度設備維修保養)
	6.20	Repair & Maintenance – Metal Work Machine & Equipment (金屬工作機械及設備維修保養)
	6.21	Repair & Maintenance – Non-Destructive Testing Equipment (非破壞性測設備維修保養)
	6.22	Repair & Maintenance – Office Equipment (辦公室設備維修保養)
	6.23	Repair & Maintenance – Photocopier Machine (影印機維修保養)
	6.24	Repair & Maintenance – Plumbing & Drainage (水務工程維修保養)
	6.25	Repair & Maintenance – Power Supply Facilities (電力裝置設備維修保養)
	— ☐ 6.26	Repair & Maintenance – Power Tools (電動工具維修保養)
	— ☐ 6.27	Repair & Maintenance – Private Car (私家車維修保養)
	— ☐ 6.28	Repair & Maintenance – Safety Equipment (安全設備維修保養)
	─ 6.29	Repair & Maintenance – Security Facilitate (警衛設備維修保養)
	☐ 6.30	Repair & Maintenance – Sports Equipment (體育設備維修保養)
	☐ 6.31	Repair & Maintenance – Survey Equipment (測量設備維修保養)
	☐ 6.32	Repair & Maintenance – Tower Crane (塔式起重機維修保養)
	☐ 6.33	Repair & Maintenance – Water Pump (水泵維修保養)
	☐ 6.34	Repair & Maintenance – Walkie Talkie (對講機維修保養)
	☐ 6.35	Repair & Maintenance – Welding Tools & Equipment (焊接工具設備維修保養)
	☐ 6.36	Repair & Maintenance – Windows (窗戶維修保養)
7 Testing & Survey	7.1	Testing & Survey - Air Quality (室內空氣質素測試)
(測試及檢驗)	☐ 7.2	Testing & Survey - Acoustic Test / Noise Assessment (噪音評估測試)
	7.3	Testing & Survey - Car & Lorry (車輛續牌驗查)
	☐ 7.3 ☐ 7.4	Testing & Survey - Compressor & Blower (空氣壓縮機測試)
	☐ 7. -	Testing & Survey - Drinking Water (飲用水測試)
	☐ 7.5 ☐ 7.6	Testing & Survey - Fire Service Installation & Equipment (消防裝置及設備檢測)
	☐ 7.0 ☐ 7.7	Testing & Survey - Gas Cylinder & Tester (氣樽及試錶測試)
	-	Testing & Survey - Gondola System (吊船系統測試及檢查)
	_	
	7.9	Testing & Survey - Illumination Quality (照明質量測試) Testing & Survey - Ingression Testing & Configuration for Fixed Floatrical
	7.10	Testing & Survey - Inspection, Testing & Certification for Fixed Electrical Installations (固定電力裝置定期測試及檢查)
	7.11	Testing & Survey - Jack & Lifting (千斤頂安全測試)
	7.12	Testing & Survey - Lift & Escalator (升降機安全負荷測試)
	7.13	Testing & Survey - Loader & Crane (裝載及起重機械安全負荷測試)
	7.14	Testing & Survey - Measurement Tool (儀器精確度測試及調較)
	7.15	Testing & Survey - Non-Destructive (非破壞性檢測)
	7.16	Testing & Survey - Power Supply Facilities (電力裝置設備測試及檢查)



Ref. No.:		
檔案編號:		

Application Form for Inclusion in the CIC Vendor List

建造業議會承辦商/供應商登記申請書 ロ 7.17 Testing & Survey - Safety Equipment (安全

			ш	,	resting & Survey Survey Equipment (§ Extimation)
				7.18	Testing & Survey - Testing Materials / Laboratory Services (物料 / 化驗服務測試)
				7.19	Testing & Survey - Tower Crane (塔式起重機測試及調查)
	□ 8	Environmental		8.1	Asbestos Removal (清理石棉)
		Engineering &		8.2	Dumping - Construction Materials (建築物廢料處理)
		Waste Disposal (環保工程及		8.3	Grease Trap Cleaning & Maintenance (隔油池清洗及保養)
		廢物處理)		8.4	Environment Planning (環保規劃)
				8.5	Environment Recycling (環保再造)
				8.6	Sewage Treatment (污水處理)
				8.7	Tree Risk Assessment (樹木風險評估)
				8.8	Waste & Scrap Disposal (廢置材料回收)
	9	Office Furniture &		9.1	Carpet / Floor Mat (地毯)
		Equipment		9.2	CCTV System (閉路電視監控系統)
		(辦公室傢俱及 設備)		9.3	Chair (椅子)
		以州		9.4	Cleaning Supplies (清潔用品)
				9.5	Cleaning Tools (清潔工具)
				9.6	Clock & Watch (鐘錶)
				9.7	Communication System (通信系統)
				9.8	Curtain & Blinds (窗簾及百葉簾)
				9.9	Doorphone System (門禁系統)
			П	9.10	Electric Household Appliance (家用電器)
				9.11	Filing Cabinet / Locker (文件櫃/儲物櫃)
				9.12	Glass & Accessory (玻璃及配件)
			П	9.13	Ink Cartridges, Toner Cartridges & Ribbons (打印機油墨盒, 碳粉盒及色帶)
				9.14	Information Display System and Service (資訊顯示系統和服務)
				9.15	Kitchen Equipment (廚房設備)
				9.16	Lighting / Bulb (照明/燈泡)
				9.17	Medicine & Health Supplies (藥物及健康)
				9.18	Office / Storage Container (辦公室/貯物貨櫃)
			$\overline{\Box}$	9.19	Partition Panel and Accessory (屏風及附件)
			$\overline{\Box}$	9.20	Paper (紙張)
			$\overline{\Box}$	9.21	Paper Shredder / Laminator (碎紙機 / 過膠機)
				9.22	Pantry Supplies (茶水間用品)
				9.23	Paper Towels & Tissues (紙巾及廁紙)
				9.24	Sign (門牌)
				9.25	Stage & Accessory (舞台用品)
				9.26	Stationery (文具)
				9.27	Steel Desk (鋼枱)
				9.28	Wall Board Assembly (組合壁板)
				9.29	Water Dispenser & Service (飲水機及服務)
				9.30	Wooden Desk (木枱)
	1 0	Printing &		10.1	Printing of Annual Report (印刷年報)
		Photocoping Services (印刷及複印服務)		10.2	Printing of Aluminium Roll-Up Screen (印製易拉架)
				10.3	Printing of Booklet & Handouts (印刷小冊子及講義)
		(中国四月/天门及中国队4方)		10.4	Printing of Certificate (印刷證書)
				10.5	Printing of Company Letterhead Materials (印刷公司印刷品)
				10.6	Printing of Flag / Banner (印製旗/旗幟)



Ref. No.:	
當案編號:	

Application Form for Inclusion in the CIC Vendor List

			10.7	Printing of Name Card (印刷卡片)
			10.8	Photocopying Services (複印服務)
			10.9	Printing of Promotional Items (印刷宣傳用品)
			10.10	Printing / Production of Backdrop (印刷 / 製作背幕)
			10.11	Printing of P.V.C. Card (印製證明卡)
□ 11	Information		11.1	Computer Hardware Accessory (電腦硬件配件)
	Technology and		11.2	Computer Hardware (電腦硬件)
	Computers (資訊科技及電腦)		11.3	Computer Hardware Leasing (電腦硬件租用)
	(吳田村 13人)人 电脑		11.4	Computer Hardware Peripheral (電腦硬件周邊)
			11.5	Computer Network (電腦網絡)
			11.6	Contract Out Works - Computer Service (外判工程 - 電腦服務)
			11.7	Computer Software (電腦軟件)
			11.8	Computer Software & Services Subscription (電腦軟件及服務租用)
			11.9	Information Technology & Telecommunications (資訊科技及電信)
			11.10	Repair & Maintenance – Audio / Visual (音頻 / 視頻維修保養)
			11.11	Repair & Maintenance – Computer Equipment (電腦設備維修保養)
			11.12	Repair & Maintenance – Card Printer (證明卡打印機維修保養)
		П	11.13	Repair & Maintenance – Computer Room Facilities (電腦房設備維修保養)
		$\overline{\Box}$		Repair & Maintenance – Software and Application Support
				(軟件及應用系統支援維修保養)
			11.15	Repair & Maintenance – Server and Network Services
		_		(伺服器及網絡服務維修保養)
				Repair & Maintenance – Telecom System & Equipment (電訊系統及設備維修保養)
				Contract Out Works - Software Development (外判工程 - 軟件開發)
				Rental of Telecom System & Equipment (租用電訊系統及設備)
				Telecom Services (電訊服務)
□ 12	Rental Services (租用服務)		12.1	Rental of Crane (租用吊機)
	(1旦/130区4万)		12.2	Rental of Cylinder Service & Air Filling (租用氣樽及充氣)
			12.3	Rental of Digital Photocopier (租用影印機)
			12.4	Rental of Generator Set (租用發電機組)
			12.5	Rental of Gown (租用禮服)
			12.6	Rental of Horses and Carriage Service (租用馬車服務)
			12.7	Rental of Machinery Equipment (租用機械設備)
			12.8	Rental of Portable Mobile Toilets with Hygiene Service (租用流動式廁所及清理服務)
			12.9	Transportation Service - Goods (貨運服務)
			12.10	Transportation Service - Passenger (客運服務)
□ 13	General Supplies		13.1	General Fixture (一般固定裝置)
	(一般供應)		13.2	Light Truck / Coaster (輕型貨車及小巴)
			13.3	Private Car (私家車)
			13.4	Promotional Items (宣傳物品)
			13.5	Reference Book/ Reference Report & Publication (參考書/ 參考報告及刊物)
			13.6	Seasonal Decoration (節慶裝飾)
			13.7	Souvenir (紀念品)
			13.8	Sports Equipment (適體健器材)
			13.9	Stage Accessory (舞台用品)
			13.10	
				Trophy / Medals (獎杯 / 獎牌)
		_		



Ref. No.:	
當案編號:	

Application Form for Inclusion in the CIC Vendor List

			13.12	Uniform (制服)
			13.13	Walkie Talkie (對講機)
1 4	General Services		14.1	Advertisement - Advertising Design & Production (廣告設計及製作)
	(一般服務)		14.2	Advertisement - Advertisement Production & Placement Services (廣告製作及報刊廣告代理服務)
			14.3	Referee Services (裁判服務)
			14.4	Catering Services (餐飲服務)
			14.5	Clipping Services (剪報服務)
			14.6	Catering / Kitchen Equipment and Services (餐飲/廚房設備及服務)
			14.7	Cleaning Services (清潔服務)
			14.8	Copywriting & Editoral Services (撰稿及編輯服務)
			14.9	Drycleaning & Laundry Services (乾洗及洗衣服務)
			14.10	Driver Services (司機服務)
			14.11	Disposal Services (棄置服務)
			14.12	Design Services - Graphics Design (平面設計)
			14.13	Design Services - Illustration / Character Design (插畫 / 角色設計)
			14.14	Design Services - Interior / Exterior Design (室內 / 室外設計)
			14.15	Design Services - Product and Logo Design (產品及商標設計)
			14.16	Design Services - Website / Apps Design & Development (設計網頁 / 應用程式及製作)
			14.17	Event Management - Exhibition Booth Design, Production & Installation (展覽攤位設計、製作及佈置)
			14.18	Event Management - Event Production & Management Services (活動籌辦及管理服務)
			14.19	Event Management - Photography Services (照相服務)
			14.20	Event Management - Video Broadcast Services (視頻廣播服務)
				Event Management - Video Shooting and Editing Services (影片製作及剪接)
				Football Referee Services (足球裁判服務)
				Landscape & Gardening (園境及園藝)
				Lettershop Services (入信服務)
				Logistics & Transport Services (物流及運輸服務)
				Mailing / Courier & Delivery Services (郵寄 / 速遞及運送服務)
				Pest Control (蟲害防治)
				Property / Facility Management (物業 / 設施管理)
				Public Relations (公共關係)
				Scanning Services (掃描服務)
				Security Guarding Services (保安護衛服務)
		Ц		Signage Production (指示牌製作)
				Translation Services - Annual Report Translation (年報翻譯)
		Ц		Translation Services - General Translation (一般翻譯)
— 15	Danfarria and	Ц		Translation Services - Simultaneous Translation & Interpretation (即時翻譯及傳譯)
☐ 15	Professional Services		15.1	Agency Services (代理服務)
	(專業服務)		15.2	Consultancy Services (顧問服務)
			15.3	Auditing Services (審計服務) Building Information Modeling (BIM) (建築料真模型)
			15.4	Building Information Modeling (BIM) (建築訊息模型) Certificate Services (認證服務)
			15.5	
			15.6 15.7	Counseling Services (輔導服務) Human Resources Services (人力資源服務)
			15.7	Insurance - General Insurance (一般保險)
		Ш	13.0	msurance - General Insurance (別文所改)



Ref. No.:		
檔案編號:		

Application Form for Inclusion in the CIC Vendor List

建 造 業 議 會 承 辦 商 / 供 應 商 登 記 申 請 書 Insurance - Medical Insurance (醫療保險) □ 15.10 Legal Services (法律服務) ■ 15.11 Market Research (市場調査) ☐ 15.12 Medical Services (醫療服務) ☐ 15.13 Quality Management Services (質量管理服務) ■ 15.14 Risk Management and Data Privacy Assessment (風險管理及數據私隱評估) □ 15.15 Trade Testing (技能測試) ■ 15.16 Training - Course (培訓課程) □ 15.17 Training - Management (培訓管理) □ 15.18 Training - Safety (培訓安全) **Type 2 - Construction Contractor** Contractors – Air-conditioning & Ventilation (空調及通風) □ 類別二 - 建築工程承辦商 □ Contractors – Building Information Modeling (建築訊息模型) Contractors - Carpark System (停車場系統) Contractors - Curtain / Blind / Carpet Tile/ Floor Finishes (窗簾/簾/方塊地毯/ 地板) Contractors – Design & Construction (設計及施工工程) 6 Contractors – Demolishment Work (拆除工程) Contractors – Electrical (電工工程) 7 8 Contractors – External Wall (外牆工程) Contractors – Facility Security (設備保安) 10 Contractors – Civil, Foundation & Geotechnical (土木, 地基及土力工程) 11 Contractors – Fire Service Facilities & Equipment (消防設施及設備工程) 12 Contractors – Gas & Oil (煤油及石油氣工程) 13 Contractors – Glass (玻璃工程) 14 Contractors – Grass Cutting (剪草) 15 Contractors – Kitchen Equipment & Facilities (廚房設備及設施工程) 16 Contractors – Lift & Escalator (電梯及扶手電梯) 17 Contractors – Platform (平台) 18 Contractors – Plumbing & Drainage (水務工程) 19 Contractors - Playground Equipment (遊樂場設備) 20 Contractors - Scaffolding Work (建築棚架工程) 21 Contractors – Steel Door Work (鋼門工程) 22 Contractors – Structure Repair (結構修復工程) 23 Contractors – Steel Structural Work (鋼鐵結構工程) 24 Contractors – Waterproof (防水工程) 25 Contractors – Windows (窗戶工程) 26 Contractors – Wooden Door Work (木門工程) □ 27 Contractors – Workshop Equipment & Facilities (測試場設備及設施工程) Type 3 - Others (please specify if the above is found inappropriate) 請細列明如上述沒有適用者 □ 類別三-其他 3.1

(Note: If found insufficient space, please use separate sheet) (註:如空位不足,請另紙列出)



Ref. No.:		
當案編號:		

Application Form for Inclusion in the CIC Vendor List

建造業議會承辦商/供應商登記申請書

	<u> </u>		V (70) 1
	Please provide names of your major clients / customers for our internal re	eference	e purposes.
	請提供貴公司的主要客戶名稱,作內部參考之用。		
(1)		(2)	
(3)		(4)	

PART IV - DOCUMENTS TO BE SUBMITTED 第四部 - 須提交證明文件清單

Type 1 - Supplier (類別一 - 供應商)

Please attach a copy of the valid Business Registration Certificate for our reference and record.

請寄交有效的商業登記證文件副本以供參考和存照。

(ii) Please attach one set of relevant product / service catalogue(s) for our consideration.

請夾附最少一份有關產品/服務目錄以供參閱。

Type 2 - Construction Contractor (類別二 - 建築工程承辦商)

i) Please attach a copy of the valid Business Registration Certificate for our reference and record.

請寄交有效的商業登記證文件副本以供參考和存照。

(ii) Please attach one set of relevant product / service catalogue(s) for our consideration.

請夾附最少一份有關產品/服務目錄以供參閱。

(iii) Please attach company profile

請夾附公司簡介

(iv) Please attach past 2 years financial report

請夾附最近兩年之財務報表

(v) Please attach the past 3 years relevant job reference with the contract amount for each selected category(s)

請夾附最近三年每個選定類別之相關工作參考及合同金額

(vi) Please attach relevant construction works licence(s)

請夾附有關工程牌照

(vii) Please attach Quality Assurance policy

請夾附質量保證政策

(viii) Please attach Health and Safety policy

請夾附健康及安全政策

(ix) Please attached Quality Management System certification(s) (if any)

請夾附品質管理系統認證 (如有)

(x) Reference/ Appreciation Letter(s) (if any)

請夾附參考/感謝信(如有)



Ref. No.:		
當案編號:		

Application Form for Inclusion in the CIC Vendor List

建造業議會承辦商/供應商登記申請書

PART V - CERTIFICATION 第五部 - 證明

(i) Personal Information Collection Statement 收集個人資料聲明

- (1) CIC will use the provided information for the purpose of processing this registration form and dealing with our procurement-related matters. 提供的資料會用作本議會處理有關申請登記成為本議會之承辦商/供應商及與採購相關的事宜。
- (2) Under the provisions of the Personal Data (Privacy) Ordinance, you have the right to request access to or correction of personal data. Written requests should be addressed to CIC. 根據個人資料(私隱)條例,你有權要求查閱和更改個人資料,有關申請須以書面向本議會提出。
- 似脉凹八臭性(心感)脉内,脉为惟安小旦烟仰天以凹八臭性,为阙中明须以盲凹

 3) CIC will not be able to process and consider incomplete forms
- (3) CIC will not be able to process and consider incomplete forms. 如果資料有任何遺漏,本議會將不能處理本表格事宜。

(ii) Declaration 聲明

- (1) I declare that all information given in this registration form is, to the best of my knowledge, accurate and complete. If any false information is given, the application is deemed to be invalid and I shall forfeit my right to submit quotations and tender.
 - 本人聲明本表格內所提供的一切資料,依本人所知均屬真確,並知道倘若虛報資料,申請即屬無效,且喪失其後落標資格。
- 2) I agree that if registered, I will conform to the regulations, terms and conditions set by the CIC. 本人同意如本人註冊成為建造業議會之承辦商/供應商,當遵守建造業議會之工作守則。
- (3) I declare that our company as stated in this form shall uphold the highest ethical principles in relation to our procedures as well as having a corrupt free environment in rendering of goods and services to the CIC operations including compliance with all applicable laws and regulations, maintaining confidentiality where appropriate, adopt an open and fair competition, anti-bribery and corruption.
 - 本人聲明本申請書上的公司會在運作過程中堅守道德原則,並在廉潔的環境下向建造業議會提供貨品及服務,包括遵守所有適用法例及規則、保密原則、防賄法例、反貪法例,以及維護公開公平的競爭。

I apply on behalf of the aforementioned company for inclusion in the CIC Vendor List. 太人謹代表上述公司,由請登記成為建裝業議會承辦商/供應商。

八硅八代工是五百 中明显的风凉定		
	Signature: 簽署:	
	Name in block letters: 姓名(正楷):	
	Designation: 職銜:	
(Space for company chop) (公司印鑑)	Date: 日期:	



Ref. No.:	
當案編號:	

Application Form for Inclusion in the CIC Vendor List

建造業議會承辦商/供應商登記申請書

DOCUMENT CHECKLIST 文件核對表

Please en	closed the following items (請夾附以下文件):
	Supplier (類別一 - 供應商) Completed application form for inclusion in the CIC Vendor List (Form PRO-01) 已填妥建造業議會承辦商/供應商登記申請書
	Copy of valid Business Registration Certificate 有效的商業登記證文件副本 Relevant product / service catalogue(s) 有關產品 / 服務目錄
Type 2 -	Construction Contractor (類別二 - 建築工程承辦商)
	Completed application form for inclusion in the CIC Vendor List (Form PRO-01)
	已填妥建造業議會承辦商/供應商登記申請書
	Copy of valid Business Registration Certificate
	有效的商業登記證文件副本
	Relevant product / service catalogue(s)
_	有關產品/服務目錄
	Company profile
_	公司簡介
	Past 2 years financial report
_	最近兩年之財務報表
	Past 3 years relevant job reference with the contract amount under each selected item category(s)
_	最近三年每個選定類別之相關工作參考及合同金額
	Relevant construction works licence(s)
_	有關工程牌照
	Quality Assurance policy
_	健康及安全政策
	Health and Safety policy
_	質量保證政策
	Quality Management System certification(s) (if any)
_	品質管理系統認證 (如有)
	Reference/appreciate letter(s) (if any)
	參考/感謝信 (如有)
	ase put a "✓" in the box under each column to indicate that the document has been enclosed. :請在欄內方格加上「✓」號以示已附上該文件。

Tender Documents

for

Fitting Out Works for the

Construction Innovation and Technology

Application Centre (CITAC)

for

the Construction Industry Council

Employer

Construction Industry Council 38/F, COS Centre 56 Tsun Yip Street Kwun Tong, Kowloon

May 2017

Fitting Out Works for the Construction Innovation and Technology Application Centre (CITAC) for the Construction Industry Council

List of Tender Documents

1.	Conditions of Tender	Page CT-1
2.	Appendices to Conditions of Tender	
	Appendix A - Details for Submission of Tender	CT-10
	Appendix B - Standard Letter for Complying with Anti-Collusion Clause	CT-14
	Appendix C - Form of Tender	CT-16
	Appendix D - Fee Proposal	CT-18
	Appendix E - Tender Evaluation Procedures and Criteria	CT-71
	Appendix F - Reply Slip for Tender Briefing and Site Visit Session	CT-74
	Appendix G - Reply Slip for Declining Bid	CT-75
3.	Special Conditions of Tender	SCT-1 to SCT-3
4.	Assignment Brief and its Annexes	AB-1 to AB-270
5.	Memorandum of Agreement	MA-1 to MA-3
6.	General Conditions of Employment	CE-1 to CE-26
7.	CIC's General Conditions of Contract and Guidelines for Works or Services (2h) - CAR	8 Pages

Conditions of Tender

for

Fitting Out Works for the Construction Innovation and Technology Application Centre (CITAC)

for the Construction Industry Council

Table of Contents

Cla	nuse	Page
1	Notes to Tenderers	CT-2
2	Invitation	CT-2
3	Tenderers' Response to CIC Enquiries	CT-2
4	Completion of Tender	CT-3
5	Tender Briefing and Site Visit Session	CT-7
6	Tender Interview	CT-7
7	Tender Evaluation	CT-7
8	Tenderer's Commitment	CT-8
9	Amendments	CT-8
10	Award of Contract	CT-8
11	Rights to Exercise	CT-9
12	Submitted Documents	CT-9
13	Enquiries	CT-9
AP	PENDIX A – Details for Submission of Tender	CT-10
AP	PENDIX B – Standard Letter for complying with Anti-Collusion Clause	CT-14
AP	PENDIX C – Form of Tender	CT-16
AP	PENDIX D – Fee Proposal	CT-18
AP	PENDIX E – Tender Evaluation Procedures and Criteria	CT-71
AP	PENDIX F - Reply Slip for Tender Briefing and Site Visit Session	CT-74
AP	PENDIX G - Reply Slip for Declining Bid	CT-75

1 Notes to Tenderers

- 1.1 All tenderers shall read the instructions contained in this Conditions of Tender carefully prior to preparing their tender submissions. Any tender submission, which does not follow these instructions is deemed to be incomplete and may be disqualified.
- 1.2 The tender documents consist of:
 - a) Conditions of Tender;
 - b) Appendices to Conditions of Tender;
 - c) Special Conditions of Tender;
 - d) Assignment Brief and its Annexes;
 - e) Memorandum of Agreement;
 - f) General Conditions of Employment;
 - g) CIC's General Conditions of Contract and Guidelines for Works or Services (2b) CAR

2 Invitation

- 2.1 Tenderers are invited by the Construction Industry Council (hereinafter referred to as the "CIC") to submit proposal and bid for Fitting out works for the Construction Innovation and Technology Application Centre (CITAC) at the CIC's Kowloon Bay Centre (KBC). Further details are given in the **Assignment Brief and its Annexes**.
- 2.2 The tender shall be submitted in accordance with the **Conditions of Tender**.
- 2.3 If the tender is accepted and the contract is awarded, the tender documents specified in Clause 1.2 above, the tender proposal submitted by the tenderer and other relevant contract correspondence as agreed by the tenderer and CIC will form part of the contract.

3 Tenderers' Response to CIC Enquiries

3.1 In the event that the CIC determines that clarification of any tender is necessary, it will advise the tenderer to supplement its tender. Unless otherwise specified in the request for clarification, the tenderer shall thereafter have 3 working days to submit such requested information. Any clarification made shall be at the tenderer's own cost and expense.

4 Completion of Tender

- 4.1 The tenderer is required to submit all information specified in **Appendix A** of the Conditions of Tender and the **Special Conditions of Tender** with his tender. In addition, the tenderer shall submit with his tender a duly signed and witnessed letter in the form set out in **Appendix B** of the Conditions of Tender. Should the tenderer fails to submit this letter with his tender, his tender will not be considered.
- 4.2 If CIC's participation is required, the tenderer should clearly state the details and the expected resources, skills, level of participation, responsibilities, and duration.
- 4.3 The tenderer shall state in his proposals the implementation plan of delivering the deliverables as described in the **Assignment Brief and its Annexes**.
- 4.4 The tenderer must submit his offer in Hong Kong Dollars. **OFFERS SUBMITTED IN OTHER CURRENCIES SHALL NOT BE CONSIDERED.**
 - a) The tenderer is required to submit the completed **Form of Tender as per Appendix C** of the Conditions of Tender.
 - b) In addition, the tenderer is required to submit **the Fee Proposal** using the prescribed form provided in **Appendix D** of the Conditions of Tender. There shall be no adjustment for any price fluctuations; and
 - c) The tenderer should ensure that the fee quoted is accurate before submitting the tender. Under no circumstances will the CIC accept any change of quoted lump sum fee on the ground that a mistake has been made in the tender price.
- 4.5 A two-envelope approach is adopted for tender submission, i.e. the tenderers should submit all information specified in **Appendix A** of the Condition of Tender and the Special Conditions of Tender, and the letter annexed in **Appendix B** and mentioned in Clause 4.28 of the Conditions of Tender (collectively known as "technical proposal") in one envelope and the completed Form of Tender using the prescribed form provided in **Appendix C** of the Conditions of Tender and the Fee Proposal using the prescribed form provided in **Appendix D** of the Conditions of Tender (collectively known as "fee proposal") in a separate envelope. Failure to do so will render the tender void.
- 4.5 The tenderer shall submit FIVE (5) hard copies and corresponding files in electronic form (e.g. in MS Word 2003 / MS Excel 2003 / PDF format) stored in an electronic medium (e.g. CD-ROM) of the technical proposal in a sealed envelope marked "Technical Proposal" and TWO (2) hard copies of the fee proposal in a separate sealed envelope marked "Fee Proposal" clearly indicating the tenderer's name and tender title. In the event of discrepancies between original and electronic versions of the Tender Submission, the former shall

prevail.

- 4.6 Tender should be submitted to the Tender Box of CIC at **38/F**, **COS Centre**, **56 Tsun Yip Street**, **Kwun Tong**, **Kowloon** by 12:00 noon on **9 June 2017**. Late submission will NOT be considered. Failure to do so shall render the tender void.
- 4.7 In the event that a Typhoon Signal No. 8 or above or Black Rainstorm Warning is hoisted on the tender closing date, the tender closing time will be postponed to 12:00 noon on the following working day.
- 4.8 The CIC will not reimburse any cost incurred by tenderers for the preparation and submission of the tender.
- 4.9 The CIC may reject a tender which is unreasonably low in terms of price and may therefore affect the tenderer's capability in carrying out and complete the services and delivering the deliverables in accordance with the Assignment Brief and its Annexes.
- 4.10 Any amendments to the rates offered must be signed by the person who signs the tender. Failure to do so will render the tender null and void.
- 4.11 Unless otherwise stated, tenders shall be valid for 120 days from the specified closing date. If no letter of acceptance or order is placed within the validity period of the offer, the tenderer may assume that the offer has not been accepted.
- 4.12 This is an invitation to offer. The CIC is not bound to accept the lowest tender or the highest combined scores under the technical and fee proposal or any tender. The CIC reserves the right to accept or omit any individual item or whole section of a tender without price alteration to the items or sections accepted. The tenderer hereby acknowledges that there will not be any loss of profit claim as a result of the reduction in the scope of works.
- 4.13 The CIC reserves the right to negotiate with any or all tenderer(s) on the terms of the tender.
- 4.14 Tenderer should ascertain the prices quoted are accurate before submitting his tender. Under no circumstances will the Employer accept any request for price adjustment due to any mistake made in the tender prices.
- 4.15 The CIC shall have the right, in its absolute discretion, to disclose to any person and for any purpose, any information submitted to the CIC as part of the tender or otherwise in connection with the awarded contract, without further notification to the successful tenderer. In submitting the tender, the tenderer irrevocably consents to such disclosure.
- 4.16 In the event that a tenderer discovering a genuine error in his tender after it has been deposited, he may in writing draw attention to the error and submit amendment which may be accepted, provided that the amendment has been deposited on or before the closing time fixed for the receipt of tenders.
- 4.17 The tendered sum will be regarded as a lump sum tender and will not be amended for errors found in the examination of tenders.

- 4.18 Should examination of a tender reveal errors of such magnitude as in the opinion of the CIC would involve the tenderer in serious loss then the nature and amount of such errors will be communicated to the tenderer and he will be asked to confirm in writing that he is prepared to abide by his tender.
- 4.19 The tenderer shall be required to check the numbers of the pages of the tender documents against the page numbers given in the contents. If the tenderer finds any missing, in duplicate or indistinct, he must inform the CIC at once and have the same rectified.
- 4.20 Should the tenderer for any reason whatsoever be in doubt as to the precise meaning of any item or description, he must inform the CIC in order that correct meaning may be decided before the date for submission of tender.
- 4.21 Tenderer shall inspect the Site and make themselves thoroughly acquainted with the existing condition of the premises, location, the existing structure / accessibility, restrictions for loading and unloading materials, and all the materials, and all other aspects which may affect the delivery of the deliverables. Tenderer shall make due and proper allowance when estimating their rates and prices for the information obtained or which ought to have been obtained during the site inspection.
- 4.22 No liability will be admitted, nor claim allowed in respect of errors in the tenderer's tender due to mistakes in the tender documents which should have been rectified in the manner described above.
- 4.23 Tenderer shall be deemed to be in possession of a valid business registration certificate and, if necessary, be registered with the relevant authority authorizing him to carry out the works described in the tender documents.
- 4.24 Tenderer shall comply with the CIC's General Conditions of Contract and Guidelines for Works or Services. The tender price shall deem to be included all cost incurred.
- 4.25 Any qualification of tender or of the tender documents may cause the tender to be disqualified.
- 4.26 No unauthorized alteration or erasure to the text of the tender documents will be permitted. Any tender containing such alteration or erasure may not be considered.
- 4.27 The tenderer shall strictly comply with the following anti-collusion clause:
 - (1) (a) Subject to sub-clause (2) of this Clause, the tenderer shall not communicate to any person other than the CIC the amount of the tender price or any part thereof until the tenderer is notified by the CIC of the outcome of the tender exercise.
 - (b) Further to paragraph (a) of this sub-clause, the tenderer shall not fix the amount of the tender price or any part thereof by arrangement with any

other person, make any arrangement with any person about whether or not he or that other person will or will not submit a tender or otherwise collude with any person in any manner whatsoever in the tendering process.

- (c) Any breach of or non-compliance with this sub-clause by the tenderer shall, without affecting the tenderer's liability for such breach or non-compliance, invalidate his tender.
- (2) Sub-clause (1)(a) of this Clause shall have no application to the tenderer's communications in strict confidence with:
 - (a) his own insurers or brokers to obtain an insurance quotation for computation of tender price;
 - (b) his consultants or sub-contractors to solicit their assistance in preparation of tender submission; and
 - (c) his bankers in relation to financial resources for the Contract
- (3) The tenderer shall submit with his tender a duly signed and witnessed letter in the form set out in Appendix B of the Conditions of Tender. The signatory to the letter shall be a person authorized to sign CIC contracts on the tenderers's behalf.
- (4) The tenderer shall indemnify and keep indemnified the CIC against all losses, damages, costs or expenses arising out of or in relation to any breach of or non-compliance with sub-clause (1) of this Clause by the tenderer, including but not limited to additional costs due to price escalation, costs and expenses of re-tendering and other costs incurred.
- 4.28 The tenderer shall not and shall ensure that his agents and employees shall not give or offer any advantages as defined under the Prevention of Bribery Ordinance to any agent or employee of CIC. Any breach of the clause by the tenderer shall, without affecting the tenderer's liability for such breach, invalidate his tender.
- 4.29 The tenderer who has decided to decline the bid shall return the Reply Slip for Declining Bid provided in **Appendix G**.

5 Tender Briefing and Site Visit Session

- 5.1 Tenderer is invited to attend a tender briefing session and site visit at the time and place as stated in the tender invitation. Interested tenderers should e-mail to the Subject Officer at least TWO (2) working days before the stated time confirming the attendance of the said briefing session and site visit and state clearly the number of attendees for CIC's arrangement.
- 5.2 The CIC may record the queries raised by the tenderers attending the tender briefing and may issue a Replies to Tender Queries to all tenderers for information.

6 Tender Interview

- 6.1 During the tender evaluation stage, the tenderer is requested to attend a tender interview which will be held on <u>14 June 2017</u> to present his tender proposals. Upon receipt of a request from the CIC, the tenderer shall provide a tender presentation to demonstrate whether the proposal can fulfill the requirements specified in the Assignment Brief and its Annexes.
- 6.2 The presentation shall be set up with the tenderer's own resources and expense. The CIC shall not bear any costs associated with the presentation.
- 6.3 The presentation should at least include the project team profile, the approach to fulfill the objectives described in the Assignment Brief and its Annexes and an outline programme for completing the assignment. The presentation shall be conducted, where possible, by the leader of the proposed project team for performing the project management.
- 6.4 Each interview presentation should be no longer than 15 minutes, including a 5 minute questions and answers session.

7 Tender Evaluation

7.1 Tenderers shall note that their tender proposals, presentations and responses to CIC's queries in connection with the tender will be assessed in accordance with **the tender evaluation procedures and criteria** specified in **Appendix E** of the Conditions of Tender.

8 Tenderer's Commitment

- 8.1 All information and responses from the tenderer must be submitted in writing. The relevant provisions of this invitation to tender and such documents so submitted shall be the representation of the tenderer and may be incorporated into and made part of the Contract between the CIC and the successful tenderer.
- 8.2 The CIC reserves the right to disqualify any tender that directly or indirectly attempts to preclude or limit the effect of the requirements as mentioned on the Assignment Brief and its Annexes.
- 8.3 Tender shall remain valid and open for acceptance for **120 days** after the tender closing date.

9 Amendments

- 9.1 The CIC reserves the right to amend or withdraw the Assignment Brief and its Annexes before acceptance of a tender.
- 9.2 The CIC may issue Tender Addendum and / or Replies to Tender Queries no later than 7 days before tender closing if CIC found it necessary.

10 Award of Contract

- 10.1 The successful tenderer will receive a letter of acceptance as an official notification of acceptance. Unless and until a formal contract agreement is prepared and executed, this letter of acceptance together with the tender submission shall constitute a binding contract between the successful tenderer and the CIC. Tenderers who do not receive any notification within the validity period of their offer shall assume that their tenders have not been accepted.
- 10.2 The CIC reserves the right of not awarding the contract after receipt of submissions by the tenderer.
- 10.3 In order to ensure the fairness of the tender process, all answers to tender queries / tender clarifications and tender addendums will be uploaded to CIC's website. All tenderers have to take note of this arrangement. Any claim for extension of time or additional payment due to ignorance of this clause shall not be entertained by the CIC.

11 Rights to Exercise

11.1 The CIC may, at any time during the contract period by notice of writing, direct the Contractor to alter, amend, omit, add to, or otherwise vary any of the work items stated in the Contract and/or works required as specified by the CIC, and the Contractor shall carry out such variations. The contract sum will be adjusted all in accordance with the relevant provisions specified else in the tender documents and/or works required as specified by the CIC.

12 Submitted Documents

12.1 All submitted documents will not be returned.

13 Enquiries

13.1 In case the tenderer has any tender enquiries or/ and tender clarification queries, he should submit in writing to the procurement department with details as below:-

Mr. Kelvin LEE Senior Officer - Management Support Construction Industry Council 38/F, COS Centre, 56 Tsun Yip Street,

Kwun Tong, Kowloon Tel: (852) 2100-9425

Fax: (852) 2100-9439 Email: kelvinlee@cic.hk

APPENDIX A – Details for Submission of Tender

To be included in Technical Proposal

The tenderer is required to provide all details as described therein.

1. Tenderer's Staff Resources

1.1 Organization of Proposed Project Team

- 1.1.1 The tenderer shall submit:
 - (a) Company's profile, background and expertise;
 - (b) An organization chart indicating the proposed project team structure and strength of the proposed project team. The project team shall include members who have experience in supplying the Deliverables as outlined in the Assignment Brief and its Annexes.

1.2 Qualifications of Proposed Project Team Members

- 1.2.1 The project team members shall possess the required qualifications, professional knowledge and relevant experience to supply the Deliverables as outlined in the Assignment Brief and its Annexes.
- 1.2.2 The project team proposed in the tender submission shall form part of the Agreement. The tenderer shall provide the details included but not limited to the following information of proposed project team members in the tender submission:
 - a) Name
 - b) Post / Title in this Project
 - c) Core Team Member (Yes/No)
 - d) Language (Chinese/English/Both)
 - e) Project knowledge and Years of Relevant Experience
 - f) Oualifications
 - g) Duties and Responsibilities in the Assignment

2. Tenderer's Track Record & Project Reference

- 2.1 The tenderer is required to provide a full list of project references undertaken in the past 5 years (as of the tender closing date) for projects similar to this Assignment, giving the details by adhering to the submission format as specified in Section 2.2 below.
- 2.2 The tenderer shall submit a list of <u>relevant project references</u> in the following format with support of copies of job references or recommendation letters from previous clients.

Brief Project Description	Scope of Services	Client	Contract Value (in HK\$)	Duration	Year

- 2.3 In case the tenderer is unable to disclose of track record and project reference due to the signing of confidentiality agreement with its previous clients, please specify in the tender submission accordingly. In this circumstance, the tenderer will be asked to describe this information to the Assessment Panel during the tender interview.
- 2.4 The tenderer shall submit a list of proposed AV contractors / suppliers with support of copies of job references and Letters of Undertakings with the tenderers.

3. Project Approach and Requirements

- 3.1 The tenderer is required to submit the following to demonstrate his capabilities in fulfilling the project approach and technical requirements and to present all the deliverables outlined in the Assignment Brief and its Annexes:-
- (i) **Tender Programme** shall be in the form of a linked bar chart identifying the critical path and included but not limited to the following activities:
 - (a) Procurement Activities purchase order, manufacturing period, testing and delivery, particularly for the items with long lead time.
 - (b) Construction Activities key elements of the construction including equipment installation, testing and commissioning and handover procedure.
 - (c) Maintenance Activities maintenance activities, which will be carried out under the Contract during the Defects Liability Period (DLP).

- (ii) A completed **Method Statement** must be submitted to demonstrate a full understanding of the Assignment, the method statement should included but not limited to the followings:-
 - (a) Access to the Site for materials delivery;
 - (b) Approach to undertaking the Assignment;
 - (c) Maintaining access and existing fire escape routes clear during the Works:
 - (d) Noise, vibration and dust control during the Works to minimise disruption;
 - (e) Installation of temporary services and service diversions to ensure that areas outside of the works area remain in use during the project and procedures for third party liaison;
 - (f) Approach to the Completion of the Project;
 - (g) Site Waste Management Plan.
- (iii) **Health and Safety**. The Tenderer shall include the following:-
 - (a) Nominations with CV's of personnel to be responsible for implementing the Health and Safety Policy and whether they are site-resident or on a visiting basis;
 - (b) A diagram showing reporting responsibilities and method by which any conflicts of interest between Health and Safety and other project objectives and restrictions will be resolved;
 - (c) Accident statistics covering a period of two years to date, inclusive of subcontracted labour with the method of calculation and definitions clearly shown.
- 3.2 The tender shall refer to the other requirements laid down in the Assignment Brief and its Annexes of the tender document.

4. Documents and Information to be submitted by the Tenderer

4.1 The tenderer is required to provide the following documents and information as described in the tender documents:

	Particulars	Reference		
Techni	ical Proposal			
1. Org	ganisation of Proposed Project nm	Conditions of Tender, Appendix A Clause 1.1		
2. Qua	alifications of Proposed Project	Conditions of Tender, Appendix A Clause 1.2		
	nderer's Track Record & Project ference	Conditions of Tender, Appendix A Clause 2.1, 2.2, 2.3 and 2.4		
(i) and out	proach and Work Programme to fulfill the technical requirements I (ii) deliver all deliverables lined in the Assignment Brief and Annexes	Conditions of Tender, Appendix A Clause 3.1		
	duly completed Standard Letter for mplying with Anti-Collusion Clause	Conditions of Tender, Appendix B		
Cor Gu	duly signed CIC's General nditions of Contract and idelines for Works or Services o)-CAR	CIC's General Conditions of Contract and Guidelines for Works or Services (2b)-CAR		
Tec	documents mentioned in the chnical Assessment Marking neme	Conditions of Tender, Appendix E		
Cap Our Wo Ger	tements of Convictions under p. 115, Cap. 59 and Cap. 57, tline Health & Safety Plan, Minor orks Contractor Registration or neral Building Contractor gistration	Special Conditions of Tender		
Fee Pr				
9. For	rm of Tender	Conditions of Tender, Appendix C		
10. Fee	e Proposal	Conditions of Tender, Appendix D		

(ii)

APPENDIX B – Standard Letter for complying with Anti-Collusion Clause

Date:	Const	ruction indust	try Councii (t	CIC)	Т	To be incluin Echnical Pr	
Dear Sir/Mad	am,						
	Tend	er Ref:	(302)	in P/AE/PUR/AGO			
	Tender			or the Construction ion Centre (CITAC			
	*[I/V	We], [(name of the tenderer)] of
(address of the	tenderer)] ¹ ,
refer to *[my/	our] tend	der for the abo	ove Contract.				
fully understa	=	_	·	[I/We] sign this lett clause in Condition		_	
Contract:	*[I/V	We] represent	and warrant	that in relation to	the ter	nder for the al	bove
	(i)	last paragr communic tender pric	raph of this cate to any par	Expected Commur letter, have not co erson other than the thereof until *[I/V of the tender exerce	mmunic ne CIC We] hav	cated and will the amount of	l not f the

price or any part thereof by arrangement with any person;

*[I/We] have not fixed and will not fix the amount of the tender

(iv) *[I/We] have not otherwise colluded and will not otherwise collude with any person in any manner whatsoever in the tendering process.

*[I/We] shall indemnify and keep indemnified the CIC against all losses, damages, costs or expenses arising out of or in relation to any breach of any of the representations and/or warranties above, including but not limited to damages for delay, costs and expenses of re-tendering and other costs incurred.

In this letter, the expression "Expected Communications" means *[my/our] communications in strict confidence with:

- (i) *[my/our] own insurers or brokers to obtain an insurance quotation for computation of tender price;
- (ii) *[my/our] consultants or sub-contractors to solicit their assistance in preparation of tender submission; and
- (iii) *[my/our] bankers in relation to financial resources for the Contract.

Signed for and on behalf of [
	name of the tenderer	
by [name and position of the signatory]2
Name of Witness:		
Signature of Witness:		
Occupation:		

Note:

- * Delete as appropriate
- 1. Where the tenderer comprises two or more persons or companies acting in partnership, joint venture or otherwise, this part in square brackets should be expanded to include the respective names and addresses of such persons or as the case may be companies.
- 2. Where the tenderer comprises two or more persons or companies acting in partnership, joint venture or otherwise, all such persons or as the case may be companies must sign. The signatory for each of such persons or companies shall be a person authorised to sign CIC contracts on behalf of that person or as the case may be company.

Conditions of Tender

APPENDIX C – Form of Tender

To be included in Fee Proposal

FORM OF TENDER FOR

FITTING OUT WORKS FOR THE CONSTRUCTION INNOVATION AND TECHNOLOGY APPLICATION CENTRE (CITAC) FOR THE CONSTRUCTION INDUSTRY COUNCIL

To: Construction Industry Council 38/F, COS Centre, 56 Tsun Yip Street, Kwun Tong, Kowloon

Dear Sirs,

1.	Having examined the Conditions of Tender, Appendices to Conditions of Tender,
	Special Conditions of Tender, Assignment Brief and its Annexes, Memorandum
	of Agreement, General Conditions of Employment and CIC's General Conditions
	of Contract and Guidelines for Works or Services (2b-CAR) thereto for the
	execution of the above named Services, we offer to execute and complete the
	whole of the said Services in conformity with the said Conditions of Tender,
	Appendices to Conditions of Tender, Special Conditions of Tender, Assignment
	Brief and its Annexes, Memorandum of Agreement, General Conditions of
	Employment and CIC's General Conditions of Contract and Guidelines for
	Works or Services (2b-CAR) and the tender proposals submitted herewith within
	62 Calendar Days including Sundays and Public Holidays from the date of
	contract awarded and for the sum of Hong Kong
	Dollars
	(HK\$)
	(not being subject to fluctuations in labour and material costs) or such sums as
	may be ascertained in accordance with the Conditions of Employment.

- 2. We agree to abide by this tender and not to withdraw it for a period of 120 days from the date fixed for receiving it and including that date and it shall remain binding upon us and may be accepted at any time before the expiration of that period.
- 3. Unless and until a formal agreement is prepared and executed, this tender together with your written acceptance thereof subject to the provisions of Clause 2 hereof shall constitute a binding Contract between us.
- 4. We understand that you are not bound to accept the lowest or any tender you may receive.

Signature	
In the capacity of	
Duly authorized to sign tenders for and on	behalf of *
Registered Address of the Firm	
Date	
Witness	
Address	
Occupation	
Date	
Business Registration Certification No	
Name of Partner(s)	Residential Address of Partner(s)

* In the cases of a (a) Limited Company or (b) Partnership or unincorporated body, (a) the name of the Company or (b) the name(s) of the partner(s) must be inserted in the space provided above.

Conditions of Tender

APPENDIX D - Fee Proposal

To be included in Fee Proposal

FEE PROPOSAL

FOR

FITTING OUT WORKS FOR THE CONSTRUCTION INNOVATION AND TECHNOLOGY APPLICATION CENTRE (CITAC) FOR CONSTRUCTION INDUSTRY COUNCIL

The Contractor shall be paid a Lump Sum* fee of HK\$
for the provision of all services and all expenses incurred in connection with the carrying out
and satisfactory completion of the Assignment as detailed in the Assignment Brief and its
Annexes.

The tenderer shall enclose with his tender the completed Schedule of Rates as below:

- (1) The Schedule of Rates shall be in sufficient details to indicate the breakdown of the works. Failure to submit the Schedule of Rates may cause his tender not to be considered by the Employer.
- (2) Any items which are not included in the Schedule of Rates but shown on the Drawings or described in the specifications under the tender document shall be deemed to have been included in the tender figures.
- (3) Upon award of the Contract, the Schedule of Rates shall be deemed to be the Contractor's Schedules and will be regarded as firm and will not be subject to re-measurement or adjustment whatsoever otherwise than in accordance with the expressed provisions of the terms of the Contract.
- (4) The total of the Schedule must agree with the amounts carried to the Summary of Tender. Any items which are not included in the Schedule but shown on the Drawings or described in the specifications under the tender documents shall be deemed to have been included in the tender figures. The rates in the Schedule shall be used for the valuation of variations ordered by the Employer, but the quantities Referred to in the Schedule shall not form part of the Contract Documents.
- (5) The tenderer should note that the quantities as inserted in the Schedule of Rates for all measured work should be consistent with those shown on the tender Drawings and the Drawings to be prepared and provided by the tenderer. Where large discrepancy or apparent inconsistency in the quantity of any item is identified, the item total will remain intact and the tenderer will be requested to adjust the unit rate and the quantity to tally with the item total.

* The lump sum fee is subject to re-measurement where the quantities of the items in the Schedule of Rates are subject to final measurement upon the completion of the Works. Any addition / deduction in the total sum will be based on the unit rate as quoted in the Schedule of Rates.

Table 1 - Detailed breakdown of tender price

Section	Description of Deliverables	Amount (HK\$)
1	Preliminaries	
2	Demolition	
3	Builders Work	
4	Flooring & Floor Finishes	
5	Ceiling Finishes	
6	Partitioning & Wall Finishes	
7	Built-in Joinery	
8	Doors & Ironmongeries	
9	Fitting & Fixtures (Sanitary Ware)	
10	Fire Services	
11	Air Conditioning Modification Work	
12	Electrical Work	
13	Plumbing & Drainage Work	
14	Service Charge for Obtaining BEAMS Gold	
	Level	
15	IT Network Cabling	
16	Security System	
17	AV System	
18	Loose Furniture	
19	Light Fitting	
20	Lighting Control System	
21	Contingency Sum Contingency to be expended in whole or in part as directed by Project Consultant or wholly deducted from the contract sum if not required.	800,000.00
	Total (Mandatory Items):	

Upon receipt and acceptance of the Deliverables for each Payment Stage / Date by the CIC with satisfaction and upon the submission of invoices to the CIC by the Contractor, the Contractor shall be paid in accordance with the following payment schedule within 30 days of the receipt of the invoices subject to verification of the invoice.

Fitting Out Works for the Construction Innovation and Technology Application Centre (CITAC) for the CIC Ref. (302) in P/AE/PUR/AGC

The Schedule of Rates against which items of work are described shall not be regarded as a complete statement of everything included in the Contract. The tender must include all works shown on the tender Drawings or described in the specifications as a whole apparent as being necessary for the complete and proper execution of the Works.

The quantities specified in the Schedule of Rates are provisional quantities only and the Contractor shall be fully responsible for the accuracy of the quantities set out in the Schedules of Rate.

Provisional sums and quantities are subject to final measurement and approval of the CIC and its Consultant. Any addition and deduction in the total sum will be based on the rate as quoted

Schedule of Rates

Section 1 - Preliminaries

Item	Description	Provisional Quantity	Rate (HK\$)	Amount (HK\$)
1.01	The preliminary items included hereunder apply to the	1 SUM	(ППСФ)	(111ΧΦ)
1.01	whole of the works contained in the Tender Documents	1 50111		
	and the rates and/or amounts inserted shall be deemed to			
	apply to the whole of the works carried out under this			
	Contract including all variations to the Contract.			
1.02	The Contractor shall be deemed to have allowed in his	1 SUM		
	tender for all costs in respect of all items described in the			
	Preliminaries Specification and for full compliance with			
	the Preliminaries Specification requirements.			
1.03	In the absence of any sum against any item or items any	1 SUM		
	monetary cost attributable thereto shall be deemed to be			
	included elsewhere in this Preliminaries Schedule or in the			
	unit rates for the work.			
1.04	Any price entered in this Preliminaries Schedule shall be at	1 SUM		
	the risk of the Contractor and no adjustment will be made			
	at the settlement of accounts.			
1.05	The Contractor will provide full access to the site in	1 SUM		
	accordance with the Preliminaries Specification.			
1.06	The Contractor shall allow for suitable off-site fabrication,	1 SUM		
	manufacture and storage of material and equipment.			
1.07	The Contractor shall allow for fully protect any lift cars	1 SUM		
	including the doors.			
1.08	All workers employed by the Contractor and his	1 SUM		
	Sub-contractors for this project shall sign-in, with the			
	Client's Security Office and the General Contractors Site			
	Supervisor before access to the Site and sign-out when			
	they leave the Site.			

Τ.	David d	Provisional	Rate	Amount
Item	Description	Quantity	(HK\$)	(HK\$)
1.09	The Contractor shall allow to dub-out, finish out and make	1 SUM		
	good all surfaces of walls, ceilings, floors, etc. as			
	necessary to allow his Works to be carried out in a proper			
	manner to the highest standard of workmanship.			
1.10	The Contractor shall include for keeping on Site a	1 SUM		
	complete set of Up to Date Contract Drawings and			
	Specification(s). In addition, copies of all Variation Orders			
	and additional drawings issued after the Date of			
	Commencement shall be available on the Site at all time			
	for reference by the Project Manager.			
	The drawings shall be stored in a neat and orderly manner.			
1.11	The Contractor is to allow for the preparation of all	1 SUM		
	necessary shop drawings. Three print and one electronic			
	copy of each drawing shall be submitted by the Contractor			
	within 3 days, unless otherwise stated, upon request by the			
	Project Manager.			
1.12	The Contractor shall allow for the preparation of	1 SUM		
	specimens of colors, finishes, etc. for the Project			
	Manager's approval before proceeding with the work and			
	shall allow sufficient time and at his own expenses for the			
	preparation of sample panels as listed in Technical			
	Specification or as identified on Drawings or other design			
	documentation for approval by the Project Manager.			
1.13	The Contractor shall allow in the unit rates for all tests that	1 SUM		
	may be required by the Project Manager, the Specification			
	or Building Authorities including all costs of carrying out			
	the tests, notwithstanding successful or not, and all other			
	costs and expenses in connection with tests such as			
	additional material and labor, transport to laboratory etc.			
1.14	The Contractor shall allow for the preparation and	1 SUM		
	submission to the Project Manager at weekly intervals			
	comprehensive reports on the detailed progress of the			
	Works including that of his Specialist Sub-Contractors,			
	Contractors and other contractors employed direct by			
	Employer			

Items	Description	Provisional	Rate	Amount
Items	Description	Quantity	(HK\$)	(HK\$)
1.15	The Contractor shall submit to the Project Manager	1 SUM		
	each day throughout the Contract Period a report			
	showing a record of the labor employed on Site under			
	each trade, materials delivered to Site, plant and			
	equipment on Site, etc.			
1.16	The Contractor shall allow for all attendance and	1 SUM		
	overall co-ordination of all Works. The Contractor			
	shall make allowance in his Contract Sum for all			
	necessary co-ordination and integration of his Works			
	with works by others including, but not limited to,			
	works, carried out by all Specialist Sub-Contractors,			
	separate Contractors, artists or tradesmen, Contractors			
	and other contractors who may be employed direct by			
	the Employer on Site.			
1.17	The Contractor shall provide on site a full time	1 SUM		
	competent Construction Manager, literate and fluent in			
	Chinese and English.			
1.18	The Contractor shall provide on as required basis an	1 SUM		
	approved technically qualified and experienced			
	specialist services engineer together with such other			
	approved staff as are necessary to co-ordinate the			
	design and or installation of all the services installations			
	executed by himself, Specialist Sub-Contractors and			
	Specialist Contractors for this project, such staff to be			
	Chinese and English speaking.			

Items	Description	Provisional	Rate	Amount
Items	Description	Quantity	(HK\$)	(HK\$)
1.19	The Contractor shall attend on all trades and allow for	1 SUM		
	cutting or forming chases, holes and openings, etc. of			
	all sizes, providing and building in sleeves, supplying			
	cement mortar for fixing brackets, bedding and grouting			
	behind frames including supplying cement mortar,			
	painting conduits, sealing around all pipes, ducts and			
	cables with approved mastic, providing electrical power			
	for testing installations, making good all work disturbed			
	and all other necessary work of a like nature.			
1.20	The Contractor is to provide attendance's and other	1 SUM		
	provisions for the Specialist Sub-Contractors/Suppliers			
	to properly carry out and complete their Sub-Contract			
	Works			
1.21	The Contractor is to provide attendance and other	1 SUM		
	provisions for the Contractors and other contractors,			
	artists or tradesmen employed direct by the Employer to			
	them to properly carry out and complete their respective			
	parts of work on Site in the same manner and extent as			
	described for Specialist Sub-Contractors/Suppliers			
	herein above.			
1.22	The Contractor shall comply with any Ordinances,	1 SUM		
	Regulations and requirements of the Hong Kong			
	Government or Statutory Undertaking applicable to the			
	Works.			
1.23	The Contractor shall comply with and give all notices	1 SUM		
	required by any Act or Ordinance of Government, any			
	instrument, rule or order made under any Act or			
	Ordinance of Government, or any regulation or bylaw			
	of any local authority or any statutory undertaker which			
	has any jurisdiction with regard to the Works, or of the			
	Building Management Office.			

T.	Tremmares (cont u)	Provisional	Rate	Amount
Item	Description	Quantity	(HK\$)	(HK\$)
1.24	The Contractor shall bear the cost of any fees or	1 SUM		
	charges including any rates or taxes legally demandable			
	under any Act or Ordinance of Government, or any			
	regulation or bylaw of any local authority or of any			
	statutory undertaker or of the Building Management			
	Office in respect of the Works.			
1.25	The Contractor shall comply with the Labor	1 SUM		
	Department's regulations for safety on Work Sites.			
1.26	The Contractor shall provide sufficient safety helmets	1 SUM		
	for the use of the consultants and other authorized			
	persons visiting the Site.			
1.27	The Contractor shall allow for supplying and displaying	1 SUM		
	during the working hours such signals and markings,			
	etc. as maybe required for the safety of the Public.			
1.28	The Contractor shall provide for the Works a competent	1 SUM		
	Safety Officer to ensure the safety of all operations on			
	the Site during the Contract Period.			
1.29	The Contractor is to take every precaution necessary to	1 SUM		
	protect the public both inside and outside the office			
	premises, from injury or death during the course of the			
	Works.			
1.30	The Contractor shall take care to abate the nuisance	1 SUM		
	caused by noise and dust.			
1.31	The Contractor shall take out and maintain on behalf of	1 SUM		
	himself and his domestic sub-contractors/Supplier such			
	insurance's as are necessary to cover all liability in			
	respect of all employees and other persons who may be			
	employed on the Works or anywhere in Hong Kong			
	whilst engaged in business connected with the Works.			
1.32	The Contractor shall take out and maintain the Third	1 SUM		
	Party Insurance, and Fire, etc. Insurance to cover the			
	necessary insurance's required.			
1.33	The Contractor shall take out his own insurance's to	1 SUM		
	cover damage or loss to plant, tools and equipment			
	owned or hired by him.			

T.	D 14	Provisional	Rate	Amount
Item	Description	Quantity	(HK\$)	(HK\$)
1.34	Keep a competent Site Engineer, literate in English,	1 SUM		
	constantly on the Works			
1.35	The Contractor shall set out all items (including those	1 SUM		
	works carried out by Specialist Sub-contractors or			
	specialist contractors) shown on drawings for the			
	approval of the Project Manager prior to construction.			
1.36	Separate inflammable goods storage sheds in an	1 SUM		
	approved location must be provided. No inflammable			
	good such as fuel oils, oil based paints, kerosene,			
	thinners, cellulose lacquers, bitumen or bitumen based			
	products etc. will be permitted to be stored in the			
	building under construction.			
1.37	Provide a telephone, laptop with email connection and	1 SUM		
	A3 color printer, and a fax machine on the site for			
	Contractor's own use and also for use by, all Specialist			
	Sub-Contractors, Employers Direct Contractors, etc.			
	and other legitimately employed persons on the Site			
	including paying all charges and removing on			
	completion.			
1.38	The Contractor is to make provision for protecting all	1 SUM		
	materials, goods and equipment from damage, etc.			
1.39	The Contractor shall provide a complete temporary fire	1 SUM		
	fighting facility comprising portable fire fighting			
	appliances distributed throughout the whole of the Site			
	and in particular in those areas where the risks are high			
	(e.g. welding, cutting, painting, adhesive bonding, etc.).			
	The Contractor shall nominate a person on his			
	management staff to ensure that this requirement is			
	continually enforced.			
1.40	All work areas contain fittings, furnishings and finishes,	1 SUM		
	which are to be re-used the Contractor must allow for			
	the protection of such			

T4 area	Dogovinski	Provisional	Rate	Amount
Item	Description	Quantity	(HK\$)	(HK\$)
1.41	The Contractor is to shore up, protect and in all ways	1 SUM		
	support and maintain or restore all lands, buildings,			
	roads, fences, parapets and retaining walls, cables,			
	sewers, live drains or other property or things which			
	may be disturbed or damaged during the execution of			
	the works.			
1.42	The Contractor shall also protect the existing building	1 SUM		
	fabric, fittings, finishes, etc. which are not being			
	fitted-out, decorated or altered.			
1.43	The Contractor shall be responsible for the safe	1 SUM		
	guarding and protection of existing services, plant and			
	equipment, pipes, ducts, cables, and the like throughout			
	the site/storage/works areas including all access ways,			
	plant rooms, lifts, lobbies, stairways, etc.			
1.44	The Main Contractor shall provide, erect and maintain	1 SUM		
	scaffold both for his own and for the use of			
	Sub-Contractors employed upon the works, all			
	necessary scaffolding including planks, sheets,			
	tarpaulins, screens, ladders and platforms, barbed wires			
	at low level of scaffolding, adequate security lighting,			
	all necessary strutting and shoring, all necessary gates,			
	footways, gangways, and temporary enclosures			
	required for the proper and efficient carrying out and			
	completion of the work, and shall carry out any			
	alteration required to same.			
1.45	The Contractor shall provide and maintain in good	1 SUM		
	working order all mechanical equipment, plant, tools,			
	implements, ladders, tarpaulins and the like necessary			
	for the proper and timely execution and protection of			
	the Works.			
1.46	The Contractor shall provide, erect, re-locate to suit the	1 SUM		
	staging of the Works, alter if necessary and maintain all			
	necessary scaffolding, catch platforms, protective			
	screens, coverings and hoarding all to the satisfaction of			
	the Project Manager and remove on completion and			
	make good all work disturbed.			

<u>560</u>		Provisional	Rate	Amount
Item	Description	Quantity	(HK\$)	(HK\$)
1.47	The Contractor shall arrange the electricity supply to	1 SUM		
	the works area at the Contractor's expense.			
1.48	Provide to each floor nos. evenly distributed temporary	1 SUM		
	fluorescent light fitting and temporary power on each			
	floor at the Contractor's expense at the Site for the			
	carrying out of the Works including the works of			
	Specialist Sub-Contractors, Contractors and other			
	contractors, artists or tradesmen employed direct by the			
	Employer and including all electric power to enable all			
	Specialist Sub-Contractors and Specialist Contractors to			
	check, test and commissioning their installations to			
	meet the requirements of the Project Manager and all			
	others having jurisdiction at the Contractor's expenses.			
1.49	The Contractor shall also be responsible for all Site	1 SUM		
	works in distributing electricity including, but not			
	limited to, provision, installation and subsequent			
	removal of temporary main switch board, distribution			
	boards, cables, wiring, junction boxes, transformers,			
	lights and all other accessories.			
1.50	The Contractor shall liaise and arrange with building	1 SUM		
	Management Office on the water supply from the			
	building's permanent supply to the works area at the			
	Contractor's expense. The Contractor shall be			
	responsible for all temporary connections and			
	transporting the supplies to the required work locations,			
	disconnection and making good on completion of the			
	Contract Works			
1.51	The Contractor upon completion of each day's Works	1 SUM		
	shall properly clear up and leave the Works and all			
	areas made available to him for the purpose of			
	executing the Works clean and tidy to the reasonable			
	satisfaction of the Project Manager.			

	Transmartes (Cont u)	Provisional	Rate	Amount
Item	Description	Quantity	(HK\$)	(HK\$)
1.52	The Contractor shall provide security control on Site	1 SUM		
	during work periods and until such time that the			
	employers own staff arrive on site. The Contractor			
	will be entirely responsible for the security of the site			
	and allow for this cost in his Tender return.			
1.53	Keep the Site and the works free from water by	1 SUM		
	pumping or otherwise.			
1.54	The Contractor shall keep existing surface channels and	1 SUM		
	drains receiving the discharge from the Site clear of silt,			
	mud etc. at all times by the use of a silt trap or traps			
	which shall be cleared out at the appropriate frequency			
	to ensure compliance with the order of the Project			
	Manager.			
1.55	Prior to the issue of the Certificate of Practical	1 SUM		
	Completion of the Contract Works or the Sections			
	thereof, the Contractor shall, in good time to allow for			
	reviewing, submit to the Project Manager the following			
	documents for the Contract Works: -			
	1 Records of all documents issued by the Authorities in			
	connection with the granting of permits, paying of fees			
	and indicating compliance with codes.			
	2 Certificates of Approval from all Authorities having			
	jurisdiction.			
	3 Operations and Maintenance Manual and as built			
	drawings as required or otherwise called for by the			
	Contract documentation			
	4 ALL Documents required for HAD submission.			
1.56	The Contractor shall carry out regular visits,	1 SUM		
	comprehensive maintenance and servicing of the			
	Contract Works throughout the Defects Liability Period			
	of the Contract as detailed in the Contract Specification.			
	The Contract Sum shall include all expenses and costs			
	in connection with this requirement.			
1.57	HK\$ 30 million "Contractors' All Risk" insurance	1 SUM		
	including 3rd Party Liability and workers insurance			
	during the construction period			

Item	Description	Provisional	Rate	Amount
Ittili	Description	Quantity	(HK\$)	(HK\$)
1.58	Employee Compensation	1 SUM		
	The Contractor shall maintain insurance for the			
	Employees' Compensation and such policy shall			
	include endorsements W338, W348 and W204			
1.59	Site setting-out work for client's approval	1 SUM		
1.60	Protection Work (Wall & Floor) for Building's Public Area and Curtain Wall	1 SUM		
1.61	Debris removal during construction period (all the debris from AL's sub-contractor and Building's Nominated Contractor are included)	1 SUM		
1.62	General pre-handover cleaning after job completion including cleaning of dust, excess glue inside of glass window, floor vacuum cleaning	1 SUM		
1.63	Levies for Construction Industry Council and Pneumoconiosis Compensation Fund Board	1 SUM		
		Section	n 1–Total:	

Section 2 – Demolition Work

Items	Description	Provisional Quantity	Rate (HK\$)	Amount (HK\$)
2.01	Supply labor to dismantle and cart away the existing un-used building material to suit new design and layout plan	1 SUM		
		Section	2–Total:	

Section 3 – Builders Work

		Provisional	Rate	Amount
Items	Description	Quantity	(HK\$)	(HK\$)
3.01	Supply labor and material to install motorized	1 SUM		
	Non-black roller blind along Glass wall façade at			
	Lounge Area and Focus Group Meeting Room 1			
3.02	Supply labor and material to construct back lit logo	1 SUM		
	signage, Chinese lettering and English lettering at			
	Façade			
3.03	Supply labor and material to construct drip tray	1 SUM		
	(Stainless Steel # 316) under the expansion joint			
3.04	Supply labor and material to construct upto +/- 3000	36 LM		
	mm high white laminated plywood hoarding with			
	access door in front of the Façade during construction			
	period			
3.05	Supply labor and material to apply water proofing	36 SM		
	material to 3 Toilet			
	(include 48 hr water leakage testing)			
	Location: Upto 1000mm FFL wall area from finished			
	floor level			
	Supply labor and material to apply water proofing	28.5 SM		
	material to 3 Toilet			
	(include 48 hr water leakage testing)			
	Location: Floor Area			
3.06	Supply labor and material to construct special design	28.5 SM		
	cladding and backdrop for the logo signage at Façade			
3.07	Supply labor and material to resurface the existing	1 SUM		
	double sliding metal gate with paint finish at the Main			
	Entrance ONLY			
	Code: PT-12			
3.08	Supply labor and material to apply film sticker on the	1 SUM		
	new Glass Wall façade at Exhibition Area 2			
	Code: WP-04			
3.09	Supply labor and material to construct new stainless	1 SUM		
	steel (#316) hand rail at the Outdoor Decking			
	(Cost to include for the Staircase and Ramp)			
3.10	Supply labor and material to apply fire proof material	1 SUM		
	for all built in joinery item			
3.11	Rental of high working platform	5 NOS.		
		Section	n 3–Total:	

Section 4 – Flooring and Finishes

	ection 4 – Flooring and Finishes	Provisional	Rate	Amount
Items	Description	Quantity	(HK\$)	(HK\$)
4.01	Supply labor and material to install 500 x 500 carpet	358 SM	, ,	,
	tile flooring			
	Supplier : Interface			
	Series : Color Me			
	Style Code: 24 oz			
	Product Definition : Tufted Textured Tip Sheared Loop			
	Yarn/Fibre: 100% non-virgin Type 6 Nylon			
	Color System: 100% Solution Dyed			
	Machine Gauge: 1/12			
	Tile Size: 500 x 500 mm			
	Pile Thickness: 4.0mm +/- 0.5mm			
	Total Thickness: 7.5mm +/- 0.5mm			
	Code: CP-01, CP-02 & CP-03			
	Location: Focus Group Meeting Room 1 & 2, Office			
	Area, Meeting Room and CEO Office			
4.02	Supply labor and material to install wood like vinyl tile	11.4 SM		
	flooring			
	Supplier : Signal Plus			
	Code: PL-04			
	Location: Wet Pantry & Printing Area			
4.03	Supply labor and material to install fill up the existing	240 SM		
	floor with 4" high light concrete (the existing raised			
	floor system need to be removed)			
	Location : Exhibition Area 1			
4.04	Supply labor and material to make good the existing	1 SUM		
	raised floor system with cement and sand screeding			
	work before laying new vinyl sheet flooring			
	Location :Exhibition Area 2 and Reception Area			
4.05	Supply labor and material to install vinyl sheet flooring	473 SM		
	Supplier : Signal Plus			
	Series : Tarkett			
	Code: PL-01, PL-02 & PL-03			
	Location :Reception, Exhibition Area 1 & 2			

Section 4 – Flooring and Finishes (Cont'd)

Items	Description	Provisional	Rate	Amount
Items	Description	Quantity	(HK\$)	(HK\$)
4.06	Supply labor and material to install floor ceramic tile	42.9 SM		
	with cement and sand screeding work			
	Location : Male Toilet, Disable Toilet and Female			
	Toilet and Landing Area outside Male & Female Toilet			
4.07	Supply labor and material to install stone landing to	1 SUM		
	replace originally wooden flooring Code : ST-03			
	(match with existing stone finishing at Pavement			
	Location : Entrance to Decking			
4.08	Supply labor to take out and re-install the existing	1 SUM		
	raised floor panel for E&M Work under raised floor			
4.09	Supply labor and material to make good/refix the	1 SUM		
	existing raised floor system before laying new carpet			
	flooring			
4.10	Supply labor and material to stack up the existing	220 SM		
	metal structure to 600 mm high FFL			
	(Cost to include repair of the existing metal structure)			
	Location : Outdoor Decking			
4.11	Supply labor and material to install new outdoor wood	220 SM		
	decking			
	Brand Name: "Pro Green" Composite Timber			
	Size:100mm(W) x 25mm (T) x 2000mm (L)			
	Code: WD-01, WD-02 & WD-03			
	Area to cover : All staircase, ramp and planter of the			
	Whole Decking Area			
	Location : Outdoor Decking			
		Cantie	4 To4a1 :	
		Section	4–Total :	

Notes:4.1 The Contractor shall submit details for the CIC and its consultant's approval

- 4.2 The Contractor shall state the origin, manufacture, brand, model, type, etc. wherever equivalent material be proposed.
- 4.3 The Contractor's tender price shall include related air freight and transportation charges if necessary;

Section 5 – Ceiling Finishes

Items	Description	Provisional Quantity	Rate (HK\$)	Amount (HK\$)
5.01	Supply labor and material to re-surface the existing true	778 SM		
	ceiling/ structural beam with emulsion paint finish			
	Brand : ECO Fresh Clean			
5.02	Supply labor and material to construct new false ceiling	30.8 SM		
	with concealed type 600 x 600 aluminum ceiling tile and			
	grid			
	Code: MT-08			
	Location : Male Toilet, Disable Toilet and Female Toilet			
5.03	Supply labor and material to construct flat gypsum board	46.2 SM		
	false ceiling, surfaced with emulsion paint finish			
	Brand: ECO Fresh Clean			
	Location : Reception Area and Exhibition Area 1			
5.04	Supply labor and material to re-surface the existing aluminum	240 SM		
	false ceiling with BLACK paint finish			
	Location: Focus Group Meeting Room 1 & 2			
5.05	Supply labor and material to modify the existing false ceiling	1 SUM		
	to suit new layout and for constructing new window pelmet			
	Location: Focus Group Meeting Room 1 & 2			
		Sectio	n 5–Total :	

Notes: 5.1 All materials used at or above the false ceiling level shall be **non-combustible**.

- 5.2 Allow Formaldehyde-Buster Odour-Less All-In-1 or equivalent grade
- 5.3 The Contractor shall submit details for the CIC and its consultant's approval
- 5.4 The Contractor shall state the origin, manufacture, brand, model, type, etc. wherever equivalent material be proposed.

Section 6 – Partitioning & Wall Finishes

Items	Description	Provisional Quantity	Rate (HK\$)	Amount (HK\$)
6.01	Supply labor and material to construct upto true ceiling	32.6 LM		.,
	height, <u>100mm thk</u> thick dry wall partition, includes			
	- 50mm thk metal stud,			
	- (2 x 12mm gypsum board panel) covered on the both sides			
	of metal stud			
	- 60 kg/m3 rock wool infill filled up the metal stud			
	(Ht: +/- 3660 mm high)			
6.02	Supply labor and material to construct sound baffle (from	18.8 LM		
	2800 mm FFL to to true ceiling), 100 mm thk thick dry wall			
	partition, includes			
	- 50mm thk metal stud,			
	- (2 x 12mm gypsum board panel) covered on the both sides			
	of metal stud			
	- 60 kg/m3 rock wool infill filled up the metal stud			
	(Ht: +/- 860 mm high)			
6.03	Supply labor and material to construct upto true ceiling	12.4 LM		
	height plywood partition with 12mm thk plywood backing on			
	one side ONLY			
	(Ht: +/- 3660 mm high)			
	Location : Reception backdrop			
6.04	Supply labor and material to construct <u>62.5 mm thk</u> upto true	16.2 LM		
	ceiling height single layer dry wall partition, includes			
	- 50mm thk metal stud,			
	- (1 x 12mm gypsum board panel) covered on the ONE side			
	ONLY			
	(Ht: +/- 3660 mm high)			

Items	Description	Provisional	Rate	Amount
Items	Description	Quantity	(HK\$)	(HK\$)
6.05	Supply labor and material to construct upto true ceiling	40.3 LM		
	height 100 mm thk brick wall partition with cement and sand			
	screeding work			
	(Ht: +/- 3660 mm high)			
	Location : Disable Toilet			
6.06	Supply labor and material to construct 2800 mm Ht full glass	10.6 LM		
	partition c/w 10 mm thk clear tempered glass panel and			
	timber framing in hand brush paint finish (PT-13)			
	Location : Office Area, Meeting Room and CEO Office			
6.07	Supply labor and material to construct +/- 3200 mm high full	13.5 LM		
	height x (6+1.5+6) mm Thk laminated glass panel with metal			
	framing			
	(Cost to include minor work submission if necessary)			
	Location : Entrance Glass Façade located at Reception Area			
	and Exhibition Area 2			
6.08	Supply labor and material to repaint the existing metal	12.8 LM		
	framing of the glass partition at the Entrance Façade located			
	at Focus Group Meeting Room 1			
	Location : Entrance Glass Façade located at Focus Group			
	Meeting Room 1			

Items	Description	Provisional	Rate	Amount
Items	Description	Quantity	(HK\$)	(HK\$)
6.09	Supply labor and material to construct upto false ceiling height	4 SETS		
	oval shaped feature wall panel, surfaced with hand brush paint			
	finish			
	Location: Embraced existing Building Column at Exhibition			
	Area 1 &2			
6.10	Supply labor and material to extend and modify the existing	1 SUM		
	operable wall facing to Disable Toilet, to suit new layout plan			
	Remarks: Cost to include transportation cost back to factory for			
	the modification, if required)			
	(Existing Brand Name of Operable Wall: Hufcor)			
	Location: Focus Group Meeting Room 2			
6.11	Supply labor and material to refix and repair all the existing	1 SUM		
	operable wall			
	Remarks: Cost to include transportation cost back to factory for			
	the repair, if required)			
	Location : Focus Group Meeting Room 1 & 2			
6.12	Supply labor and material to surface the wall upto 2800 mm	14.2 SM		
	high from finished floor level with special paint finish			
	Code : PT- 11			
	Location : 2 Curved wall outside Disable Toilet			
6.13	Supply labor and material to surface the wall with 'ECO Fresh	493 SM		
	Clean' paint finishing			
	Location : Whole Area			
6.14	Supply labor and material to surface the wall with 'Screen Goo'	58.8 SM		
	special paint finish for projection purpose			
	Code: PT-08			
	Location : Exhibition Area 1 & 2			

Items	Description	Provisional Quantity	Rate (HK\$)	Amount (HK\$)
6.15	Supply labor and material to surface the wall upto 2800 mm	88.7 SM		
	high from finished floor level with wall paper finish			
	Code: WP-05			
	Location: Inside CEO Office and Meeting Room			
6.16	Supply labor and material to surface the wall upto 2800 mm	43.4 SM		
	high from finished floor level with wall paper finish			
	Code: PT-14			
	Location : Focus Group Meeting Room			
6.17	Supply labor and material to install 316 black stainless steel	120 LM		
	skirting			
	Code: MT-01			
	Location : Whole Area			
6.18	Supply labor and material to surface the existing and new	117 LM		
	operable wall panel with grey color sticker			
	Code: WP-03			
	Location: New and Existing Operable Wall at Focus Group			
	Meeting Room 1&2			
6.19	Supply labor and material to surface the the wall with Magwall	14 LM		
	Screen, with 12mm thk plywood backing			
	Code: WP-01			
	Location: Focus Group Meeting Room 1& 2 and Interactive			
	Wall outside Disable Toilet			
6.20	Supply labor and material to construct feature wall panel above	6.8 LM		
	the seating bench			
	Location: Exhibition Area 1			
6.21	Supply labor and material to construct upto false ceiling height	12.3 LM		
	glossy white feature wall panel behind the reception counter			
	Code: PT-04			
	Location: Reception			

Items	Description	Provisional Quantity	Rate (HK\$)	Amount (HK\$)
6.22	Supply labor and material to surface the wall area upto 2200	12.2 LM	(111Σψ)	(111\$Φ)
	mm high from finished floor level with plastic laminated finish			
	Code : PL-07			
	Location: Corridor leading to Male & Female Washroom			
6.23	Supply labor and material to install all the wall area with	86 SM		
	ceramic tile with cement and sand screeding work			
	Code:			
	Location: Male Toilet Disable Toilet and Female Toilet			
6.24	Supply labor and material to decorate the existing fence facing	10 SETS		
	to Pavement (without TV installation) - cost to include vertical			
	new cladding, re-paint the top & bottom part and new metal			
	fencing			
6.25	Supply labor and material to decorative the existing fence	2 SETS		
	facing to Pavement (with TV installation) - cost to include			
	vertical new cladding, re-paint the top & bottom part			
		Section	6–Total:	

Notes: 6.1The Contractor shall submit details for the CIC and its consultant's approval

- 6.2 The Contractor shall state the origin, manufacture, brand, model, type, etc. wherever equivalent material be proposed.
- 6.3 The Contractor's tender price shall include related air freight and transportation charges if necessary;

<u>Section 7 – Built-In Joinery</u>

Itama	Items Description		Rate	Amount
items	Description	Quantity	(HK\$)	(HK\$)
7.01	Supply labor and material to construct timber reception	4.4 LM		
	counter with storage cabinet, corain top & front panel			
	Location : Reception			
7.02	Supply labor and material to construct 1 level curved shaped	6.5 LM		
	timber sitting bench			
	Location : Reception			
7.03	Supply labor and material to construct 600D x 850mm Ht	4.1 LM		
	timber low cabinet with plastic laminated finish			
	Includes:			
	plastic laminated finish interior & adjustable shelves, swing			
	door and/or lockset			
	Location : Wet Pantry & Printing Area			
7.04	Supply labor and material to construct 600D x 850mm Ht	2.4 LM		
	timber low cabinet with plastic laminated finish			
	Includes:			
	plastic laminated finish interior & adjustable shelves, swing			
	door and/or lockset			
	Location : Meeting Room			
7.05	Supply labor and material to construct 600D x 850mm Ht	3 LM		
	timber hanging cabinet with plastic laminated finish			
	Includes:			
	plastic laminated finish interior & adjustable shelves, swing			
	door and/or lockset			
	Location : Wet Pantry			
7.06	Supply labor and material to install (600 +100) corian top and	4.1 LM		
	splashing board for the low cabinet			
_	Location : Wet Pantry & Printing Area			
7.07	Supply labor and material to install +/- 800 mm Ht color back	3.3 LM		
	glass panel with 12mm thk plywood backing in between			
	low & hanging cabinet			
	Location : Wet Pantry			

<u>Section 7 – Built-In Joinery</u>

Items	Description	Provisional	Rate	Amount
	•	Quantity	(HK\$)	(HK\$)
7.08	Supply labor and material to construct +/- 400~600D x	3.4 LM		
	2800 mm Ht timber high cabinet surfaced with plastic			
	laminated finish;			
	<u>Includes</u> :			
	plastic laminated finish interior & adjustable shelves, swing			
	door and/or lockset			
	Location : Pantry & Printing Area			
7.09	Supply labor and material to construct +/- 400~600D x	1.3 LM		
	2800 mm Ht timber high cabinet surfaced with plastic			
	laminated finish;			
	<u>Includes</u> :			
	plastic laminated finish interior & adjustable shelves, swing			
	door and/or lockset			
	Location: Focus Group Meeting Room 1 & 2			

Section 7 – Built-In Joinery (Cont'd)

T .	Dani di		Rate	Amount
Items	Description	Quantity	(HK\$)	(HK\$)
7.10	Supply labor and material to construct 2800 mm Ht	0.6 LM		
	trapezium-shaped high cabinet surfaced with plastic			
	laminated finish (Code : PL-10)			
	<u>Includes</u> :			
	plastic laminated finish interior & adjustable shelves, swing			
	door and/or lockset			
	Location : Office Area			
7.11	Supply labor and material to construct +/- 2400 L x 800 D x	1 NO.		
	1050 mm Ht timber high table with wood veneer top (Code :			
	WD-06)			
	Location: Wet Pantry & Printing Area			
7.12	Supply labor and material to construct +/- 2000 mm high	5 SETS		
	plywood toilet cubicle with divider, swing door and door			
	lock, surfaced with plastic laminated finish			
	Code: PL-09			
	Location : Male & Female Toilet			
7.13	Supply labor and material to construct ~ 600 D x 800 mm	3 LM		
	high wash hand basin cabinet Includes: - corain worktop and			
	splashing board - timber storage cabinet with space for			
	rubbish bin - cost to include rubbish bin plastic laminated			
	at interior area			
_	Location : Male & Female Toilet			
7.14	Supply labor and material to construct +/- 900 H x 200 D	3 LM		
	mirror openable cabinet to house tissue paper and soap			
	dispenser			
	<u>Include</u>			
	plastic laminated finish interior & adjustable shelves			
	(tissue paper and soap dispenser are at extra cost)			
	Location : Male & Female Toilet			
7.15	Supply labor and material to construct urinal timber divider	1 SET		
	Location : Male Toilet			
7.16	Supply labor and material to construct +/- 2800mm high	9.7 LM		
	triangular -shaped projection wall with up and down light			
	trough			
	Location : Exhibition Area 1			

Section 7 – Built-In Joinery (Cont'd)

Items	Description	Provisional Quantity	Rate (HK\$)	Amount (HK\$)
7.17	Supply labor and material to construct 3 level curved shaped	6.9 LM		
	timber sitting bench, surfaced with wood veneer finish			
	Location: Exhibition Area 1			
7.18	Supply labor and material to install ceiling heavy duty	70.9 LM		
	running track for sliding display panel (Brand Name :			
	Hufcor or equivalent)			
	Location: Exhibition Area 1			
7.19	Supply labor and material to construct upto false ceiling	11 LM		
	feature wall with recessed pen tray			
	Location: Focus Group Meeting Room 1 & 2			
		Section	7 – Total :	

Notes: 7.1 The Contractor shall submit details for the CIC and its consultant 's approval

- 7.2 The Contractor shall check cargo lift size for the width of glass panels and doors
- 7.3 Plastic Laminate finish must allow inside cabinet
- 7.4 All plastic laminate finish must allowed in "Formica" or equivalent grade
- 7.5 All glass work must be provided in tempered glass
- 7.6 All stainless steel must be in #316 grade
- 7.7 The Contractor shall state the origin, manufacture, brand, model, type, etc. wherever equivalent material be proposed.

Section 8 – Doors & Ironmongeries

<u>Se</u>	Section 8 – Doors & Ironmongeries Provisional Pate Amount					
Items	Description	Provisional Quantity	Rate (HK\$)	Amount (HK\$)		
8.01	Supply labor and material to construct +/- 3200 mm high	1 NO.	(ПКФ)	(IIK\$)		
0.01	double swing glass door without metal framing at the	TNO.				
	Entrance Glass Façade at Exhibition Area 2 (包括入小型					
	工程)					
	Code: D01					
8.02	Supply labor and material to construct +/- 3200 mm high	2 NOS.				
0.02	double swing glass door with metal framing at the Entrance	21(05.				
	Glass Façade at Reception (包括人小型工程)					
	Code: D02					
8.03	Supply labor and material to construct +/- 2800 mm Ht	2 NOS.				
	double swing swing timber door with door framing					
	Includes					
	- sound seal and drop seal					
	- ironmongery					
	- door stopper					
	Code: D03					
	Location: Entrance to Focus Group Meeting Room 1 & 2					
	from Exhibition Area 2					
8.04	Supply labor and material to construct +/- 2800 mm Ht single	1 NO.				
	swing concealed type timber door with door framing					
	<u>Includes</u>					
	- sound seal and drop seal					
	- ironmongery					
	- door stopper					
	- concealed type door closer					
	Code: D04					
	Location : Entrance to Office Area					
8.05	Supply labor and material to construct +/- 2800 mm Ht single	2 NOS.				
	swing timber door with hand brush paint finish door framing					
	and viewing glass panel					
	<u>Includes</u>					
	- sound seal and drop seal					
	- ironmongery					
	- door stopper					
	Code: D05					
	Location : CEO Office and Meeting Room					

Section 8 – Doors & Ironmongeries (Cont'd)

	ction 8 – Doors & Ironmongeries (Cont'd)	Provisional	Rate	Amount
Items	Description	Quantity	(HK\$)	(HK\$)
8.06	Supply labor and material to construct +/- 2400 mm Ht 1 fire	1 NO.		(1)
	rated double swing timber door and door framing leading			
	toward Carpark - Comply with European Standard (BSEN)			
	Includes			
	- ironmongery			
	- door stopper			
	- exposed type door closer			
	Code : D06			
	Location: Rear Exit (toward Back Carpark)			
8.07	Supply labor and material to construct +/- 2800 mm Ht single	1 NO.		
	swing concealed type timber door and door framing at the			
	Entrance toward Store /Server Room			
	<u>Includes</u>			
	- ironmongery			
	- door stopper			
	- exposed type door closer			
	Code : D07			
	Location : Entrance to Store / Server Room from Exhibition			
	Area 1			
8.08	Supply labor and material to construct +/- 2400 mm Ht single	1 NO.		
	swing timber door and door framing <u>Includes</u> -			
	ironmongery- door stopper Code : D08			
	Location : Disable Toilet			
8.09	Supply labor and material to construct +/- 2400 mm Ht single	2 NOS.		
	swing timber door and door framing			
	Includes			
	- ironmongery			
	- door stopper			
	Code: D09			
	Location : Female & Male Toilet			
8.10	Supply labor and material to construct +/- 2400 mm Ht single	1 NO.		
	swing timber door with door frame leading to Existing			
	Equipment Room			
	Includes			
	- ironmongery			
	- door stopper			
	Code: D10			
	Location : Equipment Room near Toilet			

Section 8 – Doors & Ironmongeries (Cont'd)

rated towa Inclu - iron - doc - exp - pus Code Loca	Description	Quantity	(TTTZ(b)	
rated towa Inclu - iron - doc - exp - pus Code Loca	Description	Quantity	(HK\$)	(HK\$)
towa Inclu - iron - doc - exp - pus Code Loca	ply labor and material to construct +/- 2400 mm Ht 1 fire	1 NO.		
Inclu - iron - doc - exp - pus Code Loca	d double swing timber door and door framing leading			
- iroi - doc - exp - pus Code Loca	ard Carpark - Comply with European Standard (BSEN)			
- doo - exp - pus Code Loca	udes			
- exp - pus Code Loca	nmongery			
- pus Code Loca	or stopper			
Code	posed type door closer			
Loca	sh bar			
	e : D11			
8.12 Supp	ation: Exit at Focus Group Meeting Room 2			
	ply labor and material to construct +/- 2400 mm Ht single	1 NO.		
swin	g timber door and door framing			
<u>Incl</u>	udes			
- iroi	nmongery			
- doo	or stopper			
Code	e : D12			
Loca	ation: Existing Store Room at Focus Group Meeting			
Roor	m 1			
8.13 Supp	ply labor and material to construct +/- 2400 mm Ht single	2 NOS.		
swin	g plywood access door			
<u>Incl</u>	<u>udes</u>			
- iroi	nmongery			
Code	e : D13			
Loca	ation: Small Storage Area at Focus Group Meeting Room			
1 &2	2			

Notes:

- 8.1 The Contractor shall submit details for the CIC and its consultant's approval
- 8.2 The Contractor shall check cargo lift size for the width of glass panels and doors
- 8.3 Plastic laminate finish must be allowed inside cabinets
- 8.4 All plastic laminate finish must be allowed in Formica Grade or equivalent
- 8.5 All glass works provided must be in tempered glass
- 8.6 All stainless steel must be in #316 grade
- 8.7 All doors shall install necessary sound seal gasket
- 8.8 The Contractor shall state the origin, manufacture, brand, model, type, etc. wherever equivalent material be proposed.
- 8.9 All ironmongery information and detailed drawing could be referring to ironmongery specification and door schedule for reference.

Section 9 – Fitting & Fixtures (Sanitary Ware)

	Section 9 – Fitting & Fixtures (Sanitary Ware)				
Items	Description	Provisional	Rate	Amount	
0.01		Quantity	(HK\$)	(HK\$)	
9.01	Supply and install wall mounted 2kg fire extinguisher	12 NOS.			
9.02	Purchase and Delivery of drinking machine at Wet Pantry	1 NO			
	Brand: H2O Office				
	Series : UW998				
	Colour: Zinc				
	Size: W435 x D 460 x H 1325 cm				
	Supplier : Life Solutions				
9.03	Purchase and Delivery of stainless steel sink unit at Wet	1 SET			
	Pantry				
	Code: SA-08A				
9.04	Purchase and Delivery of water tap unit at Wet Pantry	1 SET			
	Code: SA-08B				
9.05	Purchase and Delivery of fridge at Wet Pantry	1 SET			
	Code : SA -14				
9.06	Purchase and Delivery of sensor type facuet with solar power	4 SETS			
	sensor at Female & Male Toilet				
	Code: SA-01				
9.07	Purchase and Delivery of wash hand basin at Female & Male	4 SETS			
	Toilet				
	Code: SA-02				
9.08	Purchase and Delivery of wall mounted sensor urinal at	2 SETS			
	Male Tiolet				
	Code :SA-03				
9.09	Purchase and Delivery of sitting water closet at Female &	5 SETS			
	Male Toilet				
	Code: SA-04				
9.10	Purchase and Delivery of 'disable type' sitting water	1 SET			
	closet at Disable Toilet				
	Code: SA-05 +SA-06				
9.11	Purchase and Delivery of wash hand basin with manual	1 SET			
	type facuet at Disable Toilet				
	Code: SA-07				
9.12	Purchase and Delivery of tissue rolled paper rack inside each	6 SETS			
	toilet cubicle at Female, Male and Disable Toilet				
	Code : SA-09				

Section 9 - Fitting & Fixtures (Sanitary Ware) (Cont'd)

T.		Provisional	Rate	Amount
Items	Description	Quantity	(HK\$)	(HK\$)
9.13	Purchase and Delivery of hanger inside each toilet cubicle at	6 SETS		
	Female and Male Toilet			
	Code: SA-10			
9.14	Purchase and Delivery of tissue paper holder inside mirror	3 SETS		
	cabinet at Female and Male Toilet			
	Code: SA-11			
9.15	Purchase and Delivery of automatic soap dispenser inside	3 SETS		
	mirror cabinet at Female, Male and Disable Toilet			
	Code: SA-12			
9.16	Purchase and Delivery of electric hand dryer at Female, Male	2 SETS		
	and Disable Toilet			
	Code: SA-13			
9.17	Supply labor and material to install adjustable mirror panel at	1 NO		
	Disable Toilet			
9.18	Supply labor and material to install wall mounted folding	1 NO		
	grab rail at Disable Toilet			
9.19	Supply labor and material to install wall mounted fixed grab	4 NOS		
	rail at Disable Toilet			
9.20	Supply labor and material to install call bell, light indicator	1 SUM		
	and buzzer inside Disable Toilet			
9.21	Supply labor and material to install Formica "Coolinear"	5 SETS		
	floor to ceiling cubical system at Male toilet and Female			
	toilet			
	Code: SA-15			_
		Section	9 – Total :	

- 9.1 The Contractor shall submit details for the CIC and its consultant's approval
- 9.2 The Contractor shall state the origin, manufacture, brand, model, type, etc. wherever equivalent material be proposed.
- 9.3 All detailed information could be referring to sanitary ware & fitting specification for reference.

Section 10 – Fire Services

Items	Description	Provisional Quantity	Rate (HK\$)	Amount (HK\$)
	rks listed below shall be carried out by building nominated Fire- ontractor at Main Contractor's own cost—			
10.1	Organize and coordinate with different parties including users, sub-contractors, Nominated sub-contractor (NSC) of CIC and the CIC.	1 SUM		
		Section 10 – Total :		

Section 11 – Air Conditioning Modification Work

T4	5	Provisional	Rate	Amount
Items	Description	Quantity	(HK\$)	(HK\$)
11.01	Dismantle & cart away existing MVAC system including air	5 NOC		
11.01	duct, refrigerant pipe, drainpipe, air grilles & control wiring	5 NOS.		
11.02	Relocate existing "FUJITSU" VRF indoor unit c/w support	2 NOS.		
11.03	Supply & install refrigerant pipe with close cell insulation	2 NOS.		
11.04	Supply & install GI condensate drain pipe c/w 25mm phenolic foam insulation	2 NOS.		
11.05	Relocate the thermostat for indoor unit c/w conduit & control wiring	6 NOS.		
11.06	Supply & install GI sheet ductwork c/w support & 25mm thick X 32kg/m³ fibreglass insulation	6 NOS.		
11.07	Install existing 1200X400mm aluminium return air louvre c/w filter	2 NOS.		
11.08	Supply & install 200mm width aluminium linear diffuser plus 4 Plenum box	30 LM		
11.09	Chemical cleaning for indoor unit	1 SUM		
11.10	Supply and install exhaust air and air duct	2 NOS.		
11.11	Supply and install schedule time for existing fancoil and Heat Exchange system	2 NOS.		
11.12	Carry out N2 pressure test and dehydrate the refrigerant circuit and charge up sufficient refrigerant	1 SUM		
11.13	 Miscellaneous, included: a) Discharge and recharge the refirgerant circuit for installation. Pressure test shall be performed adter recharge. b) Air balancing c) Labeling d) Painting e) Statutory submission, if any. f) Shop drawing and as-fitted drawings g) Testing and commissioning h) Staff training for the MVAC system above included O&M Manual 	1 SUM		
		Section	11 – Total :	

Section 12 – Electrical Work

<u>50</u>	ection 12 – Electrical Work	Provisional Rate	Amount	
Items	Description	Quantity	(HK\$)	(HK\$)
12.01	Supply labor and material to construct new 32 Amp 3 Phase	2 NOG		
12.01	sub-main switch board	2 NOS.		
12.02	Supply labor and material to construct new 63 Amp 3 Phase	2 NOS		
12.02	sub-main switch board	2 NOS.		
12.03	Supply labour and material to install 63 Amp main cable	20 LM		
12.04	Supply labor and material to relocate the existing 100Amp	1 NO.		
12.04	MCCB with main cable installation	I NO.		
12.05	Supply labor and material to instal New Digital Multi Meter	4 NOS.		
12.06	Supply labor and material to install new Cable Link Box	2 NOS.		
12.07	Supply labor and material to install 20A RCD fuse switch	18 NOS.		
12.08	Supply labor and material to install 13AMP twin power socket	37 NOS.		
12.08	with concealed G.I. conduit, wiring work and cover plate.	37 NOS.		
12.09	Supply labor and material to install 13AMP single power socket	73 NOS.		
12.09	with concealed G.I. conduit, wiring work and cover plate.			
	Supply labor and material to install 13AMP power connection			
12.10	for Building fancoil unit and exhaust system with concealed	6 NOS.		
	G.I. conduit, wiring work and cover plate.			
	Supply labor and material to install data / voice dual outlet with			
12.11	G.I. conduit and base box	67 NOS.		
12.11	Remarks : All wiring, termination and faceplate installation are	07 NOS.		
	excluded			
	Power & Conduit Work for AV System			
	Supply labor and material to install HDMI outlet with G.I.			
12.12	conduit and base box	38 NOS		
12.12	Remarks : All wiring, termination and faceplate installation are	36 NOS.	38 NOS.	
	excluded			
	Supply labor and material to install LED Control outlet with			
12.13	G.I. conduit and base box	3 NOS		
14.13	Remarks : All wiring, termination and faceplate installation are	2 1102		
	excluded			

Section 12 - Electrical Work (Cont'd)

Items	Description	Provisional	Rate	Amount
		Quantity	(HK\$)	(HK\$)
	Supply labor and material to install Speaker outlet with G.I.			
12.14	conduit and base box	23 NOS.		
12.11	Remarks : All wiring, termination and faceplate installation are	23 1(05.		
	excluded			
	Supply labor and material to install Cam outlet with G.I.	1 NO.		
12.15	conduit and base box Remarks : All wiring, termination and			
	faceplate installation are excluded			
10.16	Supply labor and material to install G.I. conduit for central	1 SUM		
12.16	control at Focus Group Meeting Room 1 & 2			
	Conduit Work for CCTV System			
	Supply labor and material to install CCTV outlet with G.I.			
10.17	conduit and base box	10 NOS		
12.17	Remarks : All wiring, termination and faceplate installation by	19 NOS.		
	Others			
	Supply labor and material to install 13AMP fuse spur with			
12.18	concealed G.I. conduit, wiring work and cover plate for	9 NOS.		
	electrical lock			
12.19	Supply labor and material to install conduit work for access	6 NOS.		
12.19	card system	0 NOS.		

Section 12 – Electrical Work (Cont'd)

	ction 12 – Electrical Work (Cont'd)	Provisional Rate	Rate	Amount
Items	Description	Quantity	(HK\$)	(HK\$)
	Conduit Work for Lutron Light System			
12.20	Supply labor and material to install data / voice dual outlet with G.I. conduit and base box Remarks: All wiring, termination and faceplate installation are excluded	4 NOS.		
12.21	Supply labor and material to install 13AMP fuse spur with concealed GI. conduit, wiring work and cover plate for electrical lock	12 NOS.		
12.22	Supply labour and material to construct panic button include all necessary wiring and conduit work	3 NOS.		
12.23	Supply labor and material to install power point connection for all new light fittings c/w wiring and necessary conduit work (On/Off Switch)	309 NOS.		
12.24	Supply labor and material to construct 100 x 100 mm metal trucking for high voltage cable above false ceiling	45 LM		
12.25	Supply labor and material to construct 100 x 100 mm metal trucking for low voltage cable above false ceiling	45 LM		
12.26	Miscellaneous, included: a) Earthling and bonding work according to Code of Practice (CoP) from EMSD b) Labeling c) Painting d) Statutory submission, such as, but not limited to, Form of Compliance, WR1, etc. e) Shop drawings and as-fitted drawings f) Testing and Comissioning g) Staff training for all electrical system included h) O&M Manual	1 SUM		
	,	Section	12 – Total :	

- 12.1 The Contractor shall submit details for the CIC and its consultant's approval
- 12.2 The Contractor shall state the origin, manufacture, brand, model, type, etc. wherever equivalent material be proposed.
- 12.3 All detailed information could be referring to sockets & switches schedule for reference.
- 12.4 LOW SMOKE ZERO HALOGEN (LSZH) POWER CABLE SHALL BE USED IN THIS PROJECT.

Fitting Out Works for the Construction Innovation and Technology Application Centre (CITAC) for the CIC Ref. (302) in P/AE/PUR/AGC

Section 13 – Plumbing & Drainage Work

	Section 13 – Plumbing & Drainage Work	Provisional	Dete	Amount
Items	Description	Provisional Quantity	Rate (HK\$)	Amount (HK\$)
	Dismantle and cart away the installation no longer maintained in	Quantity	(111ΣΦ)	(11ΙΧΦ)
13.01	the project area.	1 SUM		
	Supply and install new washing basin, c/w pipes, valves, fixing			
13.02	and all necessary accessories, for the Disabled Toilet	1 SUM		
13.02	(Cost of equipment are quote separately in Section 9)	1 BCWI		
	Supply and install direct water dispenser, c/w pipes, valves,			
13.03	fixing and all necessary accessories for the new Wet Pantry	1 SUM		
13.03	(Cost of equipment are quote separately in Section 9)	1 SOM		
	Supply and install stainless steel #304 sump water tank, c/w			
13.04	cover, h-pipes, drip tray, fixing and all necessary accessories for	1 SUM		
13.04	the direct water dispenser.	1 SUM		
	Supply and install "Tsurumi" sump pumps (1 standby and 1			
13.05	duty), c/w pipe works, valves, power connection, cable to control	1 SUM		
13.03	panel, fixing and all necessary accessories.	1 SUM		
	Supply and install sump pump control panel, c/w indicator lamp,			
	buzzer, mute button, operation mode selector, containment,			
12.06	power and control wiring (LZOH cable), fixing and all necessary	1 SUM		
13.06	accessories. The panel shall able to automatically swap the	1 SUM		
	operation of standby / duty pumps, receiving high level signal to			
	cut off water provision by controlling the motorized valve for			
	water, etc.			
	Supply and install dia. 22mm copper pipe, c/w fittings,			
12.07	connection, fixing and all necessary accessories, for fresh water	1 CLD /		
13.07	provision to direct water dispenser. This contractor shall be	1 SUM		
	responsible to connect the captioned pipe from existing water			
	provision point.			
	Supply and install dia. 42mm GI pipe, c/w fittings, connection,			
12.00	fixing and all necessary accessories, for waste water drainage	1 01774		
13.08	from sump tank of direct water dispenser. This contractor shall be	1 SUM		
	responsible to connect the captioned pipe to existing water			
	drainage point.			
13.09	Supply and install solenoid valve for water supply connected to	1 SUM		
	sump pump panel.			

Section 13 - Plumbing & Drainage Work (Cont'd)

Items	Description	Provisional Quantity	Rate (HK\$)	Amount (HK\$)
13.10	Dismantle and cart away existing unused sanitary fittings (lot)	1 SUM	(ΠΙΚΨ)	(111Χφ)
13.11	Supply and install the following sanitary fittings, c/w associated pipe works, valves, fixings and all necessary accessories, for Male, Female and Disable Toilets. - Sensor type faucet, sensor urinal, wash hand basin, sitting water closet	1 SUM		
13.12	Miscellaneous, included: a) Painting and labeling b) Shop drawings and as-fitted drawing c) Testing and commissioning d) O&M manual	1 SUM		
		Section	13 – Total:	

13.1 LOW SMOKE ZERO HALOGEN (LSZH) POWER CABLE SHALL BE USED IN THIS PROJECT.

Section 14 – Service Charge for Obtaining BEAMS Gold Level

	ection 14 – Service Charge for Obtaining BEAMS Gold Level	Provisional	Rate	Amount
Items	Description	Quantity	(HK\$)	(HK\$)
14.01	Using Software to conduct an energy simulation on the			
	development, comparing the BEAM Plus baseline model with the	1 SUM		
	development design			
14.02	EU3 -Provision of independent commissioning authority (CxA)	1 SUM		
	for T&C	1 SUM		
14.03	IEQ 8- Conduct simulation and prepare report to demonstrate the			
	uniformity, glare index and color rendering could comply with	1 SUM		
	CIBSE			
14.04	IEQ 9- Conduct simulation and prepare report to demonstrate the			
	natural lighting illuminance level for workstations and/or seating	1 SUM		
	area			
14.05	MAN 3- A Construction Noise Plan and monthly construction			
	Nosie management report (assuming 3 months) for the Proposed	1 SUM		
	Development will be prepared for Client endorsement			
14.06	MA 11 - A Waste Management Plan (WMP) and monthly			
	construction waste management report (assuming 3 months) for			
	the Proposed Development for Client endorsement. The	1 SUM		
	appraisal of types and quantity of waste to be generated during			
	construction is assumed to be provided by Client			
14.07	EU3a - Preparation of Commission Plan	1 SUM		
14.08	EU3b - Preparation of Commission Report	1 SUM		
14.09	WU 1 - To conduct water quality survey (maximum 8 water test	1 CLD /		
	points) and test report	1 SUM		
14.10	IEQ 1 & IEQ 7 - To conduct measurement (max 15 IAQ test			
	points) and prepare report to demonstrate that the IAQ could	1 CITM		
	comply with good class requirement in the IAQ Certificate	1 SUM		
	Scheme			
		Section	14 – Total:	

Conditions of Tender

Section 15 – IT Network Cabling

Items	Description	Provisional Quantity	Rate (HK\$)	Amount (HK\$)
15.01	Supply & install metal trucking, exposed type conduit, cabling			
	(CAT6) and associated works with all necessary accessories for			
	cabling and IT equipment/system.	1 SUM		
	(Provisional quantity to be adjusted with final design)			
		Section 15 – Total:		

15.1 LOW SMOKE ZERO HALOGEN (LSZH) POWER CABLE SHALL BE USED IN THIS PROJECT.

Section 16 – Security System

Items	Description	Provisional Quantity	Rate (HK\$)	Amount (HK\$)
16.01	Supply & install metal trucking, concealed type conduit, cabling			
	(CAT6), and associated works with all necessary accessories for			
	CCTV & access cards equipment/system.	1 SUM		
	(Provisional quantity to be adjusted with final design)			
		Section	16 – Total:	

Notes: 16.1 The Contractor shall submit details for the Consultant's and the CIC's approval

16.2 Specification for item 16:

Building's Maintenance Contractor "The Jardine Engineering Corporation Ltd."

Contact person: Mr. Gary Cheng Phone no.: 28074866 / 66561636

Email: gary.mf.cheng@jec.com

16.3 LOW SMOKE ZERO HALOGEN (LSZH) POWER CABLE SHALL BE USED IN THIS PROJECT.

Section 17-AV System

	Section 17– AV System			
Items	Description	Provisional	Rate	Amount
	2333.4	Quantity	(HK\$)	(HK\$)
	Projection Wall at Exhibition Area 1			
17.01	Supply and install Panasonic PT-EZ590 projector, 5400 Lumens,			
	WUXGA, Std lens and digital signage and mobile devices –			
	brand: Brightsign XD233			
	(the item included not limited to below listed):	3 SETS		
	a) Projector ceiling pole			
	b) Hollyland HSMI-CAT 6 Extender			
	c) Engineering Charges			
17.02	Supply and install CAT6 wiring fOR HDMI extender for	C CETC		
	Pre-wiring work	6 SETS		
	Interactive Touch Projector at Exhibition Area 1			
17.03	Supply and install Projector - EB-696Ui (Finger Touch			
	Interactive), digital signage and mobile devices – brand:			
	Brightsign XD233			
	(the item included not limited to below listed):	1 SET		
	a) HOLLYLAND HDMI-CAT 6 EXTENDER			
	b) USB- CAT 6 EXTENDER			
	c) 3M PWF-500 PROJECTION FILM 2X1.2M			
	d) Engineering Charges			
	APPLE IPAD Wall Mount at Exhibition Area 1			
17.04	Supply and install APPLE IPAD 32GB WIFI (color: Silver),			
	(the item included not limited to below listed):			
	a) Maclock IPAD wall mount lock	4 SETS		
	b) Earphones for IPAD			
	c) Engineering charges			
	Reception LED Wall at Reception Area			
17.05	Supply and install LED TV Wall with dimension: 8960 X			
	960MM, Total: 8.6 SQ M, PH2.5, Brigthness & color: 900			
	cd/m², 14 bits colors - Fanless, Die casting aluminum cabinet -			
	Max. & Avg. power consumption: 580 & 194W/m², included			
	front access maintenance services, control system.	1 SET		
	(the item included not limited to below listed):			
	a) Structure frame support			
	b) Management PC			
	c) Engineering charges			

Section 17-AV System (Cont'd)

2	ection 17–Av System (Cont d)	Provisional	Rate	Amount
Items	Description	Quantity	(HK\$)	(HK\$)
	Projection Wall at Exhibition Area 2			
17.06	Supply and install Panasonic PT-EZ590 projector, 5400 Lumens,			
	WUXGA, Std lens, digital signage and mobile devices brand:			
	Brightsign XD233			
	(the item included not limited to below listed):	4 SETS		
	a) Projector ceiling pole			
	b) Hollyland HSMI-CAT 6 Extender			
	c) Engineering Charges			
17.07	Supply and install CAT6 wiring for HDMI extender for	8 SETS		
	Pre-wiring work	8 SE1S		
	Audio System at Focus Group Meeting Room 1 &2			
17.08	Supply and install TOA A-2060 120W amplifier.	2 SETS		
17.09	Supply and install Bose DS16F ceiling speakers	16 SETS		
17.10	Supply and install Biamp Nexi CS audio DSP	2 SETS		
17.11	Supply and install Shure wireless handheld mic	4 GETEG		
	Model: PGX24/SM58	4 SETS		
17.12	Supply and install Shure wireless Tie clip	O GETEG		
	Model: PGX14/CVL	2 SETS		
	Central Control System			
17.13	Supply and install the In-put Panel, Atlona Two-Input UK Wall	4 GETEG		
	Plate Switcher for HDMI and VGA Inputs with HDBaseT Output	4 SETS		
17.14	Supply and install the In-put Panel, Atlona HDBaseT Scaler with	4 GETEG		
	HDMI and Analog Audio Outputs	4 SETS		
17.15	Supply and install the HDMI Matrix, Kramer 8x8 HDMI Matrix			
	Switcher	1 SET		
	Model : VS-88HN			
17.16	Supply and install the HDMI Extender, HOLLYLAND	o aeta		
	HDMI-CAT 6 extender.	8 SETS		

Section 17–AV System (Cont'd)

	Section 17–AV System (Cont'd)			
Items	Description	Provisional	Rate	Amount
		Quantity	(HK\$)	(HK\$)
17.17	Supply and install the control, Crestron 3-Series Control	1 SET		
	System®			
17.18	Supply and install the control, Crestron expansion card	2 SETS		
17.19	Supply and install the control, Crestron® App - Control App for	2 SETS		
	Apple® iOS® & Android™	2 5215		
17.20	Supply APPLE IPAD 32GB WIFI SILVER	2 SETS		
17.21	Supply and install Wifi router	1 SET		
17.22	Supply and install 8 CHANNEL CUSTOM RELAY BOX	1 SET		
17.23	Miscellaneous, included, not limited to below item:			
	a) Engineering charges			
	b) Programming for the Crestron Conrtol System			
	c) include System Planning, System Programming, Testing &			
	Commission, user training, user manual document	1 SUM		
	d) Programming for the audio DSP			
	e) Control System Cabling and Wiring			
	f) Delivery and Installation of Control System			
	g) Cabling & Wiring, Testing and Commissioning			
	Outdoor LED TV			
17.24	Supply and install outdoor LED TV with dimension: 1500 X			
	1160MM, Total 1.6 SQ M, PH6, Brigthness & color: 1600			
	cd/m², 14 bits colors outdorr led, front access maintenance			
	services and control system	2 SETS		
	(the item included, not limited to below listed):			
	a) Structure frame support			
	b) Engineering charges			
	Office Area Meeting Room TV			
17.25	Supply and install SAMSUNG (Model: HG49AE690DJXZK)			
	49" LED TV, included, not limited to below listed:			
	a) HDMI extender Hollyland HDMI-CAT 6 extender	1 SET		
	b) Wall mount bracket			
	c) Installation charge			
	<u>-</u>	<u> </u>	1	

Section 17-AV System (Cont'd)

Items	Description	Provisional Quantity	Rate (HK\$)	Amount (HK\$)
	TV located at the Column			
17.26	Supply and install SAMSUNG (Model:HG32AE570BJXZK) 32"			
	LED TV , included, not limited to below listed:			
	a) Digital signage and mobile devices brand: Brightsign XD233	o arma		
	b) HDMI extender Hollyland HDMI-CAT 6 extender	8 SETS		
	c) Wall mount bracket			
	d) Installation charge			
	Equipment Rack			
17.27	Supply and install 47U equipment rack	3 SETS		
	PA Speaker Relocation / Rewire			
17.28	Re-install existing PA speakers (7 sets) with rewiring work	1 SUM		
		Section	17 – Total:	

17.1 LOW SMOKE ZERO HALOGEN (LSZH) POWER CABLE SHALL BE USED IN THIS PROJECT.

Section 18 – Loose Furniture

Items	Description	Provisional Quantity	Rate (HK\$)	Amount (HK\$)
18.01	F-01 : Round high table at Lounge Area	2 NOS.	(1114)	(1111ψ)
18.02	F-02 : High chair at Lounge Area	4 NOS.		
18.03	F-03 : Stool at Outdoor Deck	5 NOS.		
18.04	F-04 : Round low coffee table at Lounge Area	1 NO.		
18.05	F-05 : CEO desk and side storage cabinet & panel	1 SET		
18.06	F-06 : Lounge Chair at CEO Office	2 NOS.		
18.07	F-07 : Coffee table at CEO Office	1 NO.		
18.08	F-08: High chair at Wet Pantry Area	4 NOS.		
18.09	F-09: 1100 x 1100 120 0 degree work desk with desk top fabric	9 NOS.		
	panel and mobile pedestal at Office Area	9 NOS.		
18.10	F-10: Mid back clerical chair with fabric seat at Office Area,	13 NOS.		
	CEO Guest Chair and Receptionist Chair	13 NOS.		
18.11	F-11: Ir-regular shaped Meeting table with corian top at	1 NO.		
	Meeting Room	1110.		
18.12	F-12: Meeting chair at Meeting Room	7 NOS.		
18.13	F-13: Low cabinet at Meeting Room	1 NO.		
18.14	F-14 : CEO main chair	1 NO.		
18.15	F-15: 1200W x 450D x 900H mm roller shutter door cabinet	2 NOS.		
	Finishes: metal	2 NOS.		
18.16	F-16: 1200W x 450D x 1980H mm roller shutter door cabinet	3 NOS.		
	Finishes: metal	<i>3</i> 1103.		
		Section	18 – Total:	

Supplier Information

Supplier 1: Maum Studio, Contact: Creamy, Contact No: 2308 1931

Supplier 2: Lamex System Furniture, Contact: Raymond Tse, Contact No: 2828 6862 / 9475 3063

Supplier 3: Haworth, Contact: Mike Leung, Contact No: 2832 0288/6851 1421

Notes: 18.1 The Contractor shall submit details for the CIC and its consultant's approval

18.2 The Contractor shall state the origin, manufacture, brand, model, type, etc. wherever equivalent material be proposed.

18.3 All detailed information could be referring to loose furniture specification for reference.

Section 19 – Light Fitting

Items	Description	Provisional	Rate	Amount
	-	Quantity	(HK\$)	(HK\$)
	Purchase and Delivery of light fitting			
19.01	L01 – outdoor floor lamp at outdoor area	32 NOS.		
19.02	L02 – outdoor tree light at outdoor area	8 NOS.		
19.03	L03 – dimmable LED panel at focus group meeting room	20 NOS.		
19.04	L04a – dimmable LED recessed downlight at focus group meeting rooms	32 NOS.		
19.05	L04b – LED recessed downlight for toilet area	7 NOS.		
19.06	L05a – dimmable LED twin spotlight at reception area	20 SETS		
19.07	L05b – LED twin spotlight at exhibition area 1 & 2	43 SETS		
19.08	L06 – dimmable LED recessed downlight at reception area	15 NOS.		
19.09	L07 – LED track light at exhibition area 2	21 NOS.		
19.10	L08 – LED panel at office area	7 NOS.		
19.11	L09 – LED spotlight at exhibition area 1	28 NOS.		
19.12	L10 – outdoor wall lamp at outdoor area	6 NOS.		
19.13	L11 – pendant lamp at office pantry area	2 NOS.		
19.14	L12 – pendant lamp at office meeting room	1 NO.		
19.15	L13 – LED single spotlight at office area	24 NOS.		
19.16	L14 – pendant lamp at reception area	1 NO.		
19.17	L15 – flexible LED strip at office pantry area with all necessary accessory (e.g. transformer)	1 SUM.		
19.18	L16 – flexible LED strip (blue LED strip) at reception area with all necessary accessory (e.g. transformer)	1 SUM		
19.19	L17 – LED desk lamp for office area	10 NOS.		
19.20	L07 – Ceiling light track	170 LM		
19.21	L15 – LED light strip	50 LM		
19.22	L15 – LED light strip transformer	16 NOS.		
		Section	19 – Total:	

Notes: 19.1 The Contractor shall submit details for the CIC and its consultant's approval

- 19.2 The Contractor shall state the origin, manufacture, brand, model, type, etc. wherever equivalent material be proposed.
- 19.3 All detailed information could be referring to architectural lighting specification for reference.

Fitting Out Works for the Construction Innovation and Technology Application Centre (CITAC) for the CIC Ref. (302) in P/AE/PUR/AGC

Section 20 – Lighting Control System

3	Section 20 – Lighting Control System					
Items	Description	Provisional	Rate	Amount		
	F	Quantity	(HK\$)	(HK\$)		
20.01	Lutron QSGR-TC-3S-WH-CPN5825	1 SET				
	QS Timeclock. 120V-240V, 50/60Hz.	1 521				
20.02	Lutron QSNE-4A10-D	3 SETS				
	-ESN Phase dimming module	3 SE13				
20.03	Lutron QSNE-4T10-D	3 SETS				
	- Energi Savr Node QS 4 zone 0-10v control module	3 3613				
20.04	Lutron QSNE-4S10-D					
	- Energi Savr Node QS 4 zone switching module, with 4 feed via	12 SETS				
	10 ampere switched outputs.					
20.05	Lutron QSWE-10BRLN-AW (keypad for zone control)					
	- QS device. International seeTouch QS 2-10 button wallstation.					
	Two					
	contact closure inputs via a connector on the back of the	12 SETS				
	wallstation.					
	Unit dimensions with faceplate: (87mmx87mm). Mounts in					
	Europeanand UK wallboxes, in plastic material finishes white					
	color.(final number of buttons will be confirmed by end user)					
20.06	Lutron QSM7-XW-C					
	Quantum Sensor Module (QSM) is a ceiling-mounted device,	4 SETS				
	limited 434MHz.					
20.07	Lutron LRF7-OCR2B-P-WH	50 GETEG				
	RPS wireless occ. sensor, ceiling mount	52 SETS				
20.08	Lutron LRF7-DCRB-WH	2 GETEG				
	Lutron Radio Powr Savr daylight wireless sensors.	2 SETS				
20.09	Lutron QSE-CI-AP-D	1 CET				
	Energi Savr Node Programming interface LEN port	1 SET				
20.10	Lutron QSE-CI-NWK-E	1 000				
	Lutron RS232 interface card	1 SET				
20.11	Lutron QSE-IO	1 000				
	I/O Card	1 SET				
20.12	Lutron GRX-LC8	1 000				
	Controller Unit	1 SET				
20.13	Lutron GRX-CESO-277-PKG	1 000				
	Light Sensor	1 SET				

Section 20 – Lighting Control System – Cont'd)

	ection 20 – Lighting Control System – Cont'd)	Provisional	Rate	Amount
Items	Description	Quantity	(HK\$)	(HK\$)
20.14	Regular enclosure for Lutron Power Module installation and	Quality	(1114)	(ΙΙΙΙΨ)
	protection.			
	-Accommodate DIN rails for mounting up to 9 sets Lutron			
	Power Modules. It allows space among Power Modules and the			
	vents on the cover for ventilating. The enclosure accepts multi-	2 SETS		
	feeding to power the lamps and Power Modules. Each Module			
	with individual 10A C-type Breaker. Also main power supply			
	with 32A 3Phase Breaker Control.			
	(Dimension H1520mm x W408 x D110mms)			
20.15	Lutron System Equipment Airfreight Charge	4 0771 6		
	Airfreight Costs from United States to Hong Kong	1 SUM		
20.16	Engineering and Installation Services, included:			
	System installation and wire terminating connection.			
	b) System Schematic drawing, Lighting cuicuit plan and conduit			
	drawing.			
	c) Lutron QS link Cables Supply and wiring (low smoke zero			
	halogen standard)			
	d) Site co-ordination and site supervision			
	e) System final setup and scene settings			
	f) System Programming	1 SUM		
	g) System coordination with AV system (Automation system)	1 SUM		
	h) keypad/button fucntion code and Lighitng scene preset code,			
	etc.			
	i) Lutron seeTouch keypad artwork propose and button name			
	engraving, etc.			
	j) Testing and Commissioning			
	k) Lutron system operation manual			
	l) EMSD documents (WR1A)			
	m) System simple training			
		Section	20 – Total:	

20.1 LOW SMOKE ZERO HALOGEN (LSZH) POWER CABLE SHALL BE USED IN THIS PROJECT.

21 – Contingency Sum

Items	Description	Qty.	Rate HK\$	Amount HK\$
21.01	A provisional sum for Contingency	1	Sum	800,000
		Section 2	1 - Total :	800,000

The percentages of payment do not imply or indicate the relative or absolute amount of resources and expenses to be spent by the Contractor to produce the concerned deliverables

and to complete the tasks and services. The payment schedule is as follows:-

Deliverable No.	Deliverable Description	Payment Stage / Date	Payment (%)
1	Upon submission of EC, CAR, organization chart, project contact list, emergency contact list, master working programme	Within 3 calendar days after contract engagement	5%
2	Upon submission of method statements, calculations, shop drawings, material samples and references of proceeding purchase orders.	Within 7 calendar days after contract engagement	5%
3	Upon submission of order purchase and confirmation of on-site setting outline	Within 17 calendar days after contract engagement	15%
4	Upon 50% Completion of Fit-out Works (subject to the CIC and its consultant's satisfaction)	Within 30 calendar days (approx.) after contract engagement	30%
5	Upon Completion of Fit-out Works and all necessary T&C and to get all relevant statutory approvals for permit to use at the Innovation and Technology Application Centre (subject to the CIC and its consultant's satisfaction)	Within 62 calendar days after contract engagement	25%
6	Upon submission of as-built drawings and Operation & Maintenance Manual and all necessary certificates and reports – subject to the CIC and its consultant's satisfaction (including electronic and hardcopy in pdf and AutoCAD format)	Within 1 month after completion of renovation work	10%
7	Defects Liability Period (DLP) Upon expiry of 12 months DLP after making good of all the defects – subject to the CIC and its consultant's satisfaction	Upon expiry of the 12 months DLP	10%
		Total	100%

Defects Liability Period	TWELVE (12) months
Date for Possession/ Commencement	Within SEVEN (7) calendar days from the CIC's
	written notice to commence
Date for Completion	62 Calendar Days from the Date of Contract Award
Liquidated and Ascertained Damages	At the rate of HK\$100,000 per day
Period of Final Shop Drawings and	1 month after Date for Practical Completion
Maintenance Manual	•
Name of Company	:
Signature of Person Authorized	
to Sign for the Proposal*	:
	(with company chop)
Address	
T 1 N	E. M
Tel No.:	Fax No.
Email:	Date:
<u></u>	

^{*} If the tender is submitted by a Joint Venture, all participants in the Joint Venture must sign the Fee Proposal.

APPENDIX E – Tender Evaluation Procedures and Criteria

1. INTRODUCTION

- 1.1 A two-envelope approach is adopted for tender submission, i.e. Tenderer should submit the technical proposal including all information specified in **Appendix A of the Conditions of Tender** and **Special Conditions of Tender**, and the letter annexed in **Appendix B** and mentioned in Clause 4.28 of the Conditions of Tender in one envelope and the fee proposal comprising the completed Form of Tender using the prescribed form provided in **Appendix C of the Conditions of Tender** and the Fee Proposal using the prescribed form provided in **Appendix D of the Conditions of Tender** in a separate envelope. Fee proposal would only be opened after the technical assessment is completed subject to Clause 1.4 below.
- 1.2 A marking scheme as described below will be used for evaluating the tenders. Tender proposals shall be evaluated based on two separate aspects, namely the technical assessment and the fee assessment.
- 1.3 The pre-determined weights for technical and fee assessments are 70% and 30% respectively.
- 1.4 If the technical assessment mark in Table 1 below is less than 60% of the maximum marks, the tender proposal will be rejected and will NOT be further assessed and its fee proposal envelope will NOT be opened.
- 1.5 The rejected tender proposal will NOT be included in the weighted technical assessment score formula in Clause 2.2 and the weighted fee assessment score formula in Clause 3.2 below. The CIC reserves its right to cancel this tender exercise and re-tender thereof without further notice to the tenderer.
- 1.6 An assessment panel will be established for tender evaluation. The proposal received will be evaluated in accordance with the requirements in this Appendix.

2. TECHNICAL EVALUATON

2.1 Detailed evaluation of the technical proposal including all information specified in Appendix A of the Conditions of Tender shall be made in accordance with the assessment criteria described in Table 1.

Table 1 – Technical assessment marking scheme

Assessment Criteria	Assessed Marks (%)	Maximum Marks (%)
Assessment will be based on the following	ng criteria:-	
1. Tenderer's profile, background a (10%)	and expertise	10%
2. Job Reference of the Tenderer in similar project nature and scale. (10)		10%
3. Proposed composition and org project team with qualifications, excapability of team members in similar construction services. (15%)	xperience and carrying out	15%
The following sub-criteria shall be c (a) Organization of Proposed 1 (5%) (b) Qualification, Experience and Proposed Project Team (10%)	Project Team	
4. Approach and work programme objectives and carry out and contasks described in the Assignment Annexes (65%)	nplete all the	65%
 The following sub-criteria shall be of (a) Management of Works Progra (b) Proposed Project Methodology (c) Proposed AV Contractor / Sup (d) Safety & Health and Emeasures for the Project (5%) 	mme (25%) y (15%)	
	Total:	100%

2.2 The weighted technical assessment score of a tender shall be determined in accordance with the following formula:

70 x Technical assessment mark of the subject tender
Highest technical assessment mark of all tenders

3. FEE EVALUATION

- 3.1 Tender fee for evaluation shall be the lump sum quoted in Appendix D Fee Proposal of the Conditions of Tender.
- 3.2 The weighted fee assessment score of the tender proposal shall be worked out in accordance with the following formula:

4. CALCULATION OF COMBINED SCORES

4.1 The combined assessment score of a tender proposal shall be the sum of the weighted technical assessment score (Cl.2.2) and the weighted fee assessment score (Cl.3.2).

APPENDIX F - Reply Slip for Tender Briefing and Site Visit Session

I/we would like to attend the tender briefing and site visit session for the Fitting Out Works of the Construction Innovation and Technology Application Centre at 10:00 a.m. on 26 May 2017 at. G/F, CIC Kowloon Bay Training Centre, 44 Tai Yip Street, Kowloon Bay, Kowloon, Hong Kong (Exit A, MTR Kowloon Bay Station)

Full Name of Attendee(s)		Post/Title	
Company Name:			
Contact Person:		Post/Title:	
Address:	•		
Telephone No:		Fax No:	
Mobile Phone No:		E-mail:	

Note:

- 1. Each Tenderer shall register three attendees at most.
- 2. Please return the completed reply slip to fax no: 2100 9439 no later than 17:00 on 25 May 2017.
- 3. Please contact Mr. Kelvin LEE at Tel: 2100 9425 or email: kelvinlee@cic.hk for any enquiry.

APPENDIX G - Reply Slip for Declining Bid

With reference to your tender invitation (<u>Tender Reference</u>: (302) in <u>P/AE/PUR/AGC</u>, <u>Closing Date</u>: **9 June 2017**), I/we regret that I am/we are unable to bid due to the <u>following reason(s)</u>:

(Ple	ase tick against the box(es) where applicable)
	Inadequate time to prepare tender proposal. Suggested timeframe for proposal preparation: days
	Invitation document contains insufficient details. Suggested supplementary details:
	Work scope too broad. Would you consider bidding if the work scope is reduced? Yes No Or which part(s) of the work scope shall be reduced to facilitate your consideration in bidding (please specify)?
	Work scope too narrow. Would you consider bidding if the work scope is broadened? ☐ Yes ☐ No Or what supplementary details shall be added to facilitate your consideration in bidding (please specify)?
	Not interested in this type of service.
	Working at full capacity at the moment.

Work scope beyond firm's/organisation's expectation.							
Cannot meet proje	ect time schedule.	Suggested	timeframe	for	the	project:	
Requirements / Specifications too restrictive.							
Others (please spec	ify):						
	Signature	;	:				
	Full Name of Contac	et Person	:				
	Position		:				
	Name of Company	:	:				
	Telephone No.		:				
	Fax No.	:	:				
	E-mail	:	:				
	Date		:				

Note:

- 1) Please return the completed reply slip to fax no: 2100 9439 no later than 12:00 noon on <u>9 June 2017.</u>
- 2) Please contact Mr. Kelvin LEE at Tele: 2100 9425 or email: kelvinlee@cic.hk for any enquiry.

Special Conditions of Tender

for

Fitting Out Works for the Construction Innovation and

Technology Application Centre (CITAC)

for

the Construction Industry Council

May 2017

© 2017 Construction Industry Council

The contents of this document remain the property of the CIC, and may not be reproduced in whole or in part without the expressed permission of the CIC.

Special Conditions of Tender

To be included in Technical Proposal

1. Statement of Convictions under the Immigration Ordinance (Cap. 115)

- 1.1 A tender will not be considered if, during the 12-month period prior to the closing date set for receipt of tenders, the tenderer has more than two convictions in respect of separate incidents under Sections 17I or 38A of the Immigration Ordinance (Cap. 115) for employing illegal immigrants or for having illegal immigrants on any site under the tenderer's control.
- 1.2 The tenderer shall submit with the tender a <u>statement of either all convictions</u> under Section 17I or 38A of the Immigration Ordinance (Cap. 115) for employing illegal immigrants or for having illegal immigrants on any site under the tenderer's control, and the dates of all such convictions, during the 12-month period prior to the closing date set for receipt of tenders, <u>or a statement of "no conviction"</u>. The statement shall be certified by a person authorized to sign the contract on the tenderer's behalf.

2. Statement of Convictions under the Factories and Industrial Undertaking Ordinance (Cap. 59)

2.1 The tenderer shall submit with the tender a <u>statement of either all convictions</u> under the Factories and Industrial Undertakings Ordinance, (Cap. 59) for site safety convictions for all sites under the tenderer's control, and the dates of all such convictions, during the 12-month period prior to the closing date set for receipt of tenders, <u>or a statement of "no conviction"</u>. The statement shall be certified by a person authorized to sign the contract on the tenderer's behalf.

3. Statement of Convictions under the Employment Ordinance (Cap. 57)

3.1 A tender will not be considered if, during the 12-month period prior to the closing date set for receipt of tenders, the tenderer has had three or more convictions in respect of separate incidents under the Employment Ordinance (Cap. 57) which individually carry maximum fines corresponding to Level 5 or higher within the meaning of Schedule 8 to the Criminal Procedure Ordinance (Cap. 221).

3.2 The tenderer shall submit with the tender <u>a statement of either all convictions</u> under the Employment Ordinance (Cap. 57), and the dates of all such conviction, during the 12-month period prior to the closing date set for receipt of tenders, or <u>a statement of "no conviction"</u>. The statement shall be certified by a person authorized to sign the contract on the tenderer's behalf.

4. Outline Health & Safety Plan

- 4.1 All tenderers should submit, as part of the tender, an Outline Health & Safety Plan (Outline Plan) which shall contain sufficient information to demonstrate the tenderer's proposals for achieving effective and efficient health & safety procedures. Failure to submit the Outline Plan may invalidate the tender.
- 4.2 The Outline Plan should start with a formal statement of policy in relation to health & safety and should include:
 - (i) An assessment of risks associated with the works activities when carrying out the Works;
 - (ii) An outline of the health & safety procedures and protective controls to be developed; and
 - (iii) Manner by which they would be implemented and monitored to ensure health & safety on the Site.
- 4.3 The Outline Plan should provide a suitable basis for the development of the Health & Safety Plan. The tenderer may be required to amplify, explain or develop the Outline Plan for the consideration of acceptance of tender.
- 4.4 Typical foreseeable hazards associated with construction works may include but not limited to the following:
 - (i) The use of construction plant and equipment, including lifting appliances. e.g. tower cranes, excavators.
 - (ii) All temporary works including design, erection, loading, unloading and dismantling.
 - (iii) The dangers of rigging and of handling wire ropes.
 - (iv) The handling, use, storage and transportation of materials and substances.
 - (v) Hot working including grinding, chipping, cutting, welding, burning, etc.
 - (vi) Exposure to hazardous substances.

- (vii) Exposure to dust, fumes, vapors, etc.
- (viii) The risk of natural causes e.g. Typhoons.
- (ix) The risks of using electricity on site.
- (x) Risks posed to public members.

5. Selected Domestic Sub-Contractor / Sub-Consultants

5.1 The tenderer shall submit with his tender a list of sub-contractors / sub-consultants to whom the tenderer proposes to sublet section(s) of works / services stating its willingness to enter into a domestic sub-contract with the tenderer to carry out the works mentioned in this tender.

6. General Building Contractor Registration / Minor Works Contractor Registration

The tenderer shall give the registered number and the date of expiry of registration of their Registered General Building Contractor (RGBC) or Registered Minor Works Contractor (RMWC) here:

Registered General Building Contractor (RGBC) No.:
Date of expiry for the above registration:
Registered Minor Works Contractor (RMWC) No. :
Date of expiry for the above registration:

Assignment Brief

of

Fitting Out Works for the Construction Innovation and Technology Application Centre (CITAC) for the Construction Industry Council

May 2017

© 2017 Construction Industry Council

The contents of this document remain the property of the CIC, and may not be reproduced in whole or in part without the expressed permission of the CIC.

Assignment Brief

Fitting Out Works for the Construction Innovation and Technology Application Centre (CITAC) for the CIC

Table of Contents

		Page	
1.	Background	AB-3	
2.	Objectives	AB-3	
3.	Scope of Works	AB-3	
4.	Presentations	AB-5	
5.	Deliverables	AB-5	
6.	Brief Programme	AB-7	
7.	Management of the Contractor	AB-8	
8.	Contractor's Office and Staffing	AB-8	
9.	General Specifications	AB-12	
10.	Technical Specifications	AB-24	
Ann	nexes:		
Annex 1 - BEAM Plus Interior Sustainability Specification AB-46			
Annex 2 - CIC Work Above Ground Safety Guideline AB-8			
Annex 3 - Tender Drawings AB-1			
Annex 4 - Door Schedule and Material Specification AB-175			

1. Background

- 1.1 Continuous innovation is vital to the sustainable development of the construction industry. Creative ideas and innovative solutions are recognised as important levers to effect growth and efficiency especially in today's dynamic world. To encourage and facilitate the sharing of practical technologies and skill to the construction practitioners, the Construction Industry Council (CIC) is seeking for a contractor to carry out the fitting out works of its new Construction Innovation and Application Technology Centre (CITAC) located at Kowloon Bay Training Centre to spearhead development of new techniques and applications to enable continuous improvements in the construction industry of Hong Kong.
- 1.2 The role of the CITAC is to transform that mindset and ensure innovation becomes business-as-usual, creating a sector that is sustainable and one that generates greater economic impact for Hong Kong.

2. Objectives

- 2.1 The Contractor must provide high quality of works, to complete the Assignment within schedule and budget.
- 2.2 The Contractor must organise and coordinate with different parties including users, sub-contractors, and other parties engaged / nominated by the CIC.
- 2.3 The CIC is now appointing a Contractor to carry out the fitting out work based on the provided design drawing.

3. Scope of Works

- 3.1 The scope of works under the Assignment (the Works) shall include but not limited to the following:
 - (a) All fitting out works have to comply with the CIC's requirements and responsible for all required charges, deposit or application / permit fee in relation to the fitting out works.

- (b) Prepare and monitoring the work schedule to meet the targeted completion date.
- (c) The Contractor has to work with CIC's instructions to comply with all works required prior to the CIC's inspections.
- (d) The Works shall be completed within Sixty-Two (62) calendar days upon confirmation of order including materials order and delivery on site.
- (e) Provide all necessary protection to existing finishes and properties of the CITAC building during the Works.
- (f) Supply and install all interior finishes including false ceiling, flooring and wall finishes and provide all necessary fittings and fixtures according to drawings, specifications and/or approved material samples.
- (g) Supply and install all sound proof partitions and doors, sliding doors, automatic glass doors and provide all necessary fittings and fixtures according to drawings, specifications and/or approved material samples.
- (h) Supply and install all cabinet, pantry cabinet and provide all necessary fittings and fixtures according to drawings, specification and/or approved material samples.
- (i) Supply, install, modify, coordinate and liaise with CIC's nominated E&M contractor(s) (i.e. Air-Conditioning, Fire Services, Plumbing & Drainage, Electrical, Curtain Wall, Lift, BMS, Antenna system. etc.) to ensure all E&M services are promptly and correctly installed/modified according to the specifications and drawings (if necessary).
- (j) Supply and install all Audio and Video (AV) system with reference to the Schedule of Rates and provide all necessary fittings and fixtures according to drawings, specifications and/or approved samples.
- (k) Other items of work directly or indirectly related to this Works Project Contract may be added by the CIC with the agreement of the Contractor and shall form part of the overall scope of the Works Project and be covered by the terms of the Agreement with additional fees that mutually agreed by the

CIC and the Contractor.

- (l) Provide all necessary warning notices, signages, labels, protection and temporary lighting facilities to pedestrian when needed in order to comply with relevant statutory requirements.
- 3.2 The tender shall refer to the other requirements laid down in the Assignment Brief and its Annexes of the tender document.
- 3.3 Additional Services Other items of work directly or indirectly related to this Works Project Contract may be added by the CIC with the agreement of the Contractor and shall form part of the overall scope of the Works Project and be covered by the terms of the Agreement with additional fees that mutually agreed by the CIC and the Contractor.

4. Presentations

- 4.1 To attend all meetings with the CIC and its consultant(s) / contractor(s) for weekly coordination and update meetings;
- 4.2 To report the progress of fitting out work status to the CIC and its consultant(s) / contractors during the weekly meetings.
- 4.3 To present Contractor Weekly Status Reports to the CIC after the weekly coordination meetings.
 - 4.4 To conduct site safety walk with relevant parties and the CIC;
 - 4.5 To arrange briefing sessions as required by the CIC to any parties which the CIC considers appropriate; and
 - 4.6 The presentation materials shall be bilingual as necessary and required.

5. Deliverables

5.1 The works project and all Deliverables shall comply with the contract requirements to the satisfaction of the CIC. Should there be different interpretations between the

- CIC and the Contractor against any requirements in the Contract; the CIC shall have the final jurisdiction on the explanation and approach of the implementation for the requirements. The Contractor shall follow the explanation of the requirements and the instructions given by the CIC to implement the solution to the satisfaction of the CIC.
- 5.2 To submit organization chart, project contact list, emergency contact list, master works programme, etc. for the CIC's approval;
- 5.3 To prepare and submit daily reports including number of workers, trades, site photo records, etc. to the CIC;
- 5.4 To prepare and submit Contractor's reports which contain updated working programmes, shop drawings and material submission schedules, site safety reports, progress photos and other necessary documents to the CIC during weekly meetings;
- 5.5 To prepare minutes for weekly meetings;
- 5.6 To prepare and submit materials sample, catalogue, MSDS, etc. for CIC?s approval;
- 5.7 To prepare and submit shop drawings for the CIC's approval prior to the commencement of the Works;
 - 5.8 All documents shall be submitted electronically in MS Word format, MS Excel format (for data) and in pdf file format or any other formats as applicable which are readily printable. Hardcopy of shop drawings in appropriate size shall be submitted to CIC for comment / approval.
- 5.9 The copyright of all reports, documents, recommendations, data and any other

 Information prepared or collected by the Contractor, its specialist(s) and the sub-consultant(s) / sub-contractor(s) and their employees and agents in the course of the Works project shall be borne with the CIC.

6. Brief Programme

- 6.1 The works project shall be completed within **62 calendars days** under the supervision of the CIC.
- 6.2 The Contractor undertakes to carry out the works project and submit Deliverables as stipulated in the Assignment Brief and its Annexes to the CIC in accordance with the tentative programme specified in Paragraph 6.4 below or as directed / agreed by the CIC from time to time.
- 6.3 Supplementary information or reports other than the deliverables stated below shall be prepared and delivered at such time upon request by the CIC.
- 6.4 The following activities shall be taken into consideration in the preparation of the programme:

Task	Description of Deliverables	Deadline
(1)	Upon submission of EC, CAR, organization chart, project contact list, emergency contact list, master working programme	Within 3 calendar days after contract engagement
(2)	Upon submission of method statements, calculations, shop drawings, and references of proceeding purchase orders.	Within 7 calendar days after contract engagement
(3)	Upon submission of order purchase and confirmation of on-site setting outline	Within 17 calendar days after contract engagement
(4)	Upon 50% Completion of Fit-out Works (subject to the CIC and its consultant's satisfaction)	Within 30 calendar days (approx.) after contract engagement
(5)	Upon Completion of Fit-out Works and all necessary T&C and to get all relevant statutory approvals for permit to use at the Innovation and Technology Application Centre (subject to the CIC and its consultant's satisfaction)	Within 62 calendar days after contract engagement

(6)	Upon submission of as-built drawings and Operation &	Within 1 month after completion
	Maintenance Manual and all necessary certificates and	of renovation work
	reports - subject to the CIC and its consultant's	
	satisfaction (including electronic and hardcopy in pdf and	
	AutoCAD format)	
(7)	Defects Liability Period (DLP)	Upon expiry of the 12 months DLP
	Upon expiry of 12 months DLP after making good of all	
	the defects - subject to the CIC and its consultant's	
	satisfaction	

7. Management of the Contractor

- 7.1 The Contractor shall be directed and supervised by the CIC.
- 7.2 References to the CIC in this Assignment Brief and its Annexes shall include the committees and/or task forces and/or task groups set up under the CIC. The CIC Secretariat will facilitate the CIC in supervising the Contractor.
- 7.3 The Contractor shall attend all meetings held by the CIC formed for this works project and the internal meetings of the CIC as required and necessary.

8. Contractor's Office and Staffing

- 8.1 The Contractor shall maintain for the duration of this works project an office in Hong Kong under the control of a Project Manager with at least 10 years of management experience in the profession / field relevant to the subject matter of the works project.
- 8.2 The composition of the works project shall also include at least the following team members:
 - (a) Project Manager The Project Manager shall be fully responsible for FULL-TIME overall contractual, managerial, technical and co-ordination matters. The Project Manager shall possess a minimum of 10 years in

- buildings works / civil engineering / building services engineering / construction management or related experience in the construction industry.
- (b) Project Supervisor The Contractor shall provide FULL-TIME Project Supervisor(s) who shall assist the Project Manager in liaising with the CIC and arrange site matters including, progress control and monitoring, labour forces, emergency services, acquisition of materials, upkeeping of Contractor's project / service teams and managing all scope of Works specified in the Contract, The Project Supervisor shall:
 - have a minimum of 5 years' engineering experience, the last 3 years of which shall be in renovation work in the aspect of site management / site supervision;
 - have the authority and responsibility for day-to-day administration
 of the Works, including control and supervision of the workers
 in routine and comprehensive installation, maintenance and
 emergency services; and
 - be provided with a mobile telephone at the Contractor's expense to allow immediate contact on as and when necessary basis, by the CIC
- (c) Safety Supervisor The Contractor shall provide a Safety supervisor with Certificate of Construction Safety Supervisor (OSHC or CICTA preferred), minimum 5 year site safety field experience, the safety supervisor shall:
- Provide support to the project by maintaining a visible presence to the field performing site visits to the entire project at least once per shift, if possible coordinate with the project manager.
- Regularly review and be familiar with all applicable legislation and applicable standards, to ensure compliance.
- Develop a Site Safety Management Plan (SMP) for the project to ensure a safe work environment for all company employees, contractors, visitors and community.
- Regularly audit the SMP for compliance and update to ensure the alignment with project scope and conditions.
- Ensure that all incidents are reported immediately.

- Ensure incident corrective actions are followed up on and completed. Ensure
 injured workers are offered modified duties and documentation has been
 completed. Monitor and follow up on modified workers in the field.
- 8.3 The works project team as a whole, and each individual (except administrative support staff) within the team shall have the experience of conducting projects of similar nature and scope of those required in this works project.
- 8.4 Contractor shall provide the CIC with full details of staff to be employed on the works project together with their curriculum vitae and proof of qualifications for prior approval from the CIC. Separate approval from the CIC should be obtained for any subsequent changes of staff.
- 8.5 The works project team shall provide all specialist and sub-consultant / sub-contractor services (not limited to those specified in Paragraph 8.1 above) required for the satisfactory completion of the works project. No additional fees or expenses for the provision of such services rendered locally or overseas shall be payable by the CIC.
- 8.6 The Project Manager shall attend all the meetings as may be called upon by the CIC.
- 8.7 The Contractor shall provide staff and manpower input in accordance with the technical proposal made at the tender stage, and that the CIC shall have the right to check the time-log record of the Contractor's staff deployed for the works project.
- 8.8 In the event of any deviation or change of team members with respect to the submitted tender, prior approval from the CIC must be sought.
- 8.9 In the event, for reasons beyond his control, the Contractor is unlikely to provide or maintain any key staff as specified in the proposal, he should report to the CIC as soon as practicable and propose for the CIC's approval of a substitute staff having qualification and experience comparable with the staff who is leaving the works project team.
- 8.10 The Contractor shall be responsible for preparing the meeting minutes and submitting them to the CIC within 2 weeks after the meeting. Meeting papers and

Assignment Brief

documents shall be prepared and submitted by the Contractor within 1 week before the meeting.

9. General Specifications

9.1 General

- 9.1.1 The scope of work should include all the renovation work of the CIC's Construction Innovation and Technology Application Centre ("The Site"). <u>The Works shall be completed within 62 calendar days upon award of contract including materials order and delivery on site.</u>
- 9.1.2 The Contractor shall maintain insurance for the Employees' Compensation and such policy shall include endorsements W338, W348 and W204. Contractor's All Risks and Third Party Insurance for the Works will be provided by CIC.
- 9.1.3 Protective plastic sheets <u>MUST</u> be provided at the Contractor's own cost to fully cover the roof / podium / balcony in order to avoid water damage when the Works are carried out at the Site.
- 9.1.4 Relevant standards, codes, guidelines, regulations and other documents issued by international / local statutory authorities shall be followed.
- 9.1.5 The Works shall include, but not limited to, the following:
 - a) Submission of the proposed materials, sample boards, detailed sketches etc. to the Employer for comment and approval before commencement of the Works.
 - b) Relevant submissions to Buildings Department of the HKSAR for the Works in compliance with the statutory requirements.
 - c) Resume of any other trade works / fire sealant / insulation etc. before / after the Works.
 - d) Liaise with any contractor(s) employed by the Employer to achieve timely completion of the Works if required.

- e) The Contractor shall liaise closely with the Employer and its representative(s) for detailed planning / execution of the Works.
- f) Provide all necessary warning notices, signages, labels, protection and temporary lighting facilities to pedestrian when needed in order to cope with all relevant statutory requirements.
- g) Provide any temporary works, supporting works, steel works, plates, fixing brackets and / or other necessary components in order to complete the whole installation / works.
- h) Submit method statement / testing procedures to the Employer for approval and carry out all necessary testings for the Works according to the latest version of procedures approved by the Employer or its representative(s).
- i) Provide THREE (3) sets of as-fitted record documents / drawings / sections / sketches for the alternated and addition system as installed in both hard copy and electronic files stored CD-ROM / DVD-ROM.
- j) Provide quotation for subsequent operation & maintenance work (if applicable) and unit rate for major components that may incur for additional / alternation works with validity for at least one years' time after DLP.
- 9.1.6 All materials and workmanship shall comply with all relevant sections of the latest edition of the following and all current amendments thereto issued, unless otherwise instructed by the Employer:
 - a) B(C)R 90 & FS Code subsection C5 & clause C11.1 Requirements of fire resisting construction

- b) PNAP APP-37 Curtain wall, window & window wall systems, in particular the guidelines on design, standards & installation of window system, quality & heat soak process of tempered glass, and submission of compliance certificate of test report
- Codes of Practice for Minimum Fire Service Installations and Equipment and Inspection, Testing and Maintenance of Installations and Equipment issued by Fire Services Department;
- d) Relevant circular letters issued by Fire Services Department;
- e) General Specification for Building issued by Architectural Services Department (Version 2007).
- 9.1.7 All inspection, checking, adjusting, servicing, modifying, testing, maintenance and repairing services for those installations not exempted from such Regulations shall be carried out by competent persons provided by the Contractor in a safe, prompt and workmanlike manner to the satisfaction of the Employer.

9.2 Site Visits before Submitting Tender

9.2.1 Before completing and submitting tenders, the tenderers are required to visit the Site to appreciate and familiarize the extent of the Works. Failure to visit the Site prior to tendering will not be entertained as an excuse for deviations once the tender is submitted. The technical details given in the Specifications are for indication of the approximate information only and the tenderer shall have no time and cost claim against the Employer should the actual details vary considerably from the list.

9.3 Safety Requirement

- 9.3.1 The Contractor shall fully comply with all safety requirements as required by the Factory and Industrial Undertakings Ordinance (Cap. 59) and Occupational Safety and Health Ordinance (Cap. 509). Any cost arises from the compliance of the safety requirements shall be fully borne by the Contractor and shall be deemed to be allowed in the tender.
- 9.3.2 The Contractor shall also take all necessary safety measures in a reasonable and practical manner, e.g. use of barriers, warning signs, fencing etc. to the satisfaction of the Employer and its representative(s), to prevent general public or others contractual entrant from getting access into the working / construction area accidentally during the execution of the Works.

9.4 Environmental Requirement

9.4.1 The Contractor shall be required to observe all Environmental Protection Department's requirements including the disposal of construction waste materials and generation of construction noise. The Contractor shall be required to submit necessary documents and substantiate to the Employer that all such requirements are fully complied with in every three-month intervals, and whenever upon request by the Employer.

9.5 Working Hours, Rates of Wages, etc.

9.5.1 The Contractor shall comply with any current legislation or regulations regarding working conditions, working hours including house rules set by the Training Centres or rates of payment to employees and accept the risk of any impending legislation or other conditions which alters any obligations or imposes new obligations.

9.6 <u>Contractor's Management Organization</u>

9.6.1 The Contractor shall provide an adequately qualified and experienced working team(s) for the purpose of this Contract. The team members shall be required to attend regular meetings with the Employer and its representative(s) to review the progress, work performance, complaints etc. The team shall comprise of, at least, the following team members:

- (a) <u>Project Manager</u>
- (b) Site Supervisor(s)
- (c) Safety Supervisor

9.7 <u>Provision of Mobile Telephone</u>

9.7.1 In order to provide prompt service and to eliminate adverse effect to the users / staffs, the Contractor shall submit details of the duty engineers before the commencement of the Contract. The Contractor shall equip the emergency contact list with mobile telephones at the Contractor's expenses, for the efficient and effective operation of the Contract. All mobile phones shall be at 'Standby' mode at any time. The Contractor shall also provide his staff with adequate means of transportation for emergency attendance to the Site upon request.

9.8 Equipment and Appliances Offered

9.8.1 The equipment and appliances offered shall be rated at 380 volts, 3 phase 4-wire/220 volts single phase two wire \pm 6 % at 50Hz.

9.9 Provision of Tools, Ladders and Trestles

9.9.1 The Contractor shall provide all tools, helmets, trestles and Personal Protective Equipment (PPE) such as protective goggles etc as required at their own cost for the execution of duties as required by this Contract and associated statutory requirements.

9.10 <u>Inspection, Measurement and Test Equipment</u>

9.10.1 The tenderer shall use calibrated equipment for the Supply of Calibrated Inspection, Measurement and Test Equipment. All equipment and ancillaries shall be checked, calibrated and maintained in good working order and available for use at all times.

9.11 Scaffolding / Working Platform

External of Building

9.11.1 Scaffolding platform will be erected by CIC at the exterior of the Kowloon Bay Centre (KBC) and/or the Resources Centre (RC) building if necessary. Tenderer should use such scaffolding platform while working at the exterior of the building with the Employer's approval. The Personal Protective Equipment (PPE) must be provided by tenderer.

Internal of Building

9.11.2 Scaffolding / working platform must be erected by tenderer at the interior of the building.

- 9.11.3 The scaffolding / platforms should comprise of all necessary items such as the stepping board, keys, etc to form a complete installation to suit safety and Labour Department's requirements. All platforms and scaffolding must be safe, secured and closely monitored/ checked/ reviewed by a competent person / registered safety officer / licensee according to Labour Department's requirements and / or statutory requirements. The tenderer is required to make good of all building penetration caused by the erection and / or demolition of the scaffolding / platform at their own cost.
- 9.11.4 Where the Works can be safely carried out with the use of ladders or trestles as directed by guidelines issued by Labour Department at whatever height, the Contractor has to provide these facilities at no extra cost.

9.12 Removal of Contractor's Debris

9.12.1 Upon completion of the project works / rectification work during DLP, the Contractor shall remove, to an appropriate disposal point, all old parts or debris arising out of the Works periodically at the Contractor's own expenses. The Contractor shall keep the equipment and its surrounding area clean and tidy to the satisfaction of the Employer.

9.13 Spare Parts

9.13.1 The tenderer shall include in his tender all required spare parts and the tenderer shall also offer warranty that all the spare parts can be available on the market for THREE (3) consecutive years after the expiry of the Defect Liability Period (DLP).

9.14 Advice of Orders Placed

9.14.1 The tenderer is required to forward copies of all orders placed for major items and equipment which are necessary to be imported from overseas to Employer for reference within two weeks after approval of the corresponding equipment by the Employer. Copies of all orders placed shall be forwarded to the Employer for information & record.

9.15 Addition and Deletion of Installation

- 9.15.1 The Employer shall have the right during the Contract period to instruct additional installation works into this Contract and the Contractor shall execute such additional works in accordance with the Conditions of this Contract.
- 9.15.2 The Employer shall have the right during the Contract period to instruct for omission of installation works from the Contract.
- 9.15.3 Within seven days of written notification by the Employer of any addition or deletion of the installation works, the Contractor shall review his staffing level to ensure the proper execution of the Works and if necessary seek approval from the Employer for any change to the staffing level required.

9.16 Contractor's Labour Force and Workshop Facilities

- 9.16.1 The Contractor shall directly employ sufficient, suitably skilled and experienced workmen for carrying out the Works as described in this Specification. The Contractor shall ensure adequate staff is provided in carrying out the periodic inspections and arrange separate team to attend 24 hours emergency calls. The staff organization chart shall be submitted at the commencement of the Contract for the Employer's approval.
- 9.16.2 All workmen shall wear clean uniform or the Contractor's badge and carry the Company identity card bearing the employee's photograph whilst on duty.

- 9.16.3 The Contractor shall take measures to ensure that his employees shall not commit any of the following acts at the Site:
 - a) Enter any area other than those necessary for the performance of the Works,
 - b) Cause damage to any property,
 - c) Gambling,
 - d) Commit any criminal offence,
 - e) Consume alcoholic beverage,
 - f) Fight and/or quarrel
 - g) Use foul languages,
 - h) Behave in a manner likely to endanger himself or any other person or cause damage to any property,
 - i) Fail to wear uniform and Company ID card whilst on duty.
- 9.16.4 The Contractor shall provide the staff organization chart and contact list which shall be regularly updated for re-submission as and when necessary due to subsequent change of details previously.

9.17 Security

9.17.1 The Contractor shall ensure that the Works included in this Contract are properly and adequately executed in good working order, safe operating condition and for its efficient performance. Before leaving the Site and upon completion of execution of work each time, the Contractor shall be responsible for keeping all tools, materials in safe custody, and relevant access doors and panels locked.

9.18 Clearance of Debris and Unwanted Materials, etc.

- 9.18.1 The Contractor shall be responsible for keeping each installation on Site in a clean, tidy and orderly condition to the satisfaction of the Employer or its representative(s) at no extra cost.
- 9.18.2 In particular, each time after the execution or completion of Works, the Contractor shall clean the floor and carry away from the Site all debris and rubbish. Should the Contractor fail to comply with this requirement, the Employer will instruct cleaning work to be carried out by others and subsequently reimburse the full cost of the work from the Contractor.

9.19 <u>Information to be Submitted to the Employer</u>

- 9.19.1 In addition to the requirements of staff organization, Contractor's facilities, working programme, company's brochures, etc. that stipulated in this specifications, the Contractor shall also submit the followings:
 - a) Method Statement;
 - b) Warranty;
 - c) Support, Maintenance and Spares;
 - d) Proposed System Design Description, Schematics and Drawings;
 - e) Project Implementation Plan and Schedule;
 - f) Project Methodology and Deliverables;
 - g) Technical Expertise;
 - h) Risk Management Expertise;
 - i) Project Experience
 - j) Information on Relevant Projects
 - k) Schedule of Current Projects

9.20 Remedy on Contractor's failure to Perform

9.20.1 If the Contractor fails to carry out any work required under the Contract or refuses to comply with any instruction or order given by the Employer in accordance with the Contract within a reasonable time, the Employer may give the Contractor 7 days' notice in writing to carry out such work or comply with such instruction.

9.20.2 If the Contractor fails to comply with such notice, the Employer shall be entitled to carry out such work by itself or by his own workmen or by other contractors. Without prejudice to any other remedy, all additional expenditure properly incurred by the Employer in having such work or instruction carried out shall be recoverable by the Employer from the Contractor by deduction from money due to the Contractor under this Contract or under any other contract between the Employer and the Contractor.

9.21 <u>Industrial Training and Pneumoconiosis Levies</u>

9.21.1 The Contractor's attention is drawn to his obligations under the Industrial Training (Construction Industry) Ordinance (Cap. 317) and the Pneumoconiosis (Compensation) Ordinance (Cap. 360) and the Contract Sum shall include the amounts payable in respect of these levies with regard to all works included in this Contract.

9.22 <u>Electricity and Water Supply</u>

- 9.22.1 The Contractor shall be responsible for the electricity and water supply for the Works. In addition, the Contractor shall also be responsible for all necessary connection and disconnection of temporary water and power supply at its own expense. Before commencing these temporary connection works, the Contractor should notify in advance to the Employer and seek his approval. Upon the completion of the Works, the Contractor shall be required to reinstate the original facilities to the satisfaction of the Employer at his own costs.
- 9.22.2 Checking of meter and/or tariff meter is required to record the consumption of electricity and water if necessary.
- 9.22.3 The whole temporary installation is to comply with the relevant regulations and statutory requirements approved by the government authorities.

10. Technical Specifications

10.1 Scope of Works

- 10.1.1 This Contract comprises the provision of all necessary materials and labour to carry out the renovation works of the Innovation Center for the Construction Industry Council, all as detailed on the Drawings, General Specifications, these Specifications and other parts of the tender documents.
- 10.1.2 The renovation is mainly consisting for the following area which stated on the details drawings as attached:
 - (i) Outdoor Area;
 - (ii) Reception Area;
 - (iii) Office Area;
 - (iv) Exhibition Area 1;
 - (v) Exhibition Area 2;
 - (vi) Focus Group Meeting Room 1; and
 - (vii)Focus Group Meeting Room 2
- 10.2 The Site
- 10.2.1 The site of this works project is situated at G/F, 44 Tai Yip Street Kowloon Bay, Hong Kong ("the Site").
- 10.3 <u>Preliminary Items</u>
- 10.3.1 The Preliminary Items included hereunder apply to the whole of the Works contained in this Specifications and the amount inserted by the Contractor in the Summary of Tender shall be deemed to apply to the whole of the Works carried out under this Contract.
- 10.3.2 In the event of no amount being inserted by the Contractor in respect of preliminaries, in the Summary of Tender, the value thereof will be deemed to

have included in the cost of the work specified hereinafter and no separate amount whatsoever will be certified for payment.

10.4 Contractor's Visit to the Site

10.4.1 Before tendering, the Contractor shall visit the Site and satisfy himself as to the accessibility of the Site and the extent and character of the operations as no claim due to any neglect in this respect will be entertained.

10.5 <u>Programming and Completion of the Work</u>

10.5.1 The Contractor's particular attention is drawn to the fact that the works to the premises under this Contract must be carried out in co-operation with and agreement of the supervisor of the premises to allow reasonable operation of the premises and completed within the period stated on the Form of Tender.

10.6 Work Inclusive in the Contract

- 10.6.1 The Contractor's prices for the items contained in the Contract shall be deemed to include the cost of all incidentals of labour, materials, all cutting and waste, packings, cartage, risk, moving, hoisting and fixing in the required position, scaffolding, plant, ladders, platforms, supervision, profit and all things and matters necessary for the carrying out of and for the timely and satisfactory completion of the entire works contained in the Contract and Specifications, such be expressed or not.
- 10.6.2 All the materials to be used in permanent works described in these Specifications shall be taken as new.

10.7 <u>Lump Sum Tender with Part Remeasurement</u>

- 10.7.1 The tender shall be a Lump Sum Contract with part remeasurement for carrying out of the whole of the Works in conformity with the Specifications and Drawings. Those items in the Schedule of Rates that are subject to remeasurement are stated as being measured provisional.
- 10.7.2 Tenderers must include an itemized breakdown in their tenders and a detailed and comprehensive Schedule of Works required and included in the tender.

- 10.7.3 The CIC will not be liable for any expense incurred by the Contractor in connection with the measurement of variations or the adjustment and settlement of accounts.
- 10.8 Specifications
- 10.8.1 The Contractor shall be deemed to have examined the following Specifications including all current Corrigenda applicable to this Contract:
- 10.8.2 Similar codes or standards used in the home country of the manufacturer may, however, be used if applicable, subject to the acceptance of the appropriate Hong Kong Government Departments or other authorities. In such case it shall be the responsibility of the manufacturer to prove to the satisfaction of the Architect/Engineer that such codes are essentially equal to the one specified.
- 10.8.3 Unless otherwise specified, the complete building services installation shall comply with the latest editions from time to time of the following documents:
 - (a) British Standards Specification (BS or B.S.S.)
 - (b) The Hong Kong Building (Construction) Regulations, current edition, and fire services requirements
 - (c) Building Ordinance (Chapter 123) and Building (Planning) Regulations
 - (d) Electricity Ordinance (Chapter 406)
 - (e) Water Work Ordinance (Chapter 102)
 - (f) Building Energy Efficiency Ordinance (Chapter 610)
 - (g) Hong Kong Waterworks Standard Requirements for Plumbing Installation in Buildings and all Circular Letters
 - (h) The Supply Rules and the Installation Guide of the power supply company of latest edition, issued by The Hong Kong Electric Co. Ltd.
 - (i) The latest edition of the Wiring Regulations and the subsequent amendments published by the Institution of Electrical Engineers (IEE), United Kingdom.
 (BS7671) The IEE Wiring Regulations hereinafter in this Specification

- being referred to shall mean the latest edition and all subsequent amendments.
- (j) The latest edition of standards from CIBSE and ASHRAE particularly on safety codes
- (k) Regulations of the Telecommunication Authority, Hong Kong
- (l) Codes of Practice for the Electricity (Wiring) Regulations (Latest Edition) published by Electrical & Mechanical Department, Hong Kong Government.
- (m) Code of Practice for Energy Efficiency of Building Services Installation latest edition published by Electrical & Mechanical Department.
- (n) Hong Kong Fire Services Department Code of Practice for Minimum Fire Service Installations and Equipment), latest edition; and F.S.D. Circular Letters.
- (o) Rules for Automatic Sprinkler Installations by the Loss Prevention Council (BS 5306 Part 2) and Technical Bulletins.
- (p) Hong Kong Water Authority Regulations.
- (q) LPC. Rules for Automatic Fire Detection and Alarm Installations for the Protection of Property.
- (r) BS 5839 : Part 1 : 1988 for the Installation of Automatic Fire Detection and Alarm Systems for Buildings.
- (s) National Fire Protection Association (NFPA) Codes & Standards, USA.
- (t) Design Manual : Barrier Free Access latest edition issued by the Buildings

 Department
- (u) The Chartered Institution of Building Services Engineers (CIBSE) Lighting Guides, Latest Edition, and subsequent amendments.
- (v) All other Authorities having jurisdiction.

- 10.8.4 Unless otherwise specified, the complete installation shall comply with the specification of latest editions from time to time of the following documents:
 - (a) General Specification for Air-Conditioning, Refrigeration, Ventilation and Central Monitoring & Control System Installation in Government Buildings of latest edition and subsequent amendment issued by Architectural Services Department, HKSAR
 - (b) General Specification for Electrical Installation in Government Buildings of latest edition and subsequent amendment issued by Architectural Services Department, HKSAR
 - (c) General Specification for Fire Services Installation in Government Buildings of latest edition and subsequent amendment issued by Architectural Services Department, HKSAR
 - (d) General Specification for Plumbing and Drainage Installation in Government Buildings of latest edition and subsequent amendment issued by Architectural Services Department, HKSAR

10.9 Specialist Contractors

i) LICENSED PLUMBER

- 10.9.1 All plumbing works of fire services installation and HVAC installation shall be executed by a Licensed Plumber Grade 1, registered at Water Authority. Copy of the license of the plumber and the job reference of the plumber shall be submitted with the tender for consideration.
- 10.9.2 Water sample shall be collected and tested by Recognized Laboratory in HKSAR and submit report showing compliance with Water Authority requirements upon work completion.

ii) REGISTERED ELECTRICAL CONTRACTOR/WORKERS

10.9.3 All electrical works shall be executed by registered electrical contractor and workers from EMSD of appropriate grade. Copy of the certificate of registered

electrical contractor and worker and their job reference shall be submitted with the tender for consideration.

iii) REGISTERED FIRE SERVICES CONTRACTOR

10.9.4 The whole fire services installation shall be executed by registered fire contractor of appropriate grade. Copy of the registered certificate and job reference shall be submitted for consideration. The fire services contractor shall within the approved list of FS contractor from Housing Department.

iv) REGISTERED SECURITY CONTRACTOR

10.9.5 All security systems of this project shall be executed by registered security contractor. Copy of the registered certificate and job reference shall be submitted for consideration.

v) FIRE SERVICES MAINTENANCE CONTRACTOR

10.9.6 The fire services installation interfacing work, drain-off and refilling of wet system, isolation of AFA system, etc. that related to the building communal system shall be executed by Fire Services Maintenance Contractor. The Contractor shall appoint the Fire Services Maintenance Contractor to execute the prescribed works.

vi) REGISTERED VENTILATION CONTRACTOR

- 10.9.7 Complete air-conditioning installation and mechanical ventilation installation shall be executed by registered ventilation contractor.
- 10.9.8 Copy of the registered certificate and job reference shall be submitted for consideration.

vii) REGISTERED MINOR WORK CONTRACTOR

10.9.9 Complete building services installation with works fall within the Minor Works Control by Buildings Department that shall be executed by Registered Minor Work Contractor including appointment of Authorized Person and/or Registered Structural Engineer if necessary.

10.10 <u>Coordination with Authorities</u>

i) Buildings Department

10.10.1 The Contractor shall attend all inspections by Buildings Department. The Contractor shall provide all information including drawings for application and final submission of premises.

ii) Water Authority

- 10.10.2 The Contractor shall submit all application, drawings, Forms to Water Authority as required for the Work. The Contractor shall also co-ordinate with WA regarding the inspections by Water Authority during the Work, on completion, water mains connection and water meter installation.
- 10.10.3 The Contractor shall carry out a water sample test to the requirement of Water Authority. The Contractor shall provide all information including drawings for final submission of plumbing drawings.
- 10.10.4 The Contractor shall arrange to pick up all water meters from Water Authority and to install at positions as shown on the approved drawings.

iii) Electricity Supplies Company

10.10.5 The Contractor shall submit drawings, forms, etc. to Electricity Supply Company as required for the Works. The Contractor shall attend all inspections requested by Electricity Supplies Company - wiring test, meter installation, etc.

iv) Fire Services Department

- 10.10.6 The Contractor shall submit Form 314 including preparation of associated drawings for submission, submit Form 501 and attend all inspections by Fire Services Department for the issuance of Fire Certificate.
- 10.10.7 The Contractor shall submit drawings of HVAC installation to Fire Services Department, if required for the Works.

v) Telecommunication Companies

- 10.10.8 The Contractor shall co-ordinate with all telecommunication companies on the provision of required facilities for telephone equipment and incoming cables.
 And arrange to handover the facilities to Telecommunication Companies.
- vi) Electrical and Mechanical Services Department
- 10.10.9 The Contractor shall attend all inspections by Electrical and Mechanical Services Department as required for the Work.
 - (a) Allow for any financial obligations imposed by the Preliminaries of the General Specification.
 - (b) The General Specification can be downloaded from Architectural Services Department website below: http://www.archsd.gov.hk/en/publications-publicity/publications.aspx

10.11 <u>Material General</u>

- 10.11.1 All materials shall be of an approved brand and type fixed and applied strictly, in accordance with the manufacturer's instructions and to the Consultant's satisfaction. Materials shall be submitted to the Consultant for approval whenever required.
- 10.11.2 The Contractor shall submit colour and tint cards and all colour schemes shall be approved by the Consultant before the work is commenced.
- 10.11.3 The Contractor shall also submit a sample board of electrical accessories proposed to be used in the electrical work for the approval of the Consultant prior to the commencement of the work.
- 10.11.4 The Contractor is deemed to have allowed in his tender all materials required for the completion of the works, including possible shortfall in spare materials already provided in the premises by the CIC. No claims for extra cost to the Contract in this respect will be entertained without reasonable substantiation.

10.12 <u>Compliance with Specifications</u>

10.12.1 Unless otherwise overridden by this Specifications or Drawings, all materials and workmanship shall comply with all the relevant sections of the Specifications as stated in Clause above and all the subsequent amendments issued prior to the date of tendering.

10.13 <u>Schedule of Material and Equipment</u>

10.13.1 The tenderer is required to state the type, model and make of all materials / equipment proposed to be used in this Contract. The tender may be considered invalid without submission of such information from the tenderer.

10.14 <u>Drawings and Specifications Generally</u>

10.14.1 The drawings and Specifications shall be understood to indicate the form, dimensions, class and description of materials and standard of workmanship to be used but shall not be taken to embody each and every detail or process or refinement of form or construction proper to the standard of product required under this Contract.

10.15 Dimensions

- 10.15.1 All disparities, incompatibilities or conflict between dimensions or between dimensions and scale shall be referred by the Contractor to the Consultant for clear instruction before proceeding with the relevant work and the Consultant's decision and the instruction shall be binding on both parties to the Contract. The CIC will not be responsible for the cost of any unapproved work constructed in error by the Contractor or his staff not having observed this condition.
- 10.15.2 Figured dimensions are to be taken in preference to scaled in all cases. Before commencing any work or ordering any materials the Contractor must verify all measurements. If any discrepancies are found they must be brought to the notice of the Consultant immediately.

10.16 Removal of Rubbish and Debris During the Progress of Fitting Out Work

10.16.1 All accumulations of rubbish and debris during the progress of fitting out work shall be cleared and carted away daily, notwithstanding that this debris may be left over by nominated supplier and sub-contractors associated with the project, during the progress of the contract to the satisfaction of the Consultant and the CIC.

10.17 <u>Existing Defects</u>

10.17.1 The Contractor shall draw the CIC's attention to any existing defects found in connection with the works required to be carried out in this contract, and work shall not be commenced until the CIC has issued his instruction.

10.18 Workmanship

10.18.1 Workmanship shall be of the best quality, and shall be carried out by tradesman skilled in their particular trades and following the best of sound trade practice.

10.19 Safe Custody of Materials

- 10.19.1 The Contractor will be responsible for the safe custody of any materials delivered on to the site. The Contractor shall endorse receipt upon delivery to site and provide suitable and adequate space and lock-up rooms for storage as required by other suppliers and specialist contractors. He will be required to reinstate at his own expense any such materials that may be lost or stolen.
- 10.19.2 The Contractor will also be required to reinstate at his own expense any material or article damaged by careless handling or storage or interior workmanship by his workmen either in the original fixing or in the subsequent taking down and re-fixing thereof.

10.20 Safety Precautions

10.20.1 The Contractor shall comply with laws and regulations enacted by local statutory bodies for safety on the Site.

10.21 <u>Defects after Completion</u>

10.21.1 The Contractor must make good any defects, shrinkages or other faults which shall appear within the Defects Liability Period in accordance with the Conditions of Tender Fee Proposal or the Contractor may have the defects made good at his expense by local contractor approved by the Consultant.

10.22 <u>Samples/Mock Up</u>

- 10.22.1 The quality of materials and articles supplied for any purpose are to be submitted for consideration prior to their use in the works. Wherever practicable samples are to be submitted for consideration before bulk supplies are delivered to the site. Samples, and any packing of same, are to be provided free of charge by the Contractor.
- 10.22.2 Mock up to be provided free of charge by the Contractor for items listed in these specifications.
- 10.22.3 Three (3) samples are to be submitted for the Consultant's approval.
- 10.22.4 Approved samples are to be kept on site to serve as standards for the materials or goods represented by the samples.
- 10.22.5 Should any material or article be rejected it shall be removed from the site at the Contractor's expense. The Contractor shall provide samples of workmanship for all trades and obtain the Consultant's approvals prior to commencement of each trade.
- 10.22.6 Spare materials are to be provided to CIC for future use.

10.23 House Rules

- 10.23.1 The Contractor shall carry out all Works in accordance with the rules, regulations and conditions as may be stipulated by the building owner and/or property management.
- 10.23.2 It is the Contractor's responsibility to be fully aware of the above requirements and allow for any necessary provisions in his tender sum.

- 10.23.3 No nuisance work could be carried out during office hours. All noisy / smelly dusty work shall be carried out in the night time or during weekend.
- 10.24 Night Time Work
- 10.24.1 Night time work may be carried out at the discretion of the Contractor, on the condition that he shall obtain prior approval from the property management in respect of access and security clearance.
- 10.24.2 No claim for extension of time and/or costs shall be considered by the Consultant if the Contractor is prevented from carrying out night time work.
- 10.25 Daily Reports, Photographs and Programme
- 10.25.1 The Contractor shall prepare daily reports and photographs in a format to be approved by the Consultant and shall submit the reports weekly. The Contractor shall provide photographs of the works as and when directed by the Consultant.
- 10.25.2 The Contractor shall submit to the Consultant for approval a detailed programme showing his intended method, sequence, stages and order of proceeding with the Works together with the period of time he has estimated for each and every such stage of progress. Whilst it is not required to be submitted with the Form of Tender, provision and approval of such a detailed programme will be condition precedent to the acceptance of the Tender.
- 10.25.3 If during the course of the Contract special circumstances should arise which in the opinion of the Consultant warrant or necessitate a revision or departure from the order of procedure as shown in the approved programme, then the Contractor shall accordingly revise his programme as the Consultant may require.
- 10.25.4 In order that the programme may be maintained or amended where necessary it is incumbent upon the Contractor to notify the Consultant whenever there is the likelihood of a delay occurring in his own work or material supplies or in those of any of his Sub-contractors.
- 10.25.5 The submission to and approval by the Consultant of such programme (and revisions if applicable) shall not relieve the Contractor of any of his duties or responsibilities under the Contract.

- 10.25.6 Submit to the Consultant at weekly intervals reports on the general progress of the Works and detailing any information required, extension of Contract Period claimed, etc.
- 10.25.7 No claims for extension of the Contract Period will be considered if submitted later than seven days after the event. The acceptance or otherwise of such claims will be at the discretion of the Consultant.
- 10.26 Protect and Repair Damage to Property, Utilities etc.
- 10.26.1 The Contractor is to protect in all ways building and other property or things which may be disturbed or damaged during the execution of the Works. The Contractor shall provide hoarding and protection to seal off elevator doors.
- 10.26.2 The Contractor shall be entirely responsible for ensuring that no damage is caused by his work crew including sub-contractors (whether nominated or not) and if any such damage is caused he shall be entirely responsible for the entire cost of reinstatements whether carried out by himself or others.

10.27 Protection of Public

10.27.1 The Contractor is to take every precaution necessary to protect the public from injury or death during the course of the Works.

10.28 Visitors

10.28.1 The Contractor will not allow any unauthorized visitors on the site and is to keep a visitors book with clear warning that the CIC and the Contractor shall be indemnified against any claim for death or injury to persons authorized to visit the site and provide safety helmets for such visitors.

10.29 Completion

10.29.1 On completion of the work and before handing over the Works, the floors, glass, fittings, tiling, ironmongery, paintwork, etc. are to be thoroughly washed and/or cleaned down using proper detergents, scrapers, scrubbing brushes, etc., all windows, drawers, doors and hardware eased and tested exposed metalwork shall be polished as necessary and the premises left clean and fit for occupation.

- 10.29.2 All plant, rubbish, crates, containers, surplus materials, etc. are to be removed and the Works and Site adjacent thereto left clean and tidy.
- 10.29.3 Labelled keys and guarantees shall be handed to the CIC on or before the Date for Practical Completion.

10.30 Renovation Works

10.30.1 The Contractor is requested to be fully aware of the requirements related to the Base Building Finishes and Services. The Contractor shall abide to all requirements contained in Landlord Fit-Out Guidelines and Rules if any.

10.31 Setting-Out

- 10.31.1 The Contractor must set out all items with respect to shop demise lines, partitions, and built-in services system furniture etc. shown on plans for the approval of the Consultant prior to construction.
- 10.31.2 The Contractor shall be responsible for setting out of the work from the working drawings with accuracy. Any errors resulting from inaccurate setting out must be rectified at the Contractor's expense.
- 10.31.3 The Contractor shall provide all necessary instruments and labour as required by the Consultant free of cost to check the setting out work done by the Contractor. Notwithstanding such checking, it shall not in any way to relieve the Contractor of his responsibility for the correctness thereof.

10.32 Approval of Chief Inspectorate of Fire Services

10.32.1 All interior works, where applicable must comply with the flame spread classification and fire resistant requirements laid down hereinafter by the Director of Fire Services. The Contractor shall produce certificates from the Director of Fire Services and manufacturer's tests certificates to substantiate compliance with the said stipulations of materials to be supplied and installed. If the approval of the Director of Fire Services of any materials installed is not substantiated, it shall be removed from the site at the Contractor's own expenses.

10.33 Sign Board

- 10.33.1 The Contractor is to provide a sign board at an approved location at the Site according to Detail Drawing.
- 10.33.2 All lettering and writing shall be carried out by an approved sign writer to be employed by the Contractor. Sketch/draft of all lettering and writing shall be submitted to the Consultant for approval prior to execution.

10.34 <u>Organization Chart and Foreman</u>

- 10.34.1 The Contractor shall submit an Organization Chart with details of the proposed project personnel and their qualification for the Consultant's approval.
- 10.34.2 The Contractor shall keep a competent general foreman, literate in English, constantly on the site.

10.35 <u>Making Good Damages</u>

10.35.1 The Contractor shall reinstate damages along the access route and in areas outside the works areas caused during the course of the work to the satisfaction of the Consultant.

10.36 Working Hours, Rates of Wages etc.

10.36.1 The Contractor shall comply with any current legislation or regulations regarding working conditions, working hours, or rates of payment to employees and accept the risk of any impending legislation or other condition which alters any obligations or imposes new obligations. He shall also conform to the Construction Workers Registration Ordinance.

10.37 Plant Tools, Scaffolding, etc.

10.37.1 The Contractor shall provide and maintain in good working order all mechanical equipment, plant, tools, implements, ladders, tarpaulins and the like necessary for the proper and timely execution and protection of the work.

10.38 Statutory Obligations, Notices, Fees and Charges

- 10.38.1 The Contractor shall comply with and give all notices required by any Act or Ordinance (including the Construction Workers Registration Ordinance) of Government any instrument, rule or order made under any Act or Ordinance of Government, or any regulation or by-law of any local authority or of any statutory undertaker which has any jurisdiction with regard to the Works or with whose systems the same are or will be connected.
- 10.38.2 The Contractor shall bear the cost of any fees or charges (including any rates or taxes) legally demandable under any Act or Ordinance of Government, any instrument, rule or order made under any Act or Ordinance of Government, or any regulation by law of any local authority or of any statutory undertaker in respect of the works.
- 10.38.3 The Contractor shall comply with the Labour Department's regulations for safety on work sites.
- 10.38.4 The Contractor shall be responsible for the liaison and subsequent approval from utility companies, Water Authority and other relevant Government Authorities in order to acquire sufficient electricity and water supply for future consumption of the premises.

10.39 Shop Drawings

- 10.39.1 Shop drawings, as may be required, shall be furnished by the Contractor well before the work proceeds and in any case within two weeks of the Consultant's request. The Consultant may reject, approve or amend such shop drawings. No claim will be accepted for disapproval or amendments required by the Consultant.
- 10.39.2 The approval by Consultant of any such drawings shall not relieve the Contractor of his duties and responsibilities under this Contract.

10.40 Record Drawings

10.40.1 The Contractor shall within one month from the date of practical completion provide a set of "as-built" record drawings for the whole project to Consultant

for checking and three sets of approved "as-built" record drawings in hard copy and one set in soft copy shall be submitted subsequently for record.

10.41 Labour

- 10.41.1 The Contractor shall provide and employ on the site in connection with the execution and maintenance of the work:
 - (a) Only such technical assistants as are skilled and experienced in their respective callings and such sub-agents, foremen and leading hands as are competent to give proper supervision to the work they are required to supervise; and
 - (b) Such skilled, semi-skill and unskilled labour as is necessary for the proper and timely execution and maintenance of the work.
- 10.41.2 The Consultant shall be as liberty to object to and require the Contractor to remove forthwith from the Work any person employed by the Contractor who in the opinion of the Consultant misconducts himself or is incompetent or negligent in the proper performance of his duties or whose employment is otherwise considered by the Consultant to be undesirable and such person shall not be again employed upon the Work without the written permission of the Consultant.

10.42 Sub-letting

10.42.1 The Contractor shall not assign the Contract. The Contractor shall not sub-let any part of the works without the written consent of the Consultant.

10.43 Protection of Materials etc.

10.43.1 The works and materials shall be kept safe from fire hazard and the Contractor shall take all possible precautions and provide all necessary fire fighting equipment and properly trained staff. The Contractor shall protect all works and materials from inclement weather.

10.44 Testing of Materials

10.44.1 The Contractor shall carry out tests on all materials required by the Consultant to be tested at the Contractor's own expense and shall pay all charges in connection with tests ordered by the Consultant to be carried out by others.

10.45 Contractor to Give Notice of Injury

10.45.1 In the event of any workman or other person employed on the Works or in connection with the Contract suffering any personal injury and whether there be a claim for compensation or not, the Contractor shall without delay give notice in writing of such personal injury to the Consultant.

10.46 Workmen Living on Site

10.46.1 No workmen will be allowed to live on the site.

10.47 <u>Prevention of Mosquito Breeding</u>

10.47.1 All items on the site, including construction plant, capable of retaining water shall be so stored, covered or treated as to prevent water collection in them. The Contractor shall, at his own expense, treat any standing water on the site with approved oil and take other necessary measures to prevent mosquito breeding on the site.

10.48 Site Clearance

- 10.48.1 The Contractor shall remove all his equipment and belongings on site before completion/sectional completion of the works at the Site.
- 10.48.2 Any damages to lawns, property, etc. shall be made good by the Contractor at his own expense, including fences, gates, etc., which have to be removed temporarily for access.

10.49 Accept Site as Found

- 10.49.1 The Contractor shall accept the site found on the Date for Possession and at his own expense clear the site of any debris which may have been left on the site.
- 10.49.2 Possession of the site is given to the Contractor subject to statutory inspections to be carried out by relevant authorities. The Contractor shall allow access by the

authorities and by the Contractor of the authority to carry out the inspections and any subsequent remedial works. Any necessary co-ordination and attendance by the Contractor is deemed to have been allowed in the Contract.

10.50 <u>Compensation for Delay</u>

10.50.1 The Contractor shall be fully responsible for any suspension of work ordered by the Authorities due to excavations, disturbances, nuisance, excessive smoke of machinery etc., during the execution of work and no claim for any extra expense, overhead charges and time loss arising from the suspension of work will be allowed.

10.51 Restrict Nuisance of Dust and Noise

10.51.1 The Contractor shall take all necessary steps to restrict the nuisance of dust and noise, and comply with the requirements of the relevant Government departments. Pneumatic drills shall be fitted with silencers. Compressors shall be in good order to run as quietly as possible and shall be placed in position as far as possible from adjoining premises. The Contractor shall take care to abate the nuisance caused by dust and shall sprinkle dusty areas with water frequently.

10.52 General Compliance to Buildings Ordinance

10.52.1 The Contractor shall discharge all the duties as required by the Buildings Ordinance (Cap. 123) as performed as the Registered General Building Contractor (RGBC) and the Registered Specialist Contractors, where applicable, to complete the Works. All statutory charges, fees and any other related costs and wages, salaries of any personnel required for the appliance of the Ordinance shall be borne by the Contractor.

10.53 General Description of the Builders Works for Different Area

(Refer to Design Drawing No.: PL-01 to PL-10 and EL-01 to EL-27)

10.53.1 Main Entrance

It mainly consists of an Outdoor Area, a Reception, a Lounge Area.

i) Outdoor Area

- Supply and install a new Logo arch
- Modify & replacement of windows & doors.
- Supply and install graphic film stickers on the glass of main entrance area.
- There is a timber surface raised floor (600mm_H) decking need to be repaired and additional layer of timber floor finished will be put on the existing floor.
- Supply and install additional lighting.
- Supply and install a new electrical blind with a rolled-typed needed to be installed the glass wall between outdoor area and Focus group meeting room 1.
- Supply and install a new access card systems need to be installed in the main entrance area. Supply and install 2 Led Display wall
- Supply and install plastic laminated films on the glass partition between the area of outdoor and reception.
- Supply and install decorative artificial plants flower back wall will need to be constructed in the relaxation area in left hand side of the outdoor area.
- A fitting bench seating will be constructed in front of the flower back area.

10.53.2 Reception

- There is a screen wall behind the reception desk facing the main entrance. LED
 display on the wall facing the entrance. On the back of the wall, repainting is
 needed.
- A lounge area for the guest's waiting or mind surfing needed to be constructed.

10.53.3 Office Area

- It mainly consists of a general office Area and a CEO office.
- Supply and install standard glass frame for meeting room & CEO room
- Supply and install standard office furniture

10.53.4 Exhibition Area

- It mainly consists of Exhibition Area 1 & 2 and the Exhibition areas (1 & 2) are interlinked by opening the glazed doors forming one big venue when required.
- Supply and install glass partition between office & exhibition Area.
- Supply and install curved column With TV Display
- Supply and install a new operable wall between the Exhibition Area 1 & 2.
- Supply and install a magnetic projection wall with special paint finished. This is an
 interactive wall which could enable the functions of projecting, writing and
 Magnetic functional.
 - 3nos. of projection wall next to the office
 - 4nos. of projection wall outside of multi-function rooms. The wall must be
 finished by projection paint with Screen Goo high contrast finish coat.
- Keep the existing TV wall in the Exhibition Area 1.
- Dismantle the existing floor of exhibition 1 area and fill up with 4" light concrete

and finished the top with Vinyl

- Supply and install a new sliding ceiling Track and fixed to the structural ceiling.
- Supply and install the sitting bench and platform in the Exhibition Area 1.

10.53.5 Focus Group Meeting Room Area

- This room generally serves the functions as a theatre with about 158 seats.
- The room should be acoustically well insulated and equipped with AV equipment for presentation and lectures.
- Construct a wall as illustrated in the design drawings.
- Tuning up the existing operable wall to a new surface finished as illustrated in the design.
- Extend the existing operable wall to fit for the design.
- Repaint of existing ceiling with black paint
- Supply & install the LED lights to the ceiling wall as illustrated on the design drawings.
- Supply & install the new carpet in both the focus group meeting rooms

10.53.6 AV Equipment

- Keep existing 3 Projectors and screen
- Supply & install 3 additional projectors and 2 TVs
- Supply & install control system which could be able to master control the lighting, electricity blinding, audio and AV system.

10.53.7 Lavatory

- Resize the existing disabled toilet as illustrated on the design drawings.
- Decorate all the existing toilets by including but not limited to adding decorative
 pictures / wall murals, changing or adding of light fittings, etc. Make good any
 defective items or parts in the toilets as necessary.

Tender Document for

Fit-out and Building Services Installation Works for CIC Innovation Centre (IC)

BEAM Plus Technical Specification

Prepared by





Table	of Contents	
1.	Introduction	5
1.1.	Objectives	5
2.	General Requirements	6
2.1.	Specification	6
2.2.	Commitment to BEAM Plus Requirements	7
2.3.	Quality Assurance (QA)	8
2.4.	Monitoring Plan and Pre-Construction Requirements	8
2.5.	Documentation	8
3.	Compliance with Regulations	9
4.	Definitions	9
5.	Compliance Documentation Required	10
6.	Construction Safety (BEAM Plus MAN P1)	10
6.1.	Tasks to be implemented	10
6.2.	Specific Requirements	10
6.3.	Submittal Documentation	10
7.	Construction IAQ Management (BEAM Plus MAN 2)	11
7.1.	Tasks to be implemented	11
7.2.	Specific Requirements	11
7.3.	Submittal Documentation	11
8.	Construction Noise (BEAM Plus MAN 3)	12
8.1.	Tasks to be implemented	12
8.2.	Specific Requirements	12
8.3.	Submittal Documentation	12
9.	Use Of Non-CFC Based Refrigerants (BEAM Plus MA P1)	12
9.1.	Tasks to be implemented	12
9.2.	Specific Requirements	12
9.3.	Submittal Documentation	12
10.	Minimum Waste Recycling Facilities (BEAM Plus MA P2 & MA 1)	12
10.1.	Tasks to be implemented	12
10.2.	Specific Requirement	13
10.3.	Submittal Documentation	13
11.	Timber Used for Temporary Works (BEAM Plus MA P3)	13
11.1.	Tasks to be implemented	13
11.2.	Specific Requirements	13
11.3.	Submittal Documentation	13
12.	Interior Components Reuse (BEAM Plus MA 2)	14
12.1.	Tasks to be implemented	14
12.2.	Specific Requirements	14
12.3.	Submittal Documentation	14
13.	Furniture And Partitions (BEAM Plus MA 3)	15
13.1.	Tasks to be implemented	15
13.2.	Specific Requirements	15
13.3.	Submittal Documentation	15
14.	Modular Design Materials (BEAM Plus MA 4)	16
14.1.	Tasks to be implemented	16
14.2.	Specific Requirements	16
14.3.	Submittal Documentation	16

TECHNICAL SPECIFICATION

15.	Designed For Disassembly (BEAM Plus MA 5)	17
15.1.	Tasks to be implemented	17
15.2.	Specific Requirements	17
15.3.	Submittal Documentation	17
16.	Sustainable Flooring Products (BEAM Plus MA 6)	18
16.1.	Tasks to be implemented	18
16.2.	Specific Requirements	18
16.3.	Submittal Documentation	19
17.	Sustainable Ceiling Products (BEAM Plus MA 7)	19
17.1.	Tasks to be implemented	19
17.2.	Specific Requirements	19
17.3.	Submittal Documentation	20
18.	Sustainable Wall and Door Products (BEAM Plus MA 8)	20
18.1.	Tasks to be implemented	20
18.2.	Specific Requirements	21
18.3.	Submittal Documentation	21
19.	Zero PVC (BEAM Plus MA 9)	22
19.1.	Tasks to be implemented	22
19.2.	Specific Requirements	22
19.3.	Submittal Documentation	23
20.	Ozone Depletion Substances (BEAM Plus MA 10)	23
20.1.	Tasks to be implemented	23
20.2.	Specific Requirements for Monitoring and Auditing	23
20.3.	Submittal Documentation	23
21.	Demolition And Construction Waste Reduction (BEAM Plus MA 11)	24
21.1.	Tasks to be implemented	24
21.2.	Specific Requirements for Monitoring and Auditing	24
21.3.	Submittal Documentation	24
22.	Energy Efficient Appliances (BEAM Plus EU 2)	25
22.1.	Tasks to be implemented	25
22.2.	Specific Requirements for Monitoring and Auditing	25
22.3.	Submittal Documentation	25
23.	Commissioning (BEAM Plus EU 3)	25
23.1.	Tasks to be implemented	25
23.2.	Commissioning Plan and Scopes	26
23.3.	Commissioning Report	27
23.4.	Specific Requirements for Monitoring and Auditing	28
23.5.	Submittal Documentation	29
24.	Operations & Maintenance (BEAM Plus EU 4)	29
24.1.	Tasks to be implemented	29
24.2.	O&M Manual	30
24.3.	Energy Management Manual	31
24.4.	Specific Requirements for Monitoring and Auditing	32
24.5.	Submittal Documentation	32
25.	Metering and Monitoring (BEAM Plus EU 5)	32
25.1.	Tasks to be implemented	32
25.2.	Specific Requirements for Monitoring and Auditing	32
25.3.	Submittal Documentation	33
26.	Water Quality Survey (BEAM Plus WU 1)	33

26.1.	Tasks to be implemented	33
26.2.	Specific Requirements for Monitoring and Auditing	33
26.3.	Submittal Documentation	33
27.	Annual Water Use (BEAM Plus WU 2)	33
27.1.	Tasks to be implemented	33
27.2.	Specific Requirements for Monitoring and Auditing	33
27.3.	Submittal Documentation	34
28.	Effluent Discharge to Foul Sewers (BEAM Plus WU 3)	34
28.1.	Tasks to be implemented	34
28.2.	Specific Requirements for Monitoring and Auditing	35
28.3.	Submittal Documentation	35
29.	Indoor Air Quality (BEAM Plus IEQ 1)	35
29.1.	Tasks to be implemented	35
29.2.	Specific Requirements for Monitoring and Auditing	37
29.3.	Submittal Documentation	37
30.	Indoor Planting (BEAM Plus IEQ 2)	38
30.1.	Tasks to be implemented	38
30.2.	Specific Requirements for Monitoring and Auditing	38
30.3.	Submittal Documentation	38
31.	Pre-Occupancy Flush Out (BEAM Plus IEQ 4)	38
31.1.	Tasks to be implemented	38
31.2.	Specific Requirements for Monitoring and Auditing	39
31.3.	Submittal Documentation	39
32.	Tenant Exhaust (BEAM Plus IEQ 5)	39
32.1.	Tasks to be implemented	39
32.2.	Specific Requirements for Monitoring and Auditing	39
32.3.	Submittal Documentation	39
33.	Uncontrolled Ventilation (BEAM Plus IEQ 6)	39
33.1.	Tasks to be implemented	40
33.2.	Specific Requirements for Monitoring and Auditing	40
33.3.	Submittal Documentation	40
34.	Interior Lighting Quality (BEAM Plus IEQ 8)	40
34.1.	Tasks to be implemented	40
34.2.	Specific Requirements for Monitoring and Auditing	40
34.3.	Submittal Documentation	40
35.	Acoustics (BEAM Plus IEQ 11)	40
35.1.	Tasks to be implemented	41
35.2.	Specific Requirements for Monitoring and Auditing	41
35.3.	Submittal Documentation	41
36.	Features Considered as Innovation	42
36.1.	Tasks to be implemented	42
36.2.	Specific Requirements for Monitoring and Auditing	42
36.3.	Submittal Documentation	43

SPECIFICATION

1. Introduction

FOR CIC INNOVATION CENTRE (IC)

1.1. Objectives

The development at CIC Innovation Centre (IC) is committed to achieving BEAM Plus Certification while providing environmental leadership in all aspects of construction and fit-out works, and shall be certified under *BEAM Plus Interiors Commercial*, *Retail and Institutional Version* 1.0 (2013.08).

This Specification for BEAM Plus is applicable to the Contractor and all Sub-contractors and suppliers of any tier undertaking Works on this project. The Specification is to be included into the Contractor's sub-contractor tendering documents, to ensure that BEAM Plus requirements in this Specification are achieved leading to the award of credits from the authority bodies.

The Contractor shall have overall responsibility to ensure all construction and installation is completed to enable the award of the BEAM Plus ratings and to ensure all Sub-Contractors and suppliers of any tier comply with the requirements.

All submissions from the Contractor are to be co-ordinated, combined, submissions clearly reviewed and checked for compliance before submission for the BEAM Plus Consultant's approval.

BEAM PLUS

TECHNICAL SPECIFICATION

2. General Requirements

FOR CIC INNOVATION CENTRE (IC)

2.1. Specification

For any Works carried out by the Contractor, Sub-Contractors and suppliers of any tier, the Contractor shall be ultimately responsible for demonstrating compliance with this Specification leading to the award of the BEAM Plus credits listed below:

	BEAM Plus Credits
MAN P1	Construction Safety
MAN 2	Construction IAQ Management
MAN 3	Construction Noise
MA P1	Use of Non-CFC Based Refrigerants
MA P2 & MA 1	Minimum Waste Recycling Facilities
MA P3	Timber Used for Temporary Works
MA 2	Interior Component Reuse
MA 3	Furniture and Partitions
MA 4	Modular Design Materials
MA 5	Designed for Disassembly
MA 6	Sustainable Flooring Products
MA 7	Sustainable Ceiling Products
MA 8	Sustainable Wall and Door Products
MA 9	Zero PVC
MA 10	Ozone Depleting Substances
MA 11	Demolition and Construction Waste Reduction
EU 2	Energy Efficient Appliances
EU 3	Commissioning
EU 4	Operations and Maintenance
EU 5	Metering and Monitoring
WU 1	Water Quality Survey
WU 2	Annual Water Use
WU 3	Effluent Discharge to Foul Sewers
IEQ 1	Indoor Air Quality
IEQ 2	Indoor Planting
IEQ 4	Pre-occupancy Flush Out
IEQ 5	Tenant Exhaust
IEQ 6	Uncontrolled Ventilation
IEQ 8	Interior Lighting Quality
IEQ 11	Acoustics
IV 1	Innovative Techniques

The Contractor shall include all relevant requirement of this specification for all contracts for sub-contractor or suppliers of any tiers.

The Contractor shall be responsible for ensuring, management and co-ordination of all sub-contractors and suppliers of any tiers such that the entire project is in compliance, leading to the award of BEAM Plus credits in this Specification.

The Contractor shall coordinate the input from sub-contractors and suppliers of any tiers and provide a complete package of documentation for submission to the BEAM Plus Consultant for approval and subsequently the authorising bodies of BEAM Plus. The Contractor shall allow for revisions as requested by the BEAM Plus Consultant leading to the award of credits.

The Contractor shall provide and install products and materials in accordance with BEAM Plus requirements and to comply with all requirements of this Specification.

The Contractor shall act in a supporting role to the BEAM Plus Consultant for all design related BEAM Plus credits.

The Contractor shall provide detail drawings, specifications, cost break downs and other information required by the BEAM Plus Consultant during the tender, construction and post-handover stages of the project.

Periodic inspections and audits will be undertaken by the BEAM Plus Consultant. At any time the Contractor may be asked to demonstrate progress against the requirements of this Specification and the submitted and approved documentation (e.g., including provision of supporting documentation).

Periodic inspections and audits shall be undertaken by the Contractor to ensure Subcontractors are making progress against the requirements of this Specification as above, including provision of supporting documentation.

Works completed by others prior to the award of the Contract shall be coordinated by the Contractor on award of the Contract in liaison with the BEAM Plus Consultant. The BEAM Plus Consultant will provide a summary of the following information to be handed over by the contractor of the advance foundation works:

Environmental Management Related Records	Construction waste records including Trip Tickets
	Temporary and permanent timber usage log
Materials Records	Material usage log including regional information of material

The Contractor shall compile and consolidate information provided by the BEAM Plus Consultant from the advance construction work so that such information and any new information resulting from the Contract is reported.

During the course of the Works, the Contractor or any of his sub-Contractors or suppliers of any fail to comply with any of the specified requirements he must, at his cost, nominate and obtain a suitable replacement point(s) to maintain the total credit points achieved on the project. Any such proposes alternatives shall be reviewed and approved by the BEAM Plus Consultant.

2.2. Commitment to BEAM Plus Requirements

The full commitment of the Contractor to the requirements of BEAM Plus is critical for successful implementation and achieving the required credits.

The Contractor shall provide sufficient documentary evidence at the construction stage and the post construction stage so that the required BEAM Plus certification will be achieved.

The Contractor shall be responsive for the completion and signage, both hard and electronic copies, of all relevant submittal forms for BEAM Plus.

The Contractor shall make himself aware of the most updated BEAM Plus certification processes and all supplementary information issued by Hong Kong Green Building Council on the website http://www.hkgbc.org.hk/eng/.

2.3. Quality Assurance (QA)

Document log templates are to be submitted by the Contractor to the BEAM Plus Consultant for approval and they must be approved prior to commencing Works on Site.

If the Contractor, sub-Contractor and/or supplier believes that any component of the building design or materials described elsewhere in the Specifications will not achieve these minimum performance requirements, they are to notify the BEAM Plus Consultant at least 4 weeks prior to purchasing, ordering or installing the relevant system/material.

Under no circumstances shall any nominated or approved product be substituted without the prior written approval of the BEAM Plus Consultant. It is a requirement that any proposed material substitution is accompanied by documentation confirming that the proposed product complies with the relevant BEAM Plus performance requirements detailed in this Specification.

2.4. Monitoring Plan and Pre-Construction Requirements

The Contractor shall collect all the specified compliance documentation and submit to the BEAM Plus Consultant for review at the following stages.

- a. The Contract Tender Review confirm compliance that all credit targeted can be achieved
- b. Obtaining the BEAM Plus Consultant's approval prior to awarding relevant subcontracts - confirm compliance that relevant credits can be achieved.
- c. Prior to ordering relevant materials submit compliance documentation.
- d. 6 weeks prior to Substantial completion of each section of the Works -provide draft submission documentation for all credits for review.
- e. Submission to obtain the BEAM Plus Consultant's approval of all required 2D "As Built" drawings and O&M manuals prior to the handover of the whole Works.

2.5. Documentation

All documentation shall be provided in English. If documentation cannot be provided in English due to limitation from others, the Contractor shall provide an English translation of such documents.

The Contractor shall:

• Provide complete packages of documentation for submission to BEAM Plus and allow for revisions as requested by the BEAM Plus Consultant.

- Provide documentation to the BEAM Plus Consultant to confirm compliance with BEAM Plus requirements prior to ordering products and materials.
- Comply with documentation for each BEAM Plus credit. This shall be made available for review by the BEAM Plus Consultant.
- Submit and maintain a schedule of all sub-contractors and suppliers detailing which credits apply to them prior to awarding any sub-contracts or ordering materials.

Following the review of the Contractor's documentation by the BEAM Plus Consultant and/or certification authority, the Contractor shall review and respond to the comments as instructed by the BEAM Plus Consultant to rectify any defects identified or update any documentation required before any re-submission. The Contractor shall make all changes within 4 weeks of the BEAM Plus Consultant's instruction.

Should the Contractor fail to submit the required documentation in a timely manner, and, in the opinion of the BEAM Plus Consultant jeopardise the achievement of a BEAM Plus credit, the BEAM Plus Consultant will have the full authority to stop the concerned portion of the Works until such a time as the documentation is submitted to the BEAM Plus Consultant and found to be in order.

All submittal document mentioned in this specification is subject to EC's approval.

3. Compliance with Regulations

The Contractor shall comply with the following regulations / requirements in their latest version unless otherwise specified, including all relating addenda and errata:

- Hong Kong Building Environment Assessment Method (BEAM) Society. BEAM Plus: Interiors Commercial, Retail and Institutional. V.1.0 (2013.08)
- IAQ Measurement and report issued by HKAS accredited IAQ Certificate Issuing Body
- The Institution of Lighting Engineers Guidance Notes for the Reduction of Obtrusive Light
- CIBSE Code for Interior Lighting
- CIBSE Lighting Guides
- EMSD Code of Practice for Energy Efficiency of Building Services Installation 2015
- Relevant Local Planning, Environmental Protection and Pollution Control Ordinance
- BD Code of Practice for Fire Safety in Buildings
- ANSI/ASHRAE/IES Standard 90.1-2010 Energy Standard for Building
- ISO 5667-5:2006 Water quality Sampling- Part 5
- BS EN 1434-5:2007. Heat meters. Initial verification tests

4. Definitions

BEAM Plus Hong Kong Building Environment Assessment Method (BEAM) Society. BEAM Plus: Interiors – Commercial, Retail and Institutional. V.1.0 (2013.08)

CFC Chlorofluorocarbons are hydrocarbons that are used as refrigerants and cause depletion of the stratospheric ozone layer.

CxA Commissioning Authority is the individual designated to organise, lead and review the completion of commissioning process activities. The CxA facilitates communication among the employer, EC and Contractor to ensure that complex systems are installed and function in accordance with the employer's project requirements.

VOC Volatile Organic Compounds (defined as organic solvents with a boiling point less than 250°C at 101.3kPa or a vapour pressure of 0.01mm of Hg at 21°C)

Sustainable Timber is timber that comes from sustainably managed forests. These forests are certified in accordance with international standards e.g. Forest Stewardship Council (FSC), The Programme for the Endorsement of Forest Certification (PEFC) who certify forests, manufacturers and suppliers to ensure they are working in accordance with best practice for sustainable forest and timber management.

5. Compliance Documentation Required

All audits, reports, reviews, checklists, data logs and the like shall be submitted by the Contractor to the BEAM Plus Consultant together with the final report.

6. Construction Safety (BEAM Plus MAN P1)

6.1. Tasks to be implemented

The contractor shall implement a Safety Management Plan and update it when necessary during construction and fit-out activities.

The Safety Management Plan shall be provided with the following minimum details:

- Person-in-charge and emergency contact
- Hazard / risk identification
- Public protection controls (e.g. prevent unauthorised access, falling debits)
- Control methods
- Site inspection frequency
- Common plant and equipment used
- Promotion & training
- Personal protection equipment used

6.2. Specific Requirements

The specific requirements to demonstrate credit compliance are detailed in the relevant section of the BEAM Plus Interiors – Commercial, Retail and institutional Version 1.0 (2013.08) Reference Guide and Submission Template.

6.3. Submittal Documentation

- The Contractor shall submit a Safety Management Plan
- The Contractor shall submit records, logbook, site diary, or similar daily monitoring record, to demonstrate that the Safety Management Plan was properly implemented
- The Contractor shall complete the BEAM Plus MAN P1 template and provide all required supporting documents

7. Construction IAQ Management (BEAM Plus MAN 2)

7.1. Tasks to be implemented

The Contractor shall develop and submit a Construction IAQ Management Plan (CIAQMP) to implement adequate mitigation measures that reduce IAQ impacts arising from demolition and fit-out activities.

The CIAQMP shall meet the following minimum requirements:

- Measures to protect the Building Services Installation, its ventilation system components, and air pathway against contamination during construction
- Measures to protect the building components against contamination during construction
- Control measures for HVAC&R system and component protection
- Cleaning procedures to be employed prior to the premises being occupied
- Contaminant Source Control
- Interruption of moisture/pollutant pathways

The Contractor shall provide a Construction IAQ Management report detailing how fitout construction activities, and where applicable demolition and hauling activities, were executed for the project to demonstrate implementation of the Construction IAQ Management Plan.

7.2. Specific Requirements

Events shall be scheduled to protect indoor air quality by:

- Permitting adequate airing-out of new materials
- Sequencing the installation of finish materials
- Proper curing of concrete and wet finishes before covering

The CIAQMP should specify the location, type, amount, sequence and timing of the various control measures, including emergency procedures, and the labour, materials and time required to implement them.

The Construction IAQ Management report should address all aspects detailed in the CIAQMP with supporting documents; such as purchase orders, delivery notes, monitoring and/or measurement records and results, and photographic records

The specific requirements to demonstrate credit compliance are detailed in the relevant section of the BEAM Plus Interiors – Commercial, Retail and institutional Version 1.0 (2013.08) Reference Guide and Submission Template.

7.3. Submittal Documentation

The contractor should submit a CIAQMP and report with the documentations listed below to achieve the credit:

- List Responsible Person
- Records with logbook / records during construction programme
- Drawings with floor layout plans, sections, elevations, with measures highlighted
- Drawings, engineering with floor plans, sections, details, with measures highlighted
- Record photographs with site progress 'as built' works

8. Construction Noise (BEAM Plus MAN 3)

8.1. Tasks to be implemented

The Contractor shall submit a report to prove that noise from the work activities including demolition, construction, transportation, and fit-out activities, were minimised and/or rescheduled to avoid nuisance to host building users and neighbouring occupants

8.2. Specific Requirements

The specific requirements to demonstrate credit compliance are detailed in the relevant section of the BEAM Plus Interiors – Commercial, Retail and institutional Version 1.0 (2013.08) Reference Guide and Submission Template.

8.3. Submittal Documentation

The Contractor shall submit the documentation stated below to demonstrate criteria compliance:

- List Responsible Person
- Documentation, with planning, method statements, identified sources of noise nuisance, mitigation measures, and references
- Records with logbook, daily records, etc.
- Letter, Building Management Office declaration to confirm "No written compliant received"
- Record photographs, with progress and 'as built' mitigation measures taken.

9. Use Of Non-CFC Based Refrigerants (BEAM Plus MA P1)

9.1. Tasks to be implemented

The contractor shall not install or use CFC-based refrigerants in HVAC&R systems

9.2. Specific Requirements

The specific requirements to demonstrate pre-requisite compliance are detailed in the relevant section of the BEAM Plus Interiors – Commercial, Retail and institutional Version 1.0 (2013.08) Reference Guide and Submission Template.

9.3. Submittal Documentation

The Contractor shall submit the following documentations to demonstrate compliance

- A summary table, HVAC&R equipment, refrigerant type, quantity, model no.
- HVAC&R equipment schedule
- Manufacturer's catalogue, technical data sheets for equipment refrigerant highlighted
- Record photographs with equipment, refrigerant, nameplate information highlighted

10. Minimum Waste Recycling Facilities (BEAM Plus MA P2 & MA 1)

10.1. Tasks to be implemented

The Contractor shall provide at least one storage facility for the collection of each of the following type of waste; paper, plastic, metal materials, glass, and small electrical

appliance. The facility shall be placed in prominent location, but not necessary within the project space. The storage facility size is to be reviewed by BEAM Plus Consultant.

10.2. Specific Requirement

The specific requirements to demonstrate compliance are detailed in the relevant section of the BEAM Plus Interiors – Commercial, Retail and institutional Version 1.0 (2013.08) Reference Guide and Submission Template.

10.3. Submittal Documentation

The contractor shall fulfil this prerequisite credit by providing the following documents to demonstrate the compliance:

- List Responsible Person
- Drawing, architectural floor layout plan, sections, elevations, etc.
- Record Photographs with 'As-built' facilities
- List Target materials

11. Timber Used for Temporary Works (BEAM Plus MA P3)

11.1. Tasks to be implemented

The Contractor shall use timber originated from sustainable forestry or reused existing material only for <u>ALL</u> temporary works.

- Prohibit use of any virgin forest timber for Temporary Works
- List all timber usages and their related construction activities
- Record origins and types of the timber used
- Obtain certificates from acceptable forestry certification systems for all timber to be used in the Temporary Works (no use of virgin forest product)
- Provide purchase orders and delivery notes of timber used
- Provide evidence such as Site photos and records to demonstrate that no new timber or timber products were used

11.2. Specific Requirements

Temporary work means all temporary work, including but not limited to, enabling works, temporary protection works, temporary protection erected between different phases of the works or other occupants, temporary protection erected for walls, doors, finishes, cabinets, partitions, equipment, lifts and the like, temporary protection applied for floors, flooring, and carpets, temporary hoardings, and including all temporary doors, supports, bracing, cross bracing, fixings, trimming, hangers, and the like, whether located inside or outside the project space.

The specific requirements to demonstrate pre-requisite compliance are detailed in the relevant section of the BEAM Plus Interiors – Commercial, Retail and institutional Version 1.0 (2013.08) Reference Guide and Submission Template.

11.3. Submittal Documentation

The contractor shall fulfil this prerequisite credit by providing the following documents to demonstrate the compliance:

- Summary table, timber type, source, manufacturer, origin, certification (<u>Acceptable forestry certification systems included</u>: Forest Stewardship Council (FSC);

<u>Programme for the Endorsement of Forest Certification (PEFC); Canadian Standards Association (CSA); Cerflor (Brazil) and Malaysian Timber Certification Council (MTCC)</u>, quantities, usage

- Drawings, architectural floor plan(s), sections, elevations
- Certificate, source for sustainable timber, by prescribed organisation(s)
- Certification / undertaking source of re-used timber
- Procurement, sustainable timber purchase orders, delivery notes, records
- Procurement, regular timber purchase orders, delivery notes, records
- Procurement, composite timber purchase orders, delivery notes, records
- Record Photographs for materials installation, and demolition of all temporary works

12. Interior Components Reuse (BEAM Plus MA 2)

12.1. Tasks to be implemented

The Contractor shall ensure at least 30% and target 50% of prior condition walls, doors and floorings are reused.

The Contractor shall schedule and quantify the existing and reused elements, based on the total surface area.

12.2. Specific Requirements

The following items shall be included for compliance with this credit:

- Walls
- Glazing
- Ceilings
- Doors
- Flooring
- Existing wall coverings

The building envelope, structural elements, building envelope fenestration, shared/party walls, partitions, furniture, mechanical and electrical installations and any other elements which are not listed above are excluded from the calculations.

The specific requirements to demonstrate credit compliance are detailed in the relevant section of the BEAM Plus Interiors – Commercial, Retail and institutional Version 1.0 (2013.08) Reference Guide and Submission Template.

12.3. Submittal Documentation

The Contractor shall submit the following documents to demonstrate compliance:

- Summary table (shown below) with each construction element, description, total area, reused area, reused percentage calculation, descriptions of the methodologies and steps adopted to retain the reused items
- Drawings, floor and ceiling plans, elevations, sections, details, quantifying the total and reused areas
- Record Photographs with pre-construction and post-construction to demonstrate the elements that were retained
- Narrative with areas, methodologies adopted to maintain existing elements using sketches, etc.

	Item.	Reused Elements (sqm)	Prior Condition (sqm)	Comment.	.1
.1	a) walls.,	.1	a	a	.1
.1	b) glazing.	.1	a	a	.1
.1	c) Ceilings.	.1	a	a	.1
.1	d) Internal doors.	.1	a	a	.1
.1	e) Flooring.	a	a	a	.1
.1	f) Structural wall's coverings.	.a	a	a	.1
.1	g)	.1	a	a	.1
л	Total (sqm).	a.	a	a	.,
.1		Elements Reused (%).	.a	a	.1

13. Furniture And Partitions (BEAM Plus MA 3)

13.1. Tasks to be implemented

The Contractor shall ensure at least <u>30%</u> of the total furniture and partitions are from salvaged furniture and partitions or reused from existing condition.

The Contractor shall determine the total reused percentage; divide the total mass of the reused / salvaged furniture and/or partitions by the total mass (in kg) of the furniture and partitions used in the project site. Desk and chairs are also included in the assessment.

13.2. Specific Requirements

The following items shall be included for compliance with this credit:

- Fixed Furniture
- Cabinets
- Chairs
- Partitions
- Desks

The specific requirements to demonstrate credit compliance are detailed in the relevant section of the BEAM Plus Interiors – Commercial, Retail and institutional Version 1.0 (2013.08) Reference Guide and Submission Template.

13.3. Submittal Documentation

The Contractor shall demonstrate compliance by providing the below documentations as evidence for compliance:

For fixed furniture, cabinets and partitions

- Summary table (Shown below)
- Drawings, architectural with floor plan layouts, sections, quantity reused indicated
- Procurement with purchase orders, deliver notes for salvaged items
- Record Photographs, post-construction furniture / partition retained

For chairs and desks only

- Summary table with desks / chairs, location, source, mass, quantity reused, total
- Drawings architectural with floor plan layouts

TECHNICAL SPECIFICATION

- Procurement with purchase orders, deliver notes, chain of custody for salvaged items
- Record Photographs for post-construction furniture / partition retained

₽	₽			•	Ē
₽	ltem₽	Total Reused Furniture and Partitions (kg)↔	Total Furniture and Partitions used in Project Space (kg)₽	Comment⊷	Ē
₽	a) Fixed furniture₽	47	47	۰	Ë
₽	b) Cabinet₽	€3	4	47	Ė
₽	c) Chairs₽	₽	₽	47	Ë
₽	d) Partitions ₽	₽	4	47	Ë
47	e) Desks∂	₽	₽	47	Ė
₽	Total∻	₽	4	47	Ė
₽	Reused I	Furniture and Partitions (%)	P	47	Ë

14. Modular Design Materials (BEAM Plus MA 4)

14.1. Tasks to be implemented

The Contractor shall ensure the procurement and installation of designed modular elements which contribute at least 50% of the newly installed elements in the project.

The Contractor shall quantify the modular elements based on total surface area. Only the new installed elements are included in this assessment. Each item (partitions, walls, ceilings, doors and raised floor) shall be of modular elements and shall be assessed individually.

14.2. Specific Requirements

The following items shall be included for compliance with this credit:

- Partitions
- Walls
- Ceilings
- Doors
- Raised floor

The specific requirements to demonstrate credit compliance are detailed in the relevant section of the BEAM Plus Interiors – Commercial, Retail and institutional Version 1.0 (2013.08) Reference Guide and Submission Template.

14.3. Submittal Documentation

The Contractor shall demonstrate compliance by providing the below documentations as evidence for compliance:

- Summary table (shown below) with product types, materials, manufacturer, quantities, percentage of modular component, reference sources
- Drawings, architectural with floor plans, elevations, sections, detail sheets, fixing details, details highlighted

- Product catalogues / technical data sheets for equipment, materials, systems, supports, fixing highlighted
- Record photographs with installation progress and 'As-built' installation

ltem₽	Modular Construction (sqm)₽	Total newly installed items (sqm)√	Modular (%)√
a) Partitions₽	φ	φ	₽
b) Walls₽	φ	φ	ę.
c) Ceilings₽	φ	Ç.	φ.
d) Doors₽	ę.	ته	ت
e) Raised floor₽	φ	φ	φ
f) 🔑	P	٥	₽

15. Designed For Disassembly (BEAM Plus MA 5)

15.1. Tasks to be implemented

The Contractor shall demonstrate the installed construction elements and fixings that are easy to dismantle, and disassemble at the end of serviceable life, and contribute at least 50% of the newly installed elements.

The Contractor shall determine the total Disassemble Design percentage, divide the total area (m²) of Disassembly Designed Elements by the total area (m²) of the newly installed items in the project site.

15.2. Specific Requirements

The following items shall be included for compliance with this credit:

- Walls
- Ceilings
- Doors
- Raised floor
- Supports and fixings

The specific requirements to demonstrate credit compliance are detailed in the relevant section of the BEAM Plus Interiors – Commercial, Retail and institutional Version 1.0 (2013.08) Reference Guide and Submission Template.

15.3. Submittal Documentation

The Contractor shall demonstrate compliance by providing the below documentations as evidence for compliance:

- Summary Table shown below
- Drawings, architectural with floor, elevations, sections, detail sheets, supports, fixing details highlight
- Narrative, method statement for dismantling components
- Product catalogues, technical data sheets with components, materials and fixing highlighted
- Record photographs with "As-built" installation, site progress records, details, fixings

Item↔	Total Disassembly Designed Elements (sqm)↔	Total Newly Installed items (sqm)₽	Disassemble Design⊷ ← (%)⊷
a) Partitions₽	₽	₽	φ φ
b) Walls₄¹	φ	φ	φ φ
c) Ceilings₽	φ	φ	φ φ
d) Doors₽	φ	φ	φ φ
e) Raised floor ₽	ę.	₽.	φ φ

16. Sustainable Flooring Products (BEAM Plus MA 6)

16.1. Tasks to be implemented

Rapidly Renewable Material, Recycled Material, Sustainable Timber or Combination

The Contractor shall ensure at least <u>50%</u> of all newly installed flooring is made from rapidly renewable materials, recycled materials or sustainable timber or a combination of any of the three above mentioned materials.

Regionally Manufactured Materials

The Contractor shall ensure at least <u>50%</u> of the newly installed flooring materials are manufactured within 800km radius from the project site.

Environmentally Manufactured Materials

The Contractor shall ensure at least <u>50%</u> of the newly installed flooring materials are manufactured by organisations which have implemented Environmental Management System (EMS).

16.2. Specific Requirements

The following items shall be included for compliance with this credit:

- Flooring
- Supports
- Framing
- Trimming
- Bracing
- Skirting
- Levelling

The calculations to demonstrate credit compliance shall be quantified by the surface areas of the materials.

The specific requirements to demonstrate pre-requisite compliance are detailed in the relevant section of the BEAM Plus Interiors – Commercial, Retail and institutional Version 1.0 (2013.08) Reference Guide and Submission Template.

16.3. Submittal Documentation

The Contractor shall demonstrate compliance by providing the documentation below:

Rapidly Renewable Material, Recycled Material, Sustainable Timber or Combination

- Summary table, with product details, manufacturer, quantities, percentage of compliant materials, supports, under floor, fixings, reference sources
- Drawings, floor layout plans, elevations, door schedules, sections, details highlighted
- Product catalogues, technical sheets, certificates for all materials, material content highlighted
- Record Photographs, installation work, completed work, "As-built" installation

Regionally Manufactured Materials

- Summary table showing the types, manufacturer, manufacture locations, quantities, percentage of regionally manufactured products, supports, under floor, fixings, reference sources
- Product Catalogues, technical sheets, door schedules, substantiating materials, material content highlighted
- Map indicating each location is < 800km radius
- Procurement with purchase orders, delivery note, factor location, quantity

Environmentally Manufactured Materials (EMS)

- Summary table, types, manufacturer, quantities
- Certificate(s) for EMS or EMS Manual for all manufacturer/factories

17. Sustainable Ceiling Products (BEAM Plus MA 7)

17.1. Tasks to be implemented

Rapidly Renewable Material, Recycled Material, Sustainable Timber or Combination

The Contractor shall provide ensure at least <u>50%</u> of all newly installed ceiling is made from rapidly renewable materials, recycled materials or sustainable timber or a combination of any of the three above mentioned materials.

Regionally Manufactured Materials

The Contractor shall ensure at least <u>50%</u> of the newly installed ceiling materials are manufactured within 800km radius from the project site.

Environmentally Manufactured Materials

The Contractor shall ensure at least <u>50%</u> of the newly installed ceiling materials are manufactured by organisations which have implemented Environmental Management System (EMS).

17.2. Specific Requirements

The following items shall be included for compliance with this credit:

- Ceiling Tiles

BEAM PLUS
TECHNICAL SPECIFICATION

- Hangers
- Trimming

FOR CIC INNOVATION CENTRE (IC)

- Levelling
- Framing
- Bracing
- Ceiling Support
- Secondary Grid
- Bulkhead
- Shadow Gap Infill
- Access Panels

The calculations to demonstrate compliance shall be quantified by the surface areas of the materials.

The specific requirements to demonstrate credit compliance are detailed in the relevant section of the BEAM Plus Interiors – Commercial, Retail and institutional Version 1.0 (2013.08) Reference Guide and Submission Template.

17.3. Submittal Documentation

The Contractor shall demonstrate compliance by providing the below documentations:

Rapidly Renewable Material, Recycled Material, Sustainable Timber or Combination

- Summary table, with product details, manufacturer, quantities, percentage of compliant materials, supports, under floor, fixings, reference sources
- Drawings, ceiling plans, elevations, door schedules, sections, details highlighted
- Product catalogues, technical sheets, certificates for all materials, material content highlighted
- Record Photographs, installation work, completed work, "As-built" installation

Regionally Manufactured Materials

- Summary table showing the types, manufacturer, manufacture locations, quantities, percentage of regionally manufactured products and reference sources
- Product Catalogues, technical sheets, substantiating materials, material content highlighted
- Map indicating each location is < 800km radius
- Procurement with purchase orders, delivery notes, factor location, quantity etc.

Environmentally Manufactured Materials (EMS)

- Summary table shown below
- Certificate for EMS or EMS Manual for all manufacturer/factories

18. Sustainable Wall and Door Products (BEAM Plus MA 8)

18.1. Tasks to be implemented

Rapidly Renewable Material, Recycled Material, Sustainable Timber or Combination

The Contractor shall provide ensure at least <u>50%</u> and target for 100% of all newly installed wall and door materials for wall and door materials made from rapidly renewable

materials, recycled materials or sustainable timber or a combination of any of the three above mentioned materials.

Regionally Manufactured Materials

The Contractor shall ensure at least <u>50%</u> of the newly installed wall and door materials are manufactured within 800km radius from the project site.

Environmentally Manufactured Materials

The Contractor shall ensure at least <u>50%</u> of the newly installed wall and door materials are manufactured by organisations which have implemented Environmental Management System (EMS).

18.2. Specific Requirements

The following items shall be included for compliance with this credit:

- Wall and its covering
- External / Structural Wall covering only
- Doors
- Trimming
- Levelling
- Bracing
- Framing

The calculations to demonstrate credit compliance shall be quantified by the surface areas of the materials.

The specific requirements to demonstrate pre-requisite compliance are detailed in the relevant section of the BEAM Plus Interiors – Commercial, Retail and institutional Version 1.0 (2013.08) Reference Guide and Submission Template.\

18.3. Submittal Documentation

The Contractor shall demonstrate compliance by providing the below documentations:

Rapidly Renewable Material, Recycled Material, Sustainable Timber or Combination

- Summary table to show the product items, manufacturers, quantities, percentage of rapidly renewable / recycled / sustainable timber content and reference sources
- Drawings, floor layout plans, elevations, door schedules, sections, details highlighted
- Product catalogues, technical sheets, certificates for all materials, material content highlighted
- Record Photographs, installation work, completed work, "As-built" installation

Regionally Manufactured Materials

- Summary table showing the product types, manufacture locations, quantities, percentage of locally manufactured products and reference sources
- Product Catalogues, technical sheets, door schedules, substantiating materials, material content highlighted
- Map indicating each location is < 800km radius
- Procurement with purchase orders, delivery notes, factor location, quantity

Environmentally Manufactured Materials (EMS)

- Summary table showing the product types, manufacturers, quantities
- Certificate for EMS or EMS Manual for all manufacturer/factories

	ltem₽	Prescribed ↔ Material (sqm)↔	Total Newly Installed ↓ Material (sqm)↓	Comments∂
a)	Walls₽	P	P	P
b)	doorse	ę.	P	ę.
c)	٥	ę.	٥	42
	Total₽	P	P	ę.
		Qualified Content (%)	P	p

	ltem∂	Total Regionally Manufactured Materials (sqm)ಳ	Total Newly Installed ↔ Materials (sqm)↔	Comments⊬	ç
d)	Walls₽	o	φ	٥	47
e)	doors₽	4	p	٥	4
f)	¢.	4	p	٥	4
	Total	ę.	P	P	4
	Total Regionally Manufactured Materials (%)		P	P	4

	ltem∉	Total Environmentally Manufactured Materials (sqm)↔	Total Newly Installed⊷ Materials (sqm)⊷	Comments∂	÷
g)	Walls₽	<i>₽</i>	47	ę.	-
h)	doors₽	42	42	42	4
i)	43	ę.	p	42	47
	Total∂	P	p	4	47
	Total Environn	nentally Manufactured Materials (%)ಳ	φ		*

19. Zero PVC (BEAM Plus MA 9)

19.1. Tasks to be implemented

The Contractor shall use alternative products and materials with zero PVC content for the project.

19.2. Specific Requirements

The following items shall be included for compliance with this credit:

- Edge Protection Strip
- Cable Conduit
- Electric Cables
- Furniture
- Chairs
- Phone Cables
- Pipework
- Data Cables

FIT-OUT AND BUILDING SERVICES INSTALLATION WORKS FOR CIC INNOVATION CENTRE (IC)

The specific requirements to demonstrate credit compliance are detailed in the relevant section of the BEAM Plus Interiors – Commercial, Retail and institutional Version 1.0 (2013.08) Reference Guide and Submission Template.

19.3. Submittal Documentation

The Contractor shall demonstrate compliance by providing the below documentations:

- Summary table with product types, quantities, determination of PVC content, reference sources
- Drawings, floor ceiling layout plans, elevations, etc.
- Product catalogues or technical sheets to confirm that the installed products are non-PVC type material
- Record Photographs

20. Ozone Depletion Substances (BEAM Plus MA 10)

20.1. Tasks to be implemented

The Contractor shall use only products without ozone depleting substances (CFC & HCFC) in the manufacturing process, composition of thermal insulation, fire retardant materials used for all partitions, walls, chilled water pipes, refrigerant pipes and ductwork.

20.2. Specific Requirements

The specific requirements to demonstrate credit compliance are detailed in the relevant section of the BEAM Plus Interiors – Commercial, Retail and institutional Version 1.0 (2013.08) Reference Guide and Submission Template.

20.3. Submittal Documentation

The Contractor shall demonstrate compliance by providing the below documentations:

- Summary table with materials, products, manufacturer, reference sources (e.g. Catalogue, or manufacturer compliance letter)
- Drawing, architectural, floor plans, sections, details
- Drawings, engineering with BSI schematics, plans, sections, details
- Product catalogue or compliance letter signed by the manufacturer to show the avoidance of using ozone depleting substances in all newly installed materials and products
- Record Photographs

Prescribed <i>↔</i> Element <i>₀</i>	Alternative Material Used⊮	Material Data ↵ Sheet↵	Drawing. Number.	Photo <i>₀</i> Number <i>₀</i>
a.) Partitions₽	φ	4	₽	p q
b.) Walls₽	ę.	43	43	
c.) Chilled water pipes	P	47	43	-p
d.) Refrigerant pipes	P	4	₽	-p
e.) Ductwork₽	φ.	ē.	₽	-p
f.) ₽	φ	ę.	₽	P .
g.) 🔑	ę.	47	₽	47
h.)	φ.	¢.	₽	ę ę

21. Demolition And Construction Waste Reduction (BEAM Plus MA 11)

21.1. Tasks to be implemented

The Contractor shall ensure that at least <u>60%</u> of demolition and construction waste is recycled.

21.2. Specific Requirements for Monitoring and Auditing

The following items shall be included for compliance with this credit:

- Demolished materials
- Plastics
- Paper / cardboard
- Packaging materials
- Metals
- Timber
- General Refuse

The specific requirements to demonstrate credit compliance are detailed in the relevant section of the BEAM Plus Interiors – Commercial, Retail and institutional Version 1.0 (2013.08) Reference Guide and Submission Template.

21.3. Submittal Documentation

The Contractor shall submit report listing out the materials that satisfy compliance requirements. The report should quantify the amount of recycled demolition waste as a percentage of total demolition waste. Several documentations have to be submitted including:

- List responsible person
- Summary table with waste flow, type, disposal method, quantities, reference sources
- Trip tickets and waste recycled receipt
- Logbook/records waste monitoring (State the waste stream, quantity, type, sorting, storage, recycling and disposal method)
- Photograph records, waste sorting and storage by contractors, and collection by recyclers

Prescribed <i>⊌</i>	Recycled	Overall Quantity⊮ C&D Waste (kg)⊮		
Element₽	C&D Waste (kg)₽			
a.) Demolished materials	-	4		
b.) Plastics₽	-	4		
c.) Paper and cardboard packaging	.	4		
d.) Metals₽	.	43		
e.) Timber₽	.	P		
f.) General refuse@	₽	43		
Sub Total∞	₽	4		
Percentage C&D Waste Recycled (%)				

ψ

TENDER DOCUMENT BEAM PLUS

TECHNICAL SPECIFICATION

22. Energy Efficient Appliances (BEAM Plus EU 2)

22.1. Tasks to be implemented

FOR CIC INNOVATION CENTRE (IC)

The Contractor shall purchase and install labelled energy efficient equipment and appliances. The acceptable appliances are governed by the <u>EMSD's Energy Efficiency</u> <u>Labelling Scheme with GRADE 1 labels</u> for both mandatory and voluntary schemes and the <u>US EPA's ENERG STAR</u> programme.

The Contractor shall ensure that at <u>100%</u> of the total quantity, for each type of electrical appliance is certified with energy efficient.

Equipment and appliances shall be <u>new</u>, installed by the Applicant at the time of occupancy, within the project space.

22.2. Specific Requirements for Monitoring and Auditing

The general requirement for monitoring, auditing and control can be found in section 2.4 of this Specification.

22.3. Submittal Documentation

The Contractor shall demonstrate compliance by providing the below documentations as evidence for compliance:

- Summary table below
- Catalogue, manufacturer specification, technical data sheet for all appliances
- Drawings, architectural layout plan(s) with locations highlighted
- Record Photographs with all appliances in-situ



23. Commissioning (BEAM Plus EU 3)

23.1. Tasks to be implemented

The Contractor shall assign a qualified person as commission authority to be primarily responsible for testing and commissioning of the energy consuming systems.

The Contractor shall provide full attendance, input and assistance in testing and commissioning of all building energy systems and provide relevant input at all times to

the qualified person, including but not limited to inputs to documentation such as commissioning specifications, testing documentation, commissioning plans, commissioning report.

23.2. Commissioning Plan and Scopes

The commissioning shall cover the following energy and IEQ related systems:

- i. Heating, ventilating, air conditioning and refrigeration (HVAC&R) systems and associated controls;
- ii. Lighting systems and associated controls;
- iii. Energy monitoring systems
- iv. Plumbing and Drainage systems:
- v. Only systems installed by the Applicant serving the project space shall be assessed.

To execute commissioning in a comprehensive and orderly manner a commissioning plan, covering every system, equipment, and component shall be prepared. The plan shall include:

- i. start-up and inspection checklists and procedures;
- ii. functional performance testing procedures and checklists;
- iii. testing, adjusting, and balancing;
- iv. development of an operations and maintenance manual and energy management manual:
- v. completion of the commissioning report;

For each system commissioned the plan shall provide:

- i. an overview of the tasks to be executed during commissioning;
- ii. a list of all features to be commissioned;
- iii. a list of reference documents related to commissioning, including specification references, drawing list, and submittal drawings;
- iv. a list of primary participants in the commissioning process and their responsibilities;
- v. a plan for management, communication and documentation;
- vi. description of checklists and tests to be performed, with reference to specification;
- vii. pre-start and start-up checklists;
- viii. list of the functional performance tests to be performed;
- ix. description of the training to be provided to the operations and maintenance personnel

23.3. Commissioning Report

The records of functional testing of systems and equipment shall be performed as documented in the commissioning plan and endorsed by qualified person. The commissioning report shall cover as a minimum the items given in Appendix 9.2.2 of BEAM Plus Interior V1.0 Manual, after all commissioning tasks, except seasonally deferred testing, have been completed. Commissioning reports shall be verified and signed-off by qualified person.

The commissioning records and reports shall cover the following systems, where installed:

- i. Heating, ventilating, air conditioning and refrigeration (HVAC&R) systems and associated controls;
- ii. Lighting systems and associated controls;
- iii. Energy monitoring systems;
- iv. Plumbing and Drainage systems:
- v. Only systems installed by the Applicant serving the project space shall be assessed.

The commissioning report shall document the commissioning process, and results, it shall comprise:

- i. executive summary;
- ii. list of participants and their respective roles;
- iii. brief project space description;
- iv. an overview of the scope of testing and commissioning;
- v. general description of testing and verification methods;
- vi. list of each feature component, and system commissioned;
- vii. for each piece of commissioned equipment, the adequacy of the equipment, documentation and training.

The commissioning report shall address the following areas:

- i. adequacy of equipment with respect to construction documents and design intent;
- ii. equipment installation;
- iii. functional performance and efficiency;
- iv. equipment documentation;
- v. operations and maintenance review and recommendations;
- vi. operator training;

The functional performance and efficiency section for each piece of equipment shall identify the verification method used observations and conclusions from the

commissioning process. The report shall include a list of outstanding commissioning issues, and any deferred or seasonal testing that should be scheduled.

All outstanding deficiencies identified during or as a result of commissioning activities shall have been corrected or must be separately listed and highlighted in the commissioning report.

Each non-compliance issue must be referenced to where the deficiency is documented.

Verification and documentation of installation of systems, equipment and components shall ensure:

- i. that they are installed according to construction documents and manufacturers instructions;
- ii. any differences between the final installation and the original construction documents shall be documented;
- that other building systems or components are not compromising the efficiency iii. of the systems or features being commissioned;
- the start-up and inspection checklists were completed and performed as required; iv.
- that functional performance tests were completed; v.
- that HVAC&R piping testing and duct testing was completed and documentation vi. included in operation and maintenance manual;
- functional testing of all control systems was completed; vii.
- viii. record of any deficiencies and corrective actions;
- ix. final testing outcomes are included in the commissioning report and in the operation and maintenance manual;
- documentation of any seasonally deferred testing and corrections of any х. deficiencies;
- the operations and maintenance manual and energy management manual are хi. complete for all components, equipment, subsystems, and systems that have been commissioned;
- adequacy of training provided for the Owner's management, operation and xii. maintenance personnel

If components, equipment, subsystems, or controls, or sequences of operations as-built are differing from the original construction documents, the report shall detail these differences.

When any deferred or seasonally deferred commissioning is completed, the commissioning authority shall issue an addendum, arranged in the same manner as in the initial commissioning report.

23.4. Specific Requirements for Monitoring and Auditing

The general requirement of monitoring, auditing and control can be found in the Section 2.4 of this specification.

23.5. Submittal Documentation

The Contractor shall provide specifications and manufacture's manuals of all building energy systems, submitted for the BEAM Plus Consultant approval within 4 week prior to installation.

- Commissioning plans for al Building Services Installation, functional templates, programme
- Commissioning specification all systems
- Records, commissioning reports, forms, measurement schedules, methods for all systems
- Records with scheduled / deferred commissioning, all systems
- Drawings with As-built for all systems with all commissioning data highlighted
- Record Photographs, sample commissioning procedures, records, measuring

24. Operations & Maintenance (BEAM Plus EU 4)

24.1. Tasks to be implemented

The Contractor shall develop and implement fully documented operations and maintenance manuals to the specified minimum requirements listed below:

- a. Manual must include for each piece of equipment and each system:
 - The name and contact information of the manufacturer or vendor and installing Contractor
 - Submittal data
 - Operations and maintenance instructions with the models and features for the subject site clearly marked.
- b. Manual shall include only data for equipment that is actually installed and include the following:
 - Instructions for installation, maintenance, replacement, start-up
 - Special maintenance requirements and sources for replacement parts/equipment
 - Parts list and details of and special tooling requirements
 - Performance data
 - Warranty information
- c. The manual shall include an as-built documentation package for controls covering the following:
 - Control drawings and schematics
 - Normal operation
 - Shutdown
 - Unoccupied operation
 - Seasonal changeover
 - Controls set-up and programming
 - Troubleshooting
 - Alarms

24.2. O&M Manual

Each system to be commissioned shall be included for the following:

- i. the design intent;
- ii. the basis of design;
- iii. full sequences of operation for all equipment and systems, all of which must meet the legal requirements and industry wide standards;

The description of the design intent should include as a minimum:

- iv. space temperature and humidity criteria (refer also to the section on IEQ);
- v. levels operator and/or occupant control over HVAC&R systems;
- vi. ventilation requirements and related indoor air quality criteria (refer also to the section on IAQ);
- vii. performance criteria related to energy efficiency;
- viii. environmental responsiveness of the facility;
- ix. commissioning criteria;

The basis of design shall include at a minimum:

- i. details of occupancy;
- ii. space activity and any process requirements;
- iii. applicable regulations, codes, and standards;
- iv. design assumptions;
- v. performance standards and benchmarks;
- vi. control system appropriate for the skill of the operations and maintenance staff.

The operations and maintenance manual must include for each piece of equipment and each system:

- i. the name and contact information of the manufacturer or vendor and installing contractor;
- ii. submittal data;
- iii. operations and maintenance instructions with the models and features for the subject site clearly marked;

The manual shall include only data for equipment that is actually installed, and include the following:

- i. instructions for installation, maintenance, replacement, startup;
- ii. special maintenance requirements and sources for replacement parts/equipment;
- iii. parts list and details of and special tooling requirements; performance data;

iv. iv. warranty information;

The manual shall include an as-built documentation package for controls covering the following:

- i. control drawings and schematics;
- ii. normal operation;
- iii. shutdown;
- iv. unoccupied operation;
- v. seasonal changeover;
- vi. manual operation;
- vii. controls set-up and programming;
- viii. troubleshooting;
- ix. alarms;
- x. final sequences of operation.

24.3. Energy Management Manual

The details shall include:

- xi. guidelines for establishing and tracking benchmarks for space energy use and primary plant equipment efficiencies;
- xii. descriptions of the final design intent and basis of design, including brief descriptions of each system;
- xiii. final sequences of operations for all equipment;
- xiv. procedures for seasonal start-up and shutdown, manual and restart operation;
- xv. as-built control drawings;
- xvi. for all energy-saving features and strategies, rationale description, operating instructions, and caveats about their function and maintenance relative to energy use:
- xvii. specifications for re-calibration frequency of sensors and actuators by type and use;
- xviii. recommendations for continuous commissioning or recommended frequency for re-commissioning by equipment type, with reference to tests conducted during initial commissioning;
- xix. recommendations regarding seasonal operational issues affecting energy use;
- xx. list of all user-adjustable set points and reset schedules, with a discussion of the purpose of each and the range of reasonable adjustments with energy implications;
- xxi. schedules of inspection frequency for reviewing the various set points and reset schedules to ensure they still are near optimum;

- xxii. list of time-of-day schedules and a frequency to review them for relevance and efficiency;
- xxiii. guidelines for ensuring that future renovations and equipment upgrades will not result in decreased energy efficiency and will maintain the design intent;

24.4. Specific Requirements for Monitoring and Auditing

The general requirements for monitoring, auditing and control can be found in section 2.4 of this specification.

24.5. Submittal Documentation

The Contractor shall provide operations and maintenance manual covering the minimum requirements specified in the above section.

The Contractor shall provide training programme such as power point presentation, manual, covering the minimum requirements specified in the above section.

The Contractor shall provide evidence of operatives training such as record of attendance, verifying that training of the building's operations and maintenance staff was undertaken for all commissioned systems and major equipment, using the operations and maintenance manual.

The Contractor shall demonstrate compliance by providing the below documentations as evidence for compliance:

- List Responsible Person
- Records with digital O&M manual, record photographs, screenshots, printout, populated lists, list set points
- Records with digital energy management manual or section indicated, table of contents
- Contract with Building Services Installation maintenance, scope of work
- Records with method statements for all systems, programme/frequency of inspection for all system

25. Metering and Monitoring (BEAM Plus EU 5)

25.1. Tasks to be implemented

The Contractor shall provide details of the measuring and monitoring equipment installed and commissioning records of consumption and equipment performance, to demonstrate that electricity use and performance can be monitored as stipulated.

25.2. Specific Requirements for Monitoring and Auditing

The general requirement for monitoring, auditing and control can be found in section 2.4 of this Specification.

25.3. Submittal Documentation

FOR CIC INNOVATION CENTRE (IC)

The Contractor shall provide catalogue of meters and monitoring equipment, purchase orders and layout plan indicating the locations of the plans for credit compliance.

26. Water Quality Survey (BEAM Plus WU 1)

26.1. Tasks to be implemented

The Contractor shall provide documentation demonstrating that the quality of potable water meets the referenced drinking water quality standards at all points of use. Potable water sampling should be systematic, such as described in ISO 5667. At least five (5) nos. of water samples shall be taken in the distribution system within the project space from the storage tank of the host building. Water samples are required to comply with the **thirteen (13) parameters** including pH, colour, turbidity, conductivity, iron total, E. coli, total coliform count, free residual chlorine, heterotrophic plate count, lead, cadmium, chromium and nickel as stipulated in the Quality Water Recognition Scheme for Buildings administered by the Water Supplies Department.

26.2. Specific Requirements for Monitoring and Auditing

The general requirement for monitoring, auditing and control can be found in section 2.4 of this Specification.

The specific requirements to demonstrate credit compliance are detailed in the relevant section of the BEAM Plus Interiors – Commercial, Retail and institutional Version 1.0 (2013.08) Reference Guide and Submission Template.

26.3. Submittal Documentation

The Contractor shall submit a summary table, drawings, with plumbing schematic, layout drawings; record photographs; Laboratory test report(s) including details of the analysis of samples taken from potable water outlets used to supply for human consumption.

27. Annual Water Use (BEAM Plus WU 2)

27.1. Tasks to be implemented

The Contractor shall demonstrate that the provision of equipment meeting the intent and the target percentage of reduction can be achieved. The target percentage use of water efficient devices leads to an aggregate annual saving of 40% compared to the baseline case.

27.2. Specific Requirements for Monitoring and Auditing

The specific requirements to demonstrate credit compliance are detailed in the relevant section of the BEAM Plus Interiors – Commercial, Retail and institutional Version 1.0 (2013.08) Reference Guide and Submission Template.

27.3. Submittal Documentation

TENDER DOCUMENT

The Contractor shall submit the following documentations to demonstrate compliance:

Water saving calculation, example and baseline data shown below

Device (Reference catalogue ^(A))	Duration of each operation (seconds)	Daily number of uses per occupant	Rated flow rate (litres/minute)		Estimated daily consumption per occupant (litres)	
			Baseline (c)	As-built	Baseline (c)	As-built
Tap Toilet (Model 123)	10	5	6	4	5	3.3
Tap Pantry (Model 456)	15	1	8	4.5	2	1.1
Estimated total daily consumption per occupant (litres)				7	4.4	
Number of occupants ^(B)				30		
Number of day				365		
Estimated total annual consumption (litres)				76,650	48,180	
% of water saving:				37.1%		

The baseline water flow rate data used in calculations shall use the following data:

description	size (mm)	flow rate	unit
shower head		9.5	l/min
kitchen sink pillar tap (pantry)	22	6	l/min
kitchen sink mixer tap (pantry)	22	6	l/min
pillar tap	15	6	l/min
mixer tap	15	9	l/min
bath pillar tap	22	15	l/min
bath mixer tap	22	15	l/min
bidet	15	5	l/min
Pre-rinse spray valves kitchen	15	7	l/min
WC		7	L/flush
WC hose spray	15	5	l/min
Urinal	15	4.5	L/flush
Washing machine (horz)	15	12.6	L/kg/cycle
Washing machine (vert)	15	22	L/kg/cycle

- Drawings, architectural, floor layout plan with WC, washroom, pantry, etc.
- Calculation, with annual water usage, compared with baseline data
- Drawings, engineering with plumbing schematic drawings
- Manufacturer specifications, technical data sheets with flow rate information
- Record photographs, "As-built" installation
- WSD WELS <u>Grade 1</u> labelled documentation, for all taps, or proof of equivalent or lower flow rate.

28. Effluent Discharge to Foul Sewers (BEAM Plus WU 3)

28.1. Tasks to be implemented

The Contractor shall demonstrate that the flushing systems installed within the project space are water efficient lowering sewerage volume.

28.2. Specific Requirements for Monitoring and Auditing

Water efficient flushing systems include but not limited to:

- sensor type urinal;
- waterless urinal;
- flushing system certified by WELS Grade 1;
- dual flush water closet;

The specific requirements to demonstrate credit compliance are detailed in the relevant section of the BEAM Plus Interiors – Commercial, Retail and institutional Version 1.0 (2013.08) Reference Guide and Submission Template.

28.3. Submittal Documentation

The Contractor shall submit the following documentation to demonstrate the compliance:

- Lease/ other document for occupants access to shared facility
- Drawings, architectural, with location plan in host building clearly indicated
- Manufacturer specifications. Technical data sheet and catalogue with water flow rate information
- Record Photographs for "As-built" facility in host building

29. Indoor Air Quality (BEAM Plus IEQ 1)

29.1. Tasks to be implemented

The Contractor shall carry out indoor air quality (IAQ) measurement to ensure the interior spaces will not suffer due to contamination from indoor sources of infiltration from outdoor sources. The measurements shall demonstrate that the identified pollutants below complied with the Excellent Class requirement prescribed in the IAQ Certification Scheme

- Total Volatile Organic Compounds (TVOCs)
- Formaldehyde (HCHO)
- Products of Combustion
 - Carbon Monoxide (CO)
 - Nitrogen Dioxide (NO₂)
- Respirable Suspended Particulate (RSP, PM₁₀)
- Ozone

Measurement shall take place during normally occupied period.

Reference of VOC can be found in "A Guide to the Air Pollution Control (Volatile Organic Compounds) Regulations" The Contractor shall use low VOC content materials to maintain a good and healthy office environment.

Adhesive and Sealant

The maximum limits of VOC contents is expressed as **grams of VOCs per litre** of adhesive when in a <u>ready to use</u> condition

		Maximum Limits of VOC Content@@					
	Regulated Adhesives*	Effective from 1 January 2010	Effective from 1 April 2012				
10.	Structural glazing adhesives	100	-				
11.	Subfloor adhesives	50	-				
12.	VCT and asphalt tile adhesives	50	-				
13.	Wood flooring adhesives	100	-				
(II) Specialty Applications							
14.	ABS welding adhesives	325	-				
15.	Adhesive primers for plastic	550	-				
16.	Adhesive primers for traffic marking tape	150	-				
17.	Contact Adhesives	250	80				
18.	Computer diskette manufacturing adhesives	350	-				
19.	CPVC welding adhesives	490	-				
20.	Graphic arts adhesives	150	-				
21.	Paper, fabric and film coating adhesives	265	-				
22.	Plastic cement welding adhesives	250	-				
23.	PVC welding adhesives	510	-				
24.	Sheet-applied rubber lining operation adhesives	850	-				
25.	Special purpose contact adhesives	250	-				
26.	Structural wood member adhesives	140	-				
27.	Top and trim adhesives	250	-				
28.	Tyre retread adhesives	100	-				
29.	Wood flat stock adhesives	250	-				
For	Adhesive Substrate Specific Applications** adhesives not listed in Category (I) and (I trates, the following limits shall apply:	I) above and applied to	the following				
30.	Adhesives for fibreglass	80	-				
31.	Adhesives for metal	30	-				
32.	Adhesives for plastic foams	50	-				
33.	Adhesives for porous material	50	-				
34.	Adhesives for wood	30	-				
	Other Adhesives adhesives not falling within Category (I)	to (III) above.					
35.	Other adhesives***	250	-				

		Maximum Limits o	f VOC Content@@				
	Regulated Adhesives*	Effective from 1 January 2010	Effective from 1 April 2012				
(I) A	(I) Architectural Applications						
1.	Carpet pad adhesives	50	-				
2.	Ceramic tile adhesives	65	-				
3.	Cove base adhesives	50	-				
4.	Dry wall and panel adhesives	50	-				
5.	Indoor carpet adhesives	50	-				
6.	Multi-purpose construction adhesives	70	-				
7.	Outdoor carpet adhesives	150	-				
8.	Rubber flooring adhesives	60	-				
9.	Single-ply roof membrane adhesives	250	-				

Paints, Coatings and Finishes

Any paints, coatings and finished are used in the project interiors, the VOC content limits should less than **50g per litre**

Flooring materials

The total emission and emission rate of VOC shall be exceed $2g/m^2$ and $500\mu g/m^2/hr$ The emission of formaldehyde should not exceed $0.13~mg/m^3$ air for wood-based flooring

Heavy metals including Cadmium, Mercury, Hexavalent chromium, Lead, Arsenic and Antimony should not be contained

The product should not contain chlorinated/ brominated paraffin's organic tin compounds, phthalates or PBDEs content

<u>Carpets</u>

The emission of TVOCs should not exceed 0.5 mg/m² per hour. It is suggested to use water-based adhesive or adhesive free carpets.

Furniture

For metal furniture

No formaldehyde and halogen solvent, and heavy metallic substances shall be contained. For the plastic parts, substances including lead, chromium, cadmium, mercury, phthalates and halogenated organic substances

For non-metal furniture:

All wooden board used shall be of <u>Class E1</u> in respect of

formaldehyde emission requirements as follows:

MDF Board: $\leq 8 \text{mg}/100 \text{g}$ as per EN120 test requirement;

Plywood: release ≤0.124mg/m 3 air as per EN717-1 test requirement

A test report shall be submitted to demonstrate the compliance for all items above

29.2. Specific Requirements for Monitoring and Auditing

The general requirement for monitoring, auditing and control can be found in section 2.4 of this Specification.

29.3. Submittal Documentation

The Contractor shall develop and submit a measurement report showing:

- The method statement of IAQ measurement;
- Measurement report issued by an HKAS accredited IAQ Certificate Issuing Body with measurement methodology, number of sampling points required under IAQ Certification Scheme, measuring date, time and conditions of the interiors space, the measurement results and the calibration certificates of the measuring equipment.
- Alternatively, IAQ Certificate issued by Environmental Protection Department for demonstrating compliance

- FIT-OUT AND BUILDING SERVICES INSTALLATION WORKS FOR CIC INNOVATION CENTRE (IC)
 - Specifications for the materials/compounds as they appear in construction documents
 - A table listing the materials used, identifying the emissions rates for materials, the permitted emissions limit for each of the materials as specified in referenced documents, and details of the source data
 - Confirmation of compliance with the relevant standard/emission criteria (e.g. testing reports)

30. Indoor Planting (BEAM Plus IEQ 2)

30.1. Tasks to be implemented

The Contractor shall select plants suitable for indoor environment. The criteria are shown as below:

- <u>Horticultural Maintenance Plan</u> shall be in place for effective communication and ensure the health of the plants is maintained
- No herbicides and pesticides are applied to the plants
- <u>No electricity, from fossil fuelled generation</u>, is used to maintain and for the growth of the plants

30.2. Specific Requirements for Monitoring and Auditing

The general requirement for monitoring, auditing and control can be found in section 2.4 of this Specification.

30.3. Submittal Documentation

The Contractor shall provide documentation stated below to demonstrate compliance:

- Summary table includes total number of plants and species
- Drawing, layout plans for the plants or green walls
- Calculation showing the density of the plant is adequate
- A statement from plant supplier that the plants selected are suitable to be planted in indoor environment
- A Horticultural Maintenance Plan in one A-4 page which addresses, in minimum, the location of the plants, the watering and cleaning requirements, identification of plant disease and plant replacement regime
- A statement from the Applicant to substantiate that no herbicides, pesticides, electricity from fossil fuelled generation is use on the plants

31. Pre-Occupancy Flush Out (BEAM Plus IEQ 4)

31.1. Tasks to be implemented

The Contractor, upon completion of construction and all interior finishes and after the installation of all fixed furniture and furnishings, shall flush out the occupied space to remove the contaminates. The flushing duration shall be calculated to determine the

fresh air required to achieve the <u>IAQ Certification Excellent Class</u> requirements. During the flushing out period, there should be no construction or renovation activities in the vicinity of the space being flushed

31.2. Specific Requirements for Monitoring and Auditing

The general requirement for monitoring, auditing and control can be found in section 2.4 of this Specification.

31.3. Submittal Documentation

The Contractor shall submit the following to demonstrate compliance:

- Calculation showing the fresh air required for flushing can comply with IAQ
 Certification Excellent Class requirements
- Method statement, with details of the flush out procedures
- Record photographs, taking during flush-out period
- Logbook with date, outdoor delivery rates, flushing duration, internal temperature, humidity shall be indicated.
- Showing the outdoor air required for flushing

32. Tenant Exhaust (BEAM Plus IEQ 5)

32.1. Tasks to be implemented

The Contractor shall provide independent exhaust to all photocopy / printing rooms and locations with signification indoor pollution sources with sufficient exhaust rate. The Contractor shall ensure the discharge of the exhaust louvers shall not face or at a minimum distance of 7m to other intake locations points or louvers.

32.2. Specific Requirements for Monitoring and Auditing

The general requirement for monitoring, auditing and control can be found in section 2.4 of this Specification.

32.3. Submittal Documentation

The Contractor shall develop and submit a measurement report showing:

- Drawings, with location layout, section, elevations for each rooms, including E&M layout drawings, engineering schematic sections and associated ductwork layouts
- Fan exhaust schedules
- Calculation that exhaust rate of 2.5liters per second/sqm, control panel and power consumption
- Commissioning records
- Manufacturer's catalogue, technical data sheet for exhaust fan(s)
- Record photographs.

33. Uncontrolled Ventilation (BEAM Plus IEQ 6)

33.1. Tasks to be implemented

The contractor shall carry out on-site testing using a non-balanced test method to demonstrate air leakage in accordance with ASTM E799 and demonstrate the testing results can comply with air leakage rates as stipulated in COBSE TM23:2000

33.2. Specific Requirements for Monitoring and Auditing

The general requirement for monitoring, auditing and control can be found in section 2.4 of this Specification.

33.3. Submittal Documentation

The contractor shall develop and submit a measurement report showing:

- Method statement, ASTM E779 testing
- Drawing, floor plan with location testing highlighted
- Testing report complied with CIBSE TM23:2000 details of the fan and results
- Record photographs with testing procedure and result taking

34. Interior Lighting Quality (BEAM Plus IEQ 8)

34.1. Tasks to be implemented

The Contractor shall ensure the sub-contractor to install lighting to achieve the prescribed lighting performance provided in the CIBSE lighting code for normally occupied areas in respect of the following:

- Illuminance Level (Lux)
- Illuminance Variation (excluded from areas not normally occupied)
- Uniformity (excluded from areas not normally occupied)
- Glare Index
- Colour Rendering Index (excluded from areas not normally occupied).

34.2. Specific Requirements for Monitoring and Auditing

The general requirement for monitoring, auditing and control can be found in section 2.4 of this Specification.

34.3. Submittal Documentation

- The Contractor shall submit lighting simulation results (Summary table, indicating uniformity, glare index) at different locations of normally occupied areas,
- Drawings or photos showing the provisions of artificial lighting controls, lighting catalogue, lighting layout plan, installation highlighted etc. to demonstrate compliance
- Records, manufacturer's catalogue for lighting installed, and color rendering index (CRI)

35. Acoustics (BEAM Plus IEQ 11)

35.1. Tasks to be implemented

The Contractor shall ensure the background noise level are within the prescribed criteria to ensure the well-being of the occupant and the reverberation time in applicable areas meets the prescribed criteria for given types of premises. The Contractor shall demonstrate airborne noise isolation between rooms, spaces and premises that meet the prescribed criteria.

A. Internal Noise level:

- i. Classrooms NC 35
- ii. Conference rooms NC 35
- iii. Offices NC 40
- iv. Retail shops and restaurants NC 45
- v. Hotel rooms and serviced apartments NC 35
- vi. Function, multi-function, and activity rooms NC 45

B. Reverberation time:

The average reverberation time for mid frequencies (500Hz, 1kHz and 2kHz), shall not exceed:

- i. Classrooms 0.6s
- ii. Conference rooms 0.6s
- iii. Offices 0.6s
- iv. Retail shops, and restaurants 1s
- v. Hotel rooms and service apartments 0.4 to 0.6s
- vi. Function, multi-function and Activity rooms 0.6s

C. Air-borne noise isolation:

- i. Between 2 classrooms STC 37
- ii. Between 2 conference rooms and office/conference STC 48
- iii. Between 2 offices STC 48
- iv. Between 2 retail shops STC 48
- v. Between 2 hotel rooms or serviced apartments STC 52
- vi. Between 2 function or activity rooms STC 52

35.2. Specific Requirements for Monitoring and Auditing

The general requirement for monitoring, auditing and control can be found in section 2.4 of this Specification.

35.3. Submittal Documentation

The contractor shall submit the following documentation below to demonstrate compliance:

Background Noise

- Summary table

- Drawings, architectural, with floor plan layout, measurement locations highlighted
- Acoustic measurement report with valid calibration certificate of sound level meters or calculation
- Certificate, calibration certificate for instrument
- Record photographs, with testing in progress

Reverberation Time

- Summary table
- Drawings, architectural, with floor plan layout, measurement locations highlighted
- Site measurement with supporting documents, absorption coefficients, etc.
- Calculation at representative locations, with supporting documents, absorption coefficients
- Record photographs, with testing in progress

Air-borne Noise Isolation

- Summary table
- Drawings, architectural, with floor plan layout, construction details, measurement locations highlighted
- Site measurement report Leq 5mins, or computer simulation with construction used
- Record photographs, with testing in progress

36. Features Considered as Innovation

36.1. Tasks to be implemented

The Contractor shall install the following latest construction practice in the office

- Real time energy monitoring display installed at entrance for staff or space user to monitor their energy usage
- Achieve excellent class of IAQ certificate scheme.
- Use recycled material for all temporary protection during the construction works
- Applicant's organisation operated an Energy Management System in accordance with ISO 50001 or BS EN 16001

36.2. Specific Requirements for Monitoring and Auditing

The general requirement for monitoring, auditing and control can be found in section 2.4 of this Specification.

36.3. Submittal Documentation

The contractor shall submit the following documentation below to demonstrate compliance:

Real time energy monitoring

- Products catalogues, technical data sheets with materials,
- Drawing, engineering with floor layouts
- Record Photographs, installed products highlighted

IAQ certificate (Excellent class)

- A Valid IAQ certificate or IAQ measurement report shall be conducted by HOKLAS certified service provider should be provided

Recycled material for all temporary protection during the construction works

- Summary table, recyclable material type, source, manufacturer, origins, quantities, usage
- Drawings, architectural with floor plan(s)
- Record photographs, data sheets or logbook for materials
- List responsible person
- The storage method after used

Business's Energy Management System

- Provide the certificate in accordance with ISO 50001 or BS EN 16001









離地工作的安全指引

www.cic.hk

第一版 2016年11月

免責聲明

儘管議會已盡合理努力以確保本刊物所載列資料均屬準確, 惟議會仍鼓勵讀者須在可能的情況下,向其專業顧問尋求適當獨立意見, 並且讀者不應將本刊物視作採取任何相關行動之專業意見的替代, 亦不應依賴本刊物作所述用途。

杳詢

如對本指引有任何查詢·可與議會秘書處聯絡: 建造業議會總辦事處 九龍觀塘駿業街56 號 中海日升中心38 樓

> 電話: (852) 2100 9000 傳真: (852) 2100 9090 電郵: enquiry@cic.hk 網址: www.cic.hk

© 2016 建造業議會。

目錄

序言	Ī		頁	4
1.	簡介.		頁	5
2.	局限		頁	6
3.	風險詞	评估	頁	6
4.	安全位	使用工作平台	頁	7
5.	安全位	使用輕便工作台	頁	11
		管制使用梯子		
7.	使用值	固人防護裝備	頁	14
		和聯絡		
		和控制		
10.	安全資	資料、指導和訓練	頁	15
附件	A	需要使用梯子時應強制實施的條件	頁	16
附件	B	使用梯子的工作許可證範本(僅供參考)		
附件	С	使用梯子核對表	頁	19
附件	- D	參考資料	頁	20

序言

建造業議會(議會)致力在香港建造業的各個範疇不斷改進。為達致此目標‧議會設立委員會、專責小組及建立其他渠道‧檢討特定的工作範疇‧旨在制訂提示、參考資料、指引及操守守則‧協助業界從業員精益求精。

議會欣悉一些改善措施及作業方式可即時推行,同時了解一些調節措施需時較長。基於上述原因,四種不同類別的刊物已被採納,以達致以下目的:

提示 以迅速製作的簡短單張形式,引導相關持份者即時注意就有關建造業

範疇而遵循若干良好作業守則或實施若干預防措施之需要。

參考資料 以普遍獲得業界認同為良好作業標準或模式的「參考資料」。議會建

議業內持份者適當地採納有關「參考資料」。

指引 議會期望所有業內人士採納有關「指引」列出的建議,並無時無刻遵

守有關所列標準或程序。期望業內人士能就任何偏離有關建議的行為,

作出合理解釋。

操守守則 建造業議會條例(第587章)下·議會負責制定操守守則和執行有關

守則。議會發出的「操守守則」,列有所有相關業內人士應遵循的原

則。議會必要可採取行動,以確保有關「守則」之執行。

議會歡迎嘗試遵循本刊物的人士‧向議會提出寶貴意見。請閣下填寫隨刊物附上的意見反饋 表‧以便議會進一步優化本刊物的內容‧讓所有相關人士受惠。隨著各方同心協力‧相 信建 造業將持續發展‧邁向興旺繁盛的未來。

1. 簡介

- 1.1 不安全的離地工作(即不能在地面上或從地面處或從永久性構築物的某部分進行的工作)是高處墮下意外的其中一個主要原因,導致嚴重受傷甚至死亡。然而,若能提供及妥為使用適當的工作平台,大部分意外是可以防止的。在部分嚴重及死亡個案中,使用梯子的管制(如有)非常鬆散、亦未有充分考慮有關工作的特定因素,如工作地點和性質等而進行風險評估及制訂施丁方案。
- 1.2 進行任何離地工作,均必須先考慮使用適當的工作平台作為支持設施。2 米以下因特別工作情況而未能搭建工作平台的離地工作(例如狹窄的工作空間),則必須使用適當的輕便工作台。除在非常特殊的情況下不能使用工作平台或輕便工作台,否則不准使用梯子作離地工作。若需在非常特殊的情況下使用梯子,須先進行因應工作而特定的風險評估及制定和實施安全工作系統,例如工作許可證制度。梯子不可用作任何2 米或以上的離地工作。
- 1.3 此刊物參考了安全工作系統及安全管理系統的核心要素,並建議預防措施以加強離地工作安全,包括因應工作而特定的風險評估、合適的施工方案、使用適當的工作平台或其他用作支持的安全設施及使用梯子的嚴格管制。

2. 局限

2.1 必須留意,遵從此刊物的內容並不會免除在香港的法律責任。僱主及承建商仍需遵守和符合法定條款、有關工作守則及其他政府部門的要求,以履行其有關離地工作的法律和其他相關的責任。

3. 風險評估

- 3.1 有關離地工作·僱主及承建商需在開展工作前進行因應工作而特定的風險評估·從而制訂安全施工方法·並實施合適的安全預防措施和程序·以防止及消除與工作有關的危害。首先·應盡可能避免離地工作·例如設計及使用特定的手工具·令有關工作可在地面完成(例如使用長杆)。
- 3.2 假若真正需要離地工作·僱主及承建商在制訂和實施有效的安全措施時·需考慮所有相關因素·包括工作性質、需使用的設備和物料、工作高度及工作環境等。

4. 安全使用工作平台

- 4.1 無論何時·在進行風險評估後仍不能避免離地工作·不論其工作高度·必須提供及使用合適的工作平台(例如流動工作平台)。
- 4.2 工作平台需適當地設計和構造。工作平台的所有構件應以合適及就其用途而言有足夠 強度和荷載能力的質佳物料造成,日無明顯欠妥之處。
- 4.3 工作平台應在穩固、平坦和水平的地面上搭建。工作平台的周圍應無廢物和雜物。
- 4.4 應禁止在無製造商提供原廠配件以加強工作平台的穩定性的情況下,在斜坡、樓梯、不穩固或不平整的地面,或在工作平台可能被移動中的物件擊中或踫撞的地點,搭建和使用工作平台。
- 4.5 工作平台的周圍應無外露的帶電金屬部分或有可能外露的帶電導體·以防止電力危害。
- 4.6 工作平台應設有適當的進出口(例如設有合適扶手的斜梯或直梯)。 在上落工作平台時,工人應與平台保持三點接觸(即用雙手抓緊及同時以單腳站穩,或雙腳站穩及單手抓緊)。工人應將其重心保持在工作平台內及不應令平台超載。在使用工作平台前和正在使用平台時,工人應留意頭頂上的空間並查看有否障礙物,以防止意外地撞擊頭部。每名工人均應配戴附有下頷帶(俗稱:帽帶)的安全帽。



在流動工作平台內攀上/攀下流動工作平台



在使用工作平台前和正在使用平台 時·工人應留意頭頂上的空間並查 看有否障礙物·以防止意外地撞擊頭 部。應配戴附有下頷帶的安全帽

- 4.7 應嚴格跟從使用手冊內的高度與底邊比率及其他安全建議 絕不可任意將流動工作平台加高至超出製造商的建議高度。如有需要.應根據製造商的要求完全伸展支撐腳以確保工作平台有穩固的基座及其穩定性。
- 4.8 在使用時,工人不應把身體過分探出工作平台之外。需留意製造商規定的安全負載能力,絕不可在工作平台上放置過量物料,以避免超載和損壞工作平台。除按所需供人進入或搬運物料的時間和程度暫時移開護欄和底護板外,工作平台上的所有護欄和底護板應保持架設,並應於其後盡快將其回復原位或架設。嚴禁站立在工作平台的底護板或護欄上(不論中欄或高欄)。




不可把身體過分探出工作平台 之外




不可依靠在工作平台的護欄上

- 4.9 如在戶外使用工作平台·需留意天氣情況。 絕不可用帆布遮蓋工作平台·以避免平台在強風下翻側。 在合理可行情況下·應把工作平台加固或繫穩於永久構築物上·以加強其穩定性。遇有颱風或惡劣天氣時·需立即停止使用工作平台·並適當地穩固平台以防止平台在大風下翻倒·或將其拆卸並保存在安全的地方。
- 4.10 在上落和使用流動工作平台時,應牢固地鎖上平台的所有腳輪。

- 4.11 把流動工作平台移到另一工作地點時,不可容許任何人在平台上停留,或在平台上放置任何有可能增加平台翻倒的風險的物品或可能會在平台移動時跌下的鬆散物件(如手工具)。而且,應避免於粗糙及不平坦的地面移動流動工作平台,令工作平台有機會倒塌或翻側。
- 4.12 如發現工作平台損壞,需立即停止使用平台,並標示適當的告示和警告通知。
- 4.13 使用完畢後,應妥為存放和保養工作平台。

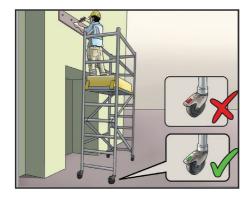


上落和使用流動工作平台時·確保平台 的所有腳輪已經牢固地鎖上

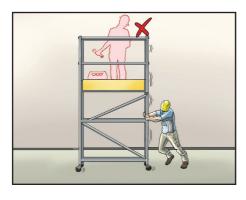

在移動流動工作平台時,不應容許有人 在平台上站立,及在平台上放置任何有 可能增加平台翻倒的風險的物品或可能 會在平台移動時跌下的鬆散物件(如手 工具)

5. 安全使用輕便工作台

5.1 2米以下因特別工作情況(例如狹窄的工作空間)而未能搭建工作平台的離地工作,以及有關工作是屬於簡單性質時,應考慮使用適當的輕便工作台,例如梯台或功夫標。在使用輕便工作台時,應跟從以下的特定安全措施

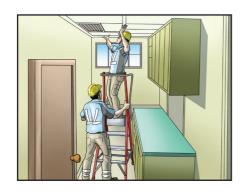


利用梯台在一個空間有限而未能容納一般 工作平台的房間檢查通風系統

- 5.2 應緊記在每個輕便工作台上只准許一人工作。
- 5.3 使用輕便工作台的工人應已接受由供應商提供的相關安全訓練,包括搭建和拆卸工作台,或其他相等的訓練,令他們清楚了解製造商的安全指示或使用手冊。
- 5.4 在使用輕便工作台前,應按供應商提供的安全核對表或其他相等的安全核對表進行檢查 (包括目測),以確保工作台狀況良好及沒有損壞。此外,在踏上工作台前,輕便工作 台的穩定裝置或支撐腳應根據製造商的使用手冊完全伸展及鎖好,以確保其穩定性。




在使用輕便工作台前·應按供應商提供的安全核對表或其他相等的安全核對表 進行檢查(包括目測)

5.5 工人在上落輕便工作台時·應面向工作台。不要對工作台施加過大力量而引發橫向力,令工作台翻側。

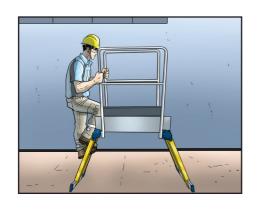

工人在上落輕便工作台時·應面向工作 台

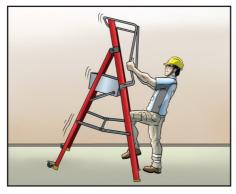

不要對工作台施加過大力量而引發橫向 力·令工作台翻側

6. 嚴格管制使用梯子

- 6.1 正常情況下梯子只可作為進出之用。除在非常特殊的情況下並經進行因應工作而特定的風險評估後,梯子不應用作離地工作。在任何情況下,梯子不應用於2米或以上的高處工作。在可行情況下,梯子尤其不應用於電力工作,因為即使是輕微觸電,亦會今工人失去平衡,導致由高處隨下。
- 6.2 若不能避免使用梯子,應予以嚴格管制,例如透過實施工作許可證制度,以確保有足夠和適當的管制及安全措施,保護有關工人。 使用梯子的工作許可證,應由東主/僱主/承建商指定,並因其所受有關風險評估及工作許可證的實質訓練及實際經驗而有足夠能力執行該職責的合資格的人,在進行因應工作而特定的風險評估和採取所有有關使用梯子所需的安全措施後簽發。如實施工作許可證制度是不可行,應在使用梯子前以核對表進行檢查。若不能避免使用梯子進行電力工作,工作許可證制度或工作前檢查亦須涵蓋其他適當的風險消減措施,例如使用不導電的梯子。
- 6.3 以下是一些工作許可證(即指使用梯子的工作許可證)制度的指引和主要元素:

準備階段:

- 應清晰地指派可以批准有關工作的人,並向有關工人公布:
- 應向有關人員提供適當的簽發、使用及終止許可證的訓練和指示;
- 應在許可證上清楚描述和列明需進行的工作、工作地點、 開始時間和許可證的有效期;
- 應進行因應工作而特定的風險評估,以識別工作場所的潛在危害;
- 應檢查工作地點和將會使用的設備;及
- 應仔細考慮所需的安全預防措施,以將擬進行的工作的相關風險減至最低, 並應妥為記錄。

工作進行階段:

- 在未發出許可證或許可證期滿時,不得進行工作;
- 應妥為實施、監察和控制工作許可證及所需預防措施;
- 在輪班時應妥為移交責任(如適用),並在許可證上清楚描述;及
- 在有關離地工作施工期間,應妥為張貼許可證。

完成工作後階段:

- 在所需工作完成後·應採取適當步驟把場地回復原狀·以確保在移交場地前 消除任何殘留風險;及
- 應妥為保存工作許可證一段合理時間,作為記錄及日後參考。
- 6.4 只有在工作場所有限制、令搭建任何工作平台不可行的情況下·方可考慮在少於2米 高的離地工作准許使用梯子。附件A列出在上述情况下應強制實施的條件。
- 6.5 工作許可證和評估使用梯子的核對表的範本分別載於附件B及C。

7. 使用個人防護裝備

7.1 使用個人防護裝備以防止工人從高處墮下應經常被視為最後的措施。如進行因應工作而特定的風險評估後,在許可情況下需要此類防護措施,應有步驟確保提供、使用和保養適當的個人防護裝備及其繫穩系統,而有關工人正確地使用這些裝備。

8. 協調和聯絡

- 8.1 在僱主/承建商、不同級別的管理/監督人員和工人之間應建立及維持一個有效的協調和聯絡系統,以確保清楚了解潛在危害、相關的危害控制計劃和安全責任的劃分。
- 8.2 總承建商和分判商應清楚劃分他們在提供和使用工作平台、及限制使用梯子方面的角 色和責任,例如诱渦協議或合約。

9. 監察和控制

- 9.1 應發展、實施和維持一個有效的監察及控制系統·以確保離地工作的安全工序和安全措施。
- 9.2 若發現任何不安全的工作狀況·僱主/承建商應立即暫停有關工作。暫停的工作在有效地實施所需的改善措施後·方可繼續。

10. 安全資料、指導和訓練

10.1 應向工人和工地監督人員提供所需的安全資料、指導和訓練,以確保他們均熟悉從高處墮下的潛在危害、離地工作的安全施工方法和安全措施。

需要使用梯子時應強制實施的條件

- i) 梯子的設計和構造應適合所需工作。在上落和在工作位置時,梯子應有充足的踏腳處 和握手處;
- ii) 梯子應有足夠強度及並無欠妥之處;
- iii) 梯子應放置在穩固、平坦和水平的地面上,梯子應充分地繫牢和保持穩定;
- iv) 應禁止在梯子上進行劇烈和繁重的工作;
- v) 應限制在梯子上工作的站立高度和時間;
- vi) 應遵從安全工序和使用適當設備 / 工具;
- vii) 應向所有職級的工地人員‧包括工人和監工‧提供在梯子上工作的足夠資料、指導和 訓練‧以有效地向他們傳達使用梯子的相關危害‧及在工作許可證制度下需實施的條 件;及
- viii) 應建立和實施一個有效的監察及控制系統,以確保全面執行工作許可證制度。

使用梯子的工作許可證範本(僅供參考)

**除在非常特殊的情況下,不應使用梯子作離地工作

所有部分需由合資格的人進行

第一部分

公司名稱:	聯絡電話:	
合資格的人的姓名:	職位:	
日期:	工作期間:	由至
工作地點:		
工作描述:		

第二部分

項目	描述	是	否
1.	是項工作可使用正式的工作平台或其他適當的支持方法。		
2.	2. 是項工作為時短暫。		
3.	是項工作性質簡單。		
4.	是項工作需使用重型設備 / 工具。		
5.	梯子的設計和構造適合使用在是項工作。		

^{*}如任何問題的答案落在灰色方格內,便不應使用梯子。

第三部分

項目	描述	是	否
1.	放置梯子的地面是穩固、平坦和水平的。		
2.	周圍沒有被移動中的物件擊中或踫撞的風險。		
3.	周圍沒有外露的帶電金屬部分或外露的帶電導體。		

4.	站立在梯子上時‧頭頂有足夠空間防止意外地撞擊工人 的頭部。			
5.	梯子穩固.沒有損壞及欠妥之處。			
6.	梯子放置在正確的位置,工作時無需過分探出身體。			
7.	梯子的撐檔或類似控制裝置(但不是尼龍繩)完全伸展及 穩妥地固定。			
8.	所有梯腳均裝有防滑腳·放置在相同的平面·並與地面有 良好接觸。			
9.	上落或在梯子上工作時,可保持與梯子有3點接觸。			

<u> </u>			
使用梯子:	不准許	准許	
合資格的人簽署: 合資格的人姓名: 職位: 日期:			

第四部分 (完成工作後使用)

項目	描述	是	否
1.	場地已回復原狀。		
2.	所有殘留風險已消除。		
3.	梯子已移走及鎖上。		

合資格的人簽署	:
合資格的人姓名	:

職位: 日期:

使用梯子核對表

除在非常特殊的情況下·梯子應只限於進出之用。而在任何情況下·梯子不應用於2米或以上的高處工作。在可行情況下·梯子尤其不應用於電力工作。

項目	描述	是	否
甲部	如甲部任何問題的答案落在灰色方格內,便不應使用梯子。		
1.	是項工作可使用正式的工作平台或其他支持方法。		
2.	是項工作為時短暫。		
3.	是項工作性質簡單。		
4.	是項工作需使用重型設備 / 工具。		
5.	梯子的設計和構造適宜使用在是項工作。		
	甲部完		
乙部	使用梯子前應滿足以下條件。		
1.	放置梯子的地面是穩固、平坦和水平的。		
2.	周圍沒有被移動中的物件擊中或踫撞的風險。		
3.	周圍沒有外露的帶電金屬部分或外露的帶電導體。		
4.	站立在梯子上時‧頭頂有足夠空間防止意外地撞擊工人的 頭部。		
5.	梯子穩固・沒有損壞及欠妥之處。		
6.	梯子放置在正確的位置,工作時無需過分探出身體。		
7.	梯子的撐檔或類似控制裝置(但不是尼龍繩)完全伸展及穩 妥地固定。		
8.	所有梯腳均裝有防滑腳·放置在相同的平面·並與地面有良 好接觸。		
9.	攀上或在梯子上工作時,可保持與梯子有3點接觸。		

附件D

參考資料

- 1. 職業安全及健康條例(509章)及其附屬規例
- 2. 工廠及工業經營條例(59章)及其附屬規例
- 3. 金屬棚架工作安全守則,勞工處刊物
- 4. 建築地盤(安全)規例VA部有關安全工作地方的條文簡介,勞工處刊物
- 5. 慎防從高處墮下,勞工處刊物
- 6. 建築地盤工作安全及健康事項查核表,勞工處刊物
- 7. 安全工作系統,勞工處刊物
- 8. 風險評估五部曲,勞工處刊物
- 9. 使用輕便工作台及流動工作台的安全指南,職業安全健康局刊物

CIC INNOVATION CENTER

TENDER DRAWING

PROJECT NO: APQ-17-0117


ISSUE DATE: 17 MAY 2017 (R1)



	ING LIST						DIMO NO	04	
PROJE	,				PROJECT REF.		DWG. NO.	01	
DWG. N	IO. TITLE	SCALE	REV.	DATE	DWG. NO.	TITLE	SCALE	REV.	DATE
PL-01	LAYOUT PLAN	A3=1:150		02-05-2017	EL-12 ELEVA	ATION - EXHIBITION AREA	AS SHOWN		02-05-2017
PL-01A	INDICATION PLAN	A3=1:150		02-05-2017	EL-13 ELEVA	ATION - OFFICE AREA	AS SHOWN		02-05-2017
PL-01B	DEMOLITION PLAN	A3=1:150		02-05-2017	EL-14 ELEVA	ATION - OFFICE AREA	AS SHOWN		02-05-2017
PL-02A	CEILING PLAN	A3=1:150		02-05-2017	EL-15 ELEVA	ATION - CEO OFFICE	AS SHOWN	А	11-05-2017
PL-02B	CEILING LIGHT SETTING OUT PLAN	A3=1:150		02-05-2017	EL-16 ELEVA	ATION - MEETING ROOM	AS SHOWN	А	11-05-2017
PL-02C	LIGHTING WIRING PLAN	A3=1:150		02-05-2017	EL-17 ELEVA	ATION - F. TOILET	AS SHOWN		02-05-2017
PL-03A	ELECTRICAL PLAN	A3=1:150	Α	11-05-2017	EL-18 ELEVA	ATION - M. TOILET	AS SHOWN		02-05-2017
PL-03B	ELECTRICAL CIRCUIT PLAN	A3=1:150	А	11-05-2017	EL-19 ELEVA	ATION - DISABLE TOILET	AS SHOWN		02-05-2017
PL-04	P&D PLAN	A3=1:150		02-05-2017	EL-20 ELEVA	TION - CORRIDOR	AS SHOWN		02-05-2017
PL-05	MVAC PLAN	A3=1:150		02-05-2017	EL-21 ELEVA	ATION - FOCUS GROUP MEETING RM. 1	AS SHOWN	А	11-05-2017
PL-06	SETTING OUT PLAN	A3=1:150		02-05-2017	EL-22 ELEVA	TION - FOCUS GROUP MEETING RM. 1	AS SHOWN	А	11-05-2017
PL-07A	FLOOR FINISH PLAN	A3=1:150		02-05-2017	EL-23 ELEVA	ATION - FOCUS GROUP MEETING RM. 2	AS SHOWN	А	11-05-2017
PL-07B	FLOOR FINISH SETTING OUT PLAN	A3=1:150		02-05-2017	EL-24 ELEVA	ATION - FOCUS GROUP MEETING RM. 2	AS SHOWN	А	11-05-2017
PL-08	WALL FINISH PLAN	A3=1:150	А	11-05-2017	EL-25 ELEVA	ATION - STORE 2	AS SHOWN		02-05-2017
PL-09	LOOSE FURNITURE PLAN	A3=1:150	А	11-05-2017	EL-26 ELEVA	ATION - BOH	AS SHOWN		02-05-2017
PL-10	SCHEMATIC DIAGRAM & MCB DETAILS	A3=1:150	А	11-05-2017	EL-27 ELEVA	ATION - BOH	AS SHOWN		02-05-2017
EL-01	ELEVATION - OUTDOOR AREA	AS SHOWN		02-05-2017					
EL-02	ELEVATION - OUTDOOR AREA	AS SHOWN		02-05-2017					
EL-03	ELEVATION - OUTDOOR AREA	AS SHOWN	А	11-05-2017					
EL-04	ELEVATION - OUTDOOR AREA	AS SHOWN	А	11-05-2017					
EL-05	ELEVATION - OUTDOOR AREA	AS SHOWN		02-05-2017					
EL-06	ELEVATION - OUTDOOR AREA	AS SHOWN		02-05-2017					
EL-07	ELEVATION - RECEPTION AREA	AS SHOWN	А	11-05-2017					
EL-08	ELEVATION - RECEPTION AREA	AS SHOWN		02-05-2017					
EL-09	ELEVATION - EXHIBITION AREA	AS SHOWN		02-05-2017					
EL-10	ELEVATION - EXHIBITION AREA	AS SHOWN		02-05-2017					
EL-11	ELEVATION - EXHIBITION AREA	AS SHOWN		02-05-2017					

PROJECT	CIC INNOVATION CENTER (IC)				PROJEC	T REF.		1	DWG. NO.	01	
DWG. NO.	TITLE	SCALE	REV.	DATE	DWG. NO	Э.	TITLE	(SCALE	REV.	DATE
D-01A DE	TAIL - RECEPTION COUNTER	AS SHOWN	Α	11-05-2017	DR-01	DOOR S	SCHEDULE	,	AS SHOWN		11-05-2017
D-01B DE	TAIL - RECEPTION COUNTER	AS SHOWN	А	11-05-2017	DR-02	DOOR	SCHEDULE	,	AS SHOWN		11-05-2017
D-02A DE	TAIL - PLATFORM	AS SHOWN		02-05-2017	DR-03	DOOR	SCHEDULE	,	AS SHOWN		11-05-2017
D-02B DE	TAIL - PLATFORM	AS SHOWN		02-05-2017	DR-04	DOOR	SCHEDULE	,	AS SHOWN		11-05-2017
D-03A DE	TAIL - PANTRY	AS SHOWN		02-05-2017							
D-03B DE	TAIL - PANTRY	AS SHOWN		02-05-2017							
D-04 DE	TAIL - BAR TABLE	AS SHOWN		02-05-2017							
D-05 DE	TAIL - PRINTING AREA CABINET	AS SHOWN		02-05-2017							
D-06 DE	TAIL - CURVED COLUMN	AS SHOWN		02-05-2017							
D-07 DE	TAIL - FEMALE TOILET BASIN CABINET	AS SHOWN		02-05-2017							
D-08 DE	TAIL - MALE TOILET BASIN CABINET	AS SHOWN		02-05-2017							
D-09 DE	TAIL - LOUNGE BENCH	AS SHOWN		02-05-2017							
D-10A DE	TAIL - OUTDOOR BENCH	AS SHOWN		11-05-2017							
D-10B DE	TAIL - OUTDOOR BENCH	AS SHOWN		11-05-2017							
D-10C DE	TAIL - OUTDOOR BENCH	AS SHOWN		11-05-2017							
D-11 DE	TAIL - RECEPTION LED WALL	AS SHOWN		11-05-2017							
D-12 DE	TAIL - OUTDOOR LED PANEL	AS SHOWN		11-05-2017							
D-13 DE	TAIL - CURVED WALL	AS SHOWN		11-05-2017							
D-14 DE	TAIL - SIGNBOARD	AS SHOWN		11-05-2017							
D-15 DE	TAIL - HANDRAILS	AS SHOWN		11-05-2017							



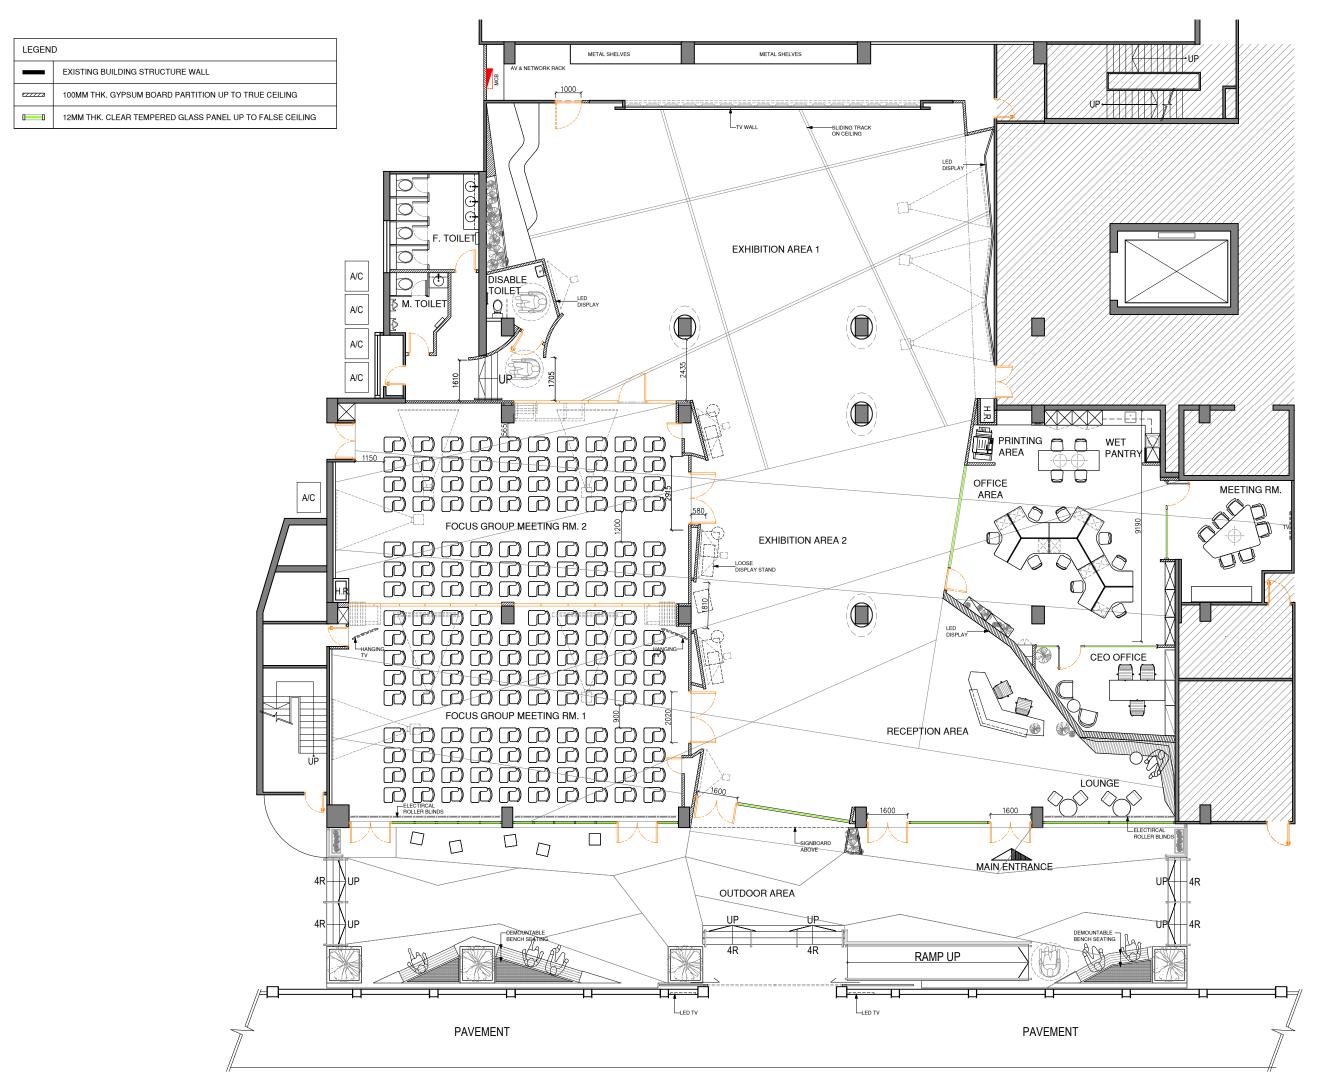



REVISI	ON	
REV.	DESCRIPTION	DATE
$\overline{\bigcirc}$		
\bigcirc		
$\overline{\bigcirc}$		
$\widetilde{\bigcirc}$		
<u> </u>		
NOTES		

ALL DESIGN ARE THE PROPERTY OF AL DESIGN & ASSOCIATES LTD. AND CANNOT BE USED WITHOUT THEIR WRITTEN

ALL MEASUREMENT MUST BE VERIFIED ON SITE BEFORE CONSTRUCTION. CONTRACTOR SHALL NOTIFY THE DESIGNER OF ANY DISCREPANCY BEFORE STARTING WORK. AL DESIGN & ASSOCIATES LTD. WILL NOT RESPONSIBLE FOR ANY ERRORS SHOULD THE CONTRACTOR FAIL TO OBSERVE THIS PROCEDURE. THE CONTRACTOR SHALL BE RESPONSIBLE FOR ANY ERRORS RESULTINGS FROM FAILURE TO DO SO.

CLIENT

CIC Innovation Center (IC)

PROJECT

G/F, 44 Tai Yip Street Kowloon Bay, Hong Kong


DRAWING TITLE

LAYOUT PLAN

SCALE	DATE
1:150 (A3)	26 . 04 . 2017
DRAWN BY	DESIGNED BY
JH/ SC	AY

PROJECT NO PL-01 APQ-17-0117

APQ17-0117 Layout (current).dwg

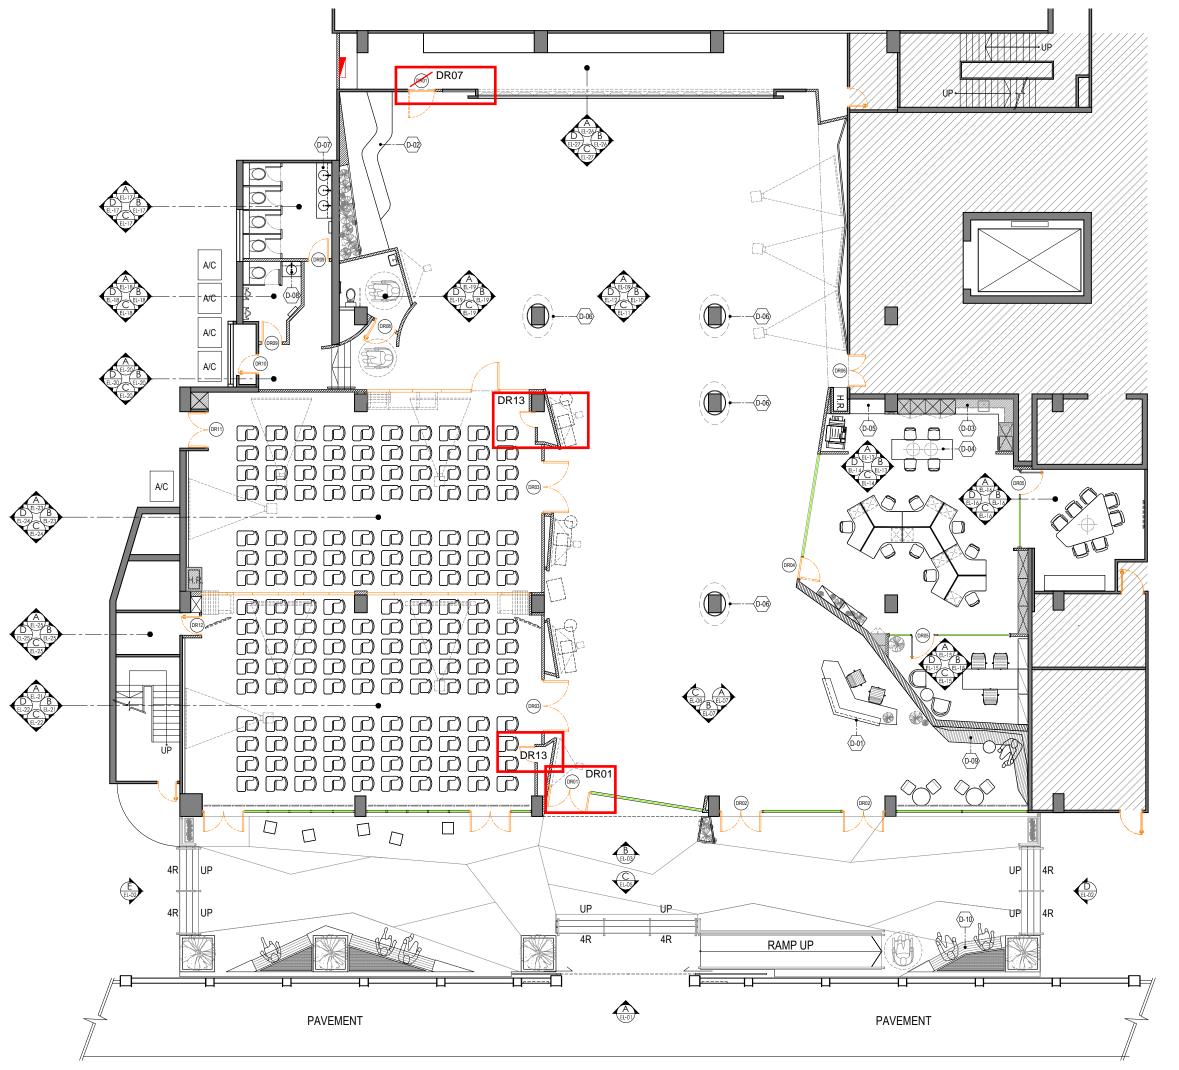



	DATE
$\overline{}$	
$\widetilde{}$	
$\frac{\mathcal{I}}{\mathcal{I}}$	
$\frac{\mathcal{L}}{\mathcal{L}}$	
<u>)</u>	
<u>)</u>	
\supset	
$\overline{\bigcirc}$	
$\widetilde{}$	
\sim	
\mathcal{L}	
OTES	
OTES	

ALL DESIGN ARE THE PROPERTY OF AL DESIGN & ASSOCIATES LTD. AND CANNOT BE USED WITHOUT THEIR WRITTEN

SITE BEFORE CONSTRUCTION. CONTRACTOR SHALL NOTIFY THE DESIGNER OF ANY DISCREPANCY BEFORE STARTING WORK. AL DESIGN & ASSOCIATES LTD. WILL NOT RESPONSIBLE FOR ANY ERRORS SHOULD THE CONTRACTOR FAIL TO OBSERVE THIS PROCEDURE. THE CONTRACTOR SHALL BE RESPONSIBLE FOR ANY ERRORS RESULTINGS FROM FAILURE TO DO SO.

CLIENT

CIC Innovation Center (IC)

PROJECT

G/F, 44 Tai Yip Street Kowloon Bay, Hong Kong


DRAWING TITLE

INDICATION PLAN

SCALE	DATE
1:150 (A3)	26 . 04 . 2017
DRAWN BY	DESIGNED BY
JH/ SC	AY

PROJECT NO PL-01A APQ-17-0117

APQ17-0117 Layout (current).dwg

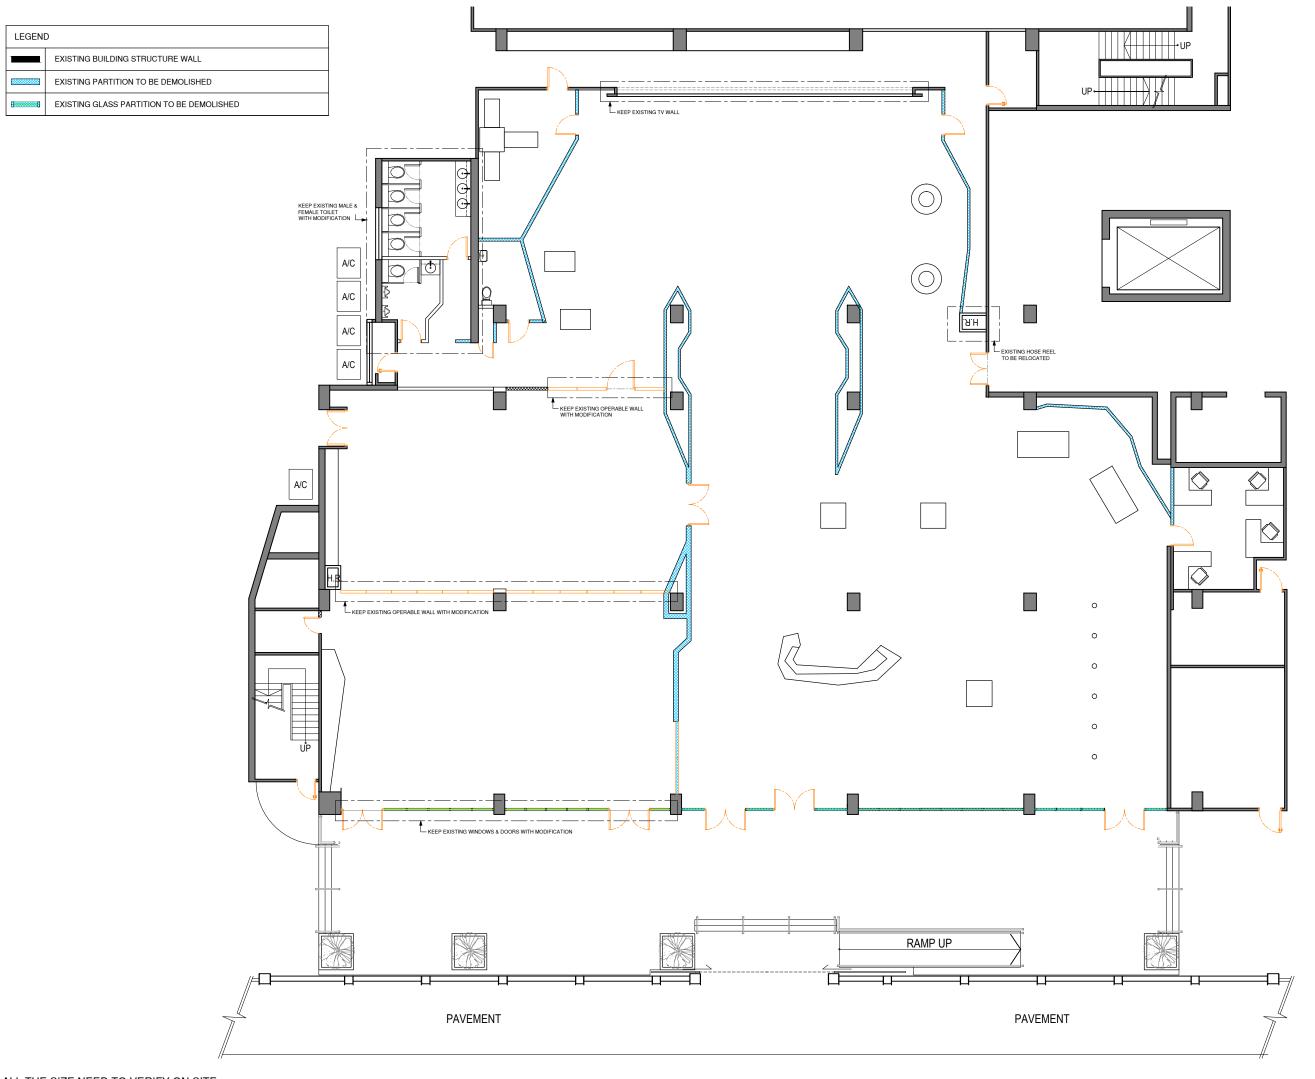



EV.	DESCRIPTION	DATE
$\overline{}$		
\preceq		
$ \leftarrow$		
\prec		
\preceq		
<u>)</u>		
<u>) </u>		
\supset		
$\overline{)}$		
\preceq		
$ \leftarrow$		
<u> </u>		
OTES		

ALL DESIGN ARE THE PROPERTY OF AL DESIGN & ASSOCIATES LTD. AND CANNOT BE USED WITHOUT THEIR WRITTEN PERMISSION.

ALL MEASUREMENT MUST BE VERIFIED ON SITE BEFORE CONSTRUCTION, CONTRACTOR SHALL NOTIFY THE DESIGNER OF ANY DISCREPANCY BEFORE STARTING WORK.
AL DESIGN & ASSOCIATES LTD.
WILL NOT RESPONSIBLE FOR ANY ERRORS SHOULD THE CONTRACTOR FAIL TO OBSERVE THIS PROCEDURE. THE CONTRACTOR SHALL BE RESPONSIBLE FOR ANY ERRORS RESULTINGS FROM FAILURE TO DO SO.

CLIENT

CIC Innovation Center (IC)

PROJECT

G/F, 44 Tai Yip Street Kowloon Bay, Hong Kong

DRAWING TITLE

DEMOLITION PLAN

SCALE	DATE
1:150 (A3)	26 . 04 . 2017
DRAWN BY	DESIGNED BY
JH/ SC	AY


APPROVED

PROJECT NO DWG NO

APQ-17-0117 PL-01B

CAD FILE REF

APQ17-0117 Layout (current).dwg

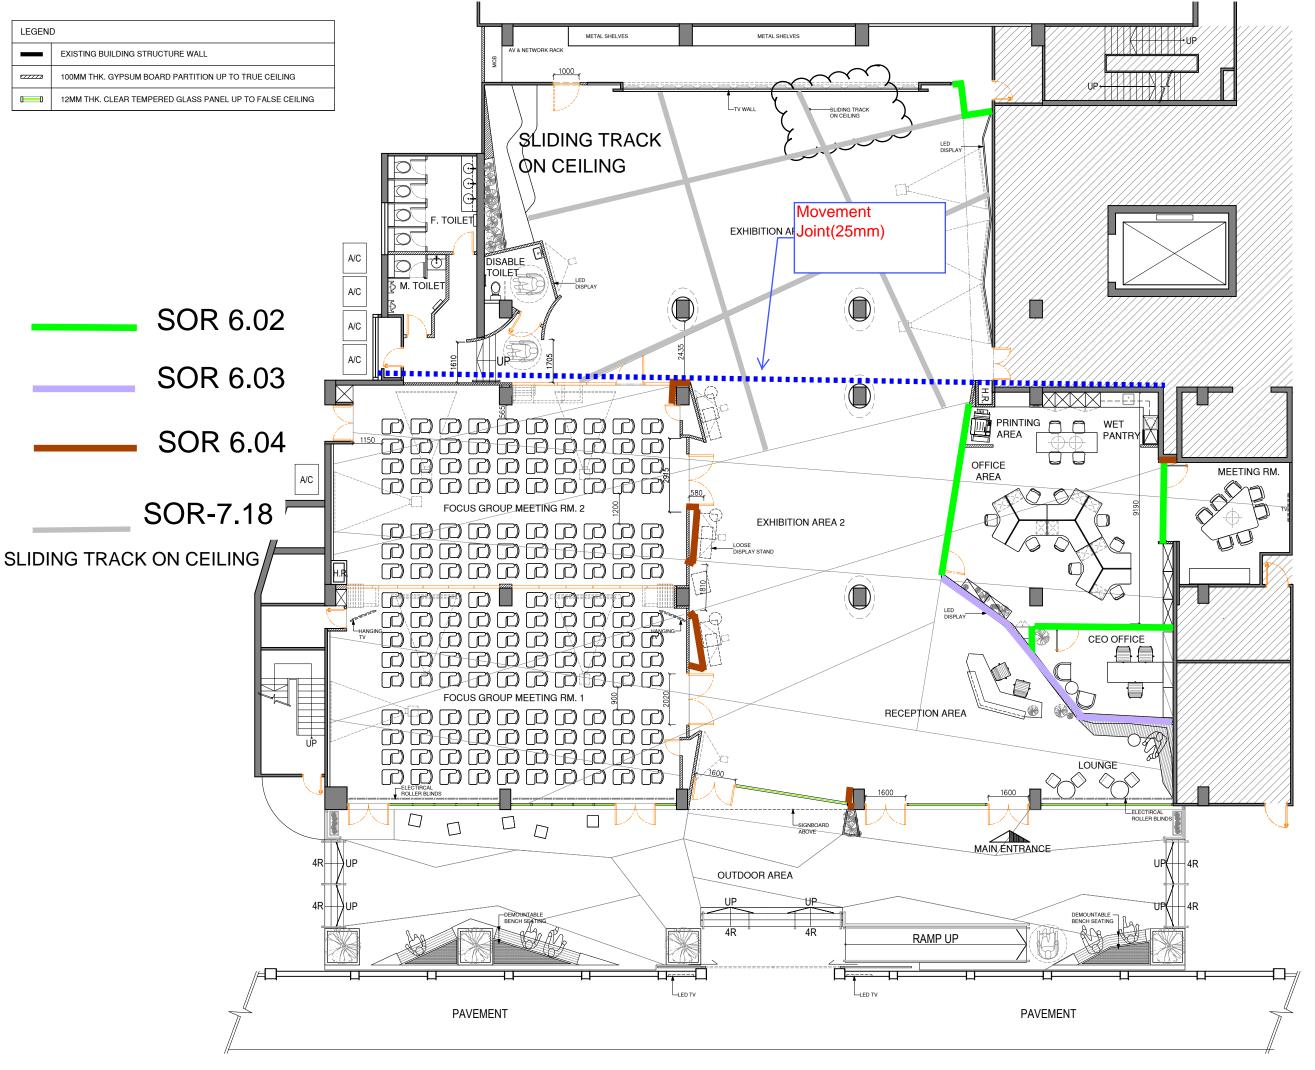



REVISIO	DN	
REV.	DESCRIPTION	DATE
$\overline{\bigcirc}$		
\bigcirc		
NOTES		

ALL DESIGN ARE THE PROPERTY OF AL DESIGN & ASSOCIATES LTD. AND CANNOT BE USED WITHOUT THEIR WRITTEN

ALL MEASUREMENT MUST BE VERIFIED ON SITE BEFORE CONSTRUCTION. CONTRACTOR SHALL NOTIFY THE DESIGNER OF ANY DISCREPANCY BEFORE STARTING WORK AL DESIGN & ASSOCIATES LTD. WILL NOT RESPONSIBLE FOR ANY ERRORS SHOULD THE CONTRACTOR FAIL TO OBSERVE THIS PROCEDURE. THE CONTRACTOR SHALL BE RESPONSIBLE FOR ANY ERRORS RESULTINGS FROM FAILURE TO DO SO.

CIC Innovation Center (IC)

G/F, 44 Tai Yip Street Kowloon Bay, Hong Kong


DRAWING TITLE

LAYOUT PLAN

SCALE	DATE
1:150 (A3)	26 . 04 . 2017
DRAWN BY	DESIGNED BY
JH/ SC	AY

DATE 31.05.2017

PL-01C APQ-17-0117 APQ17-0117 Layout (current).dwg

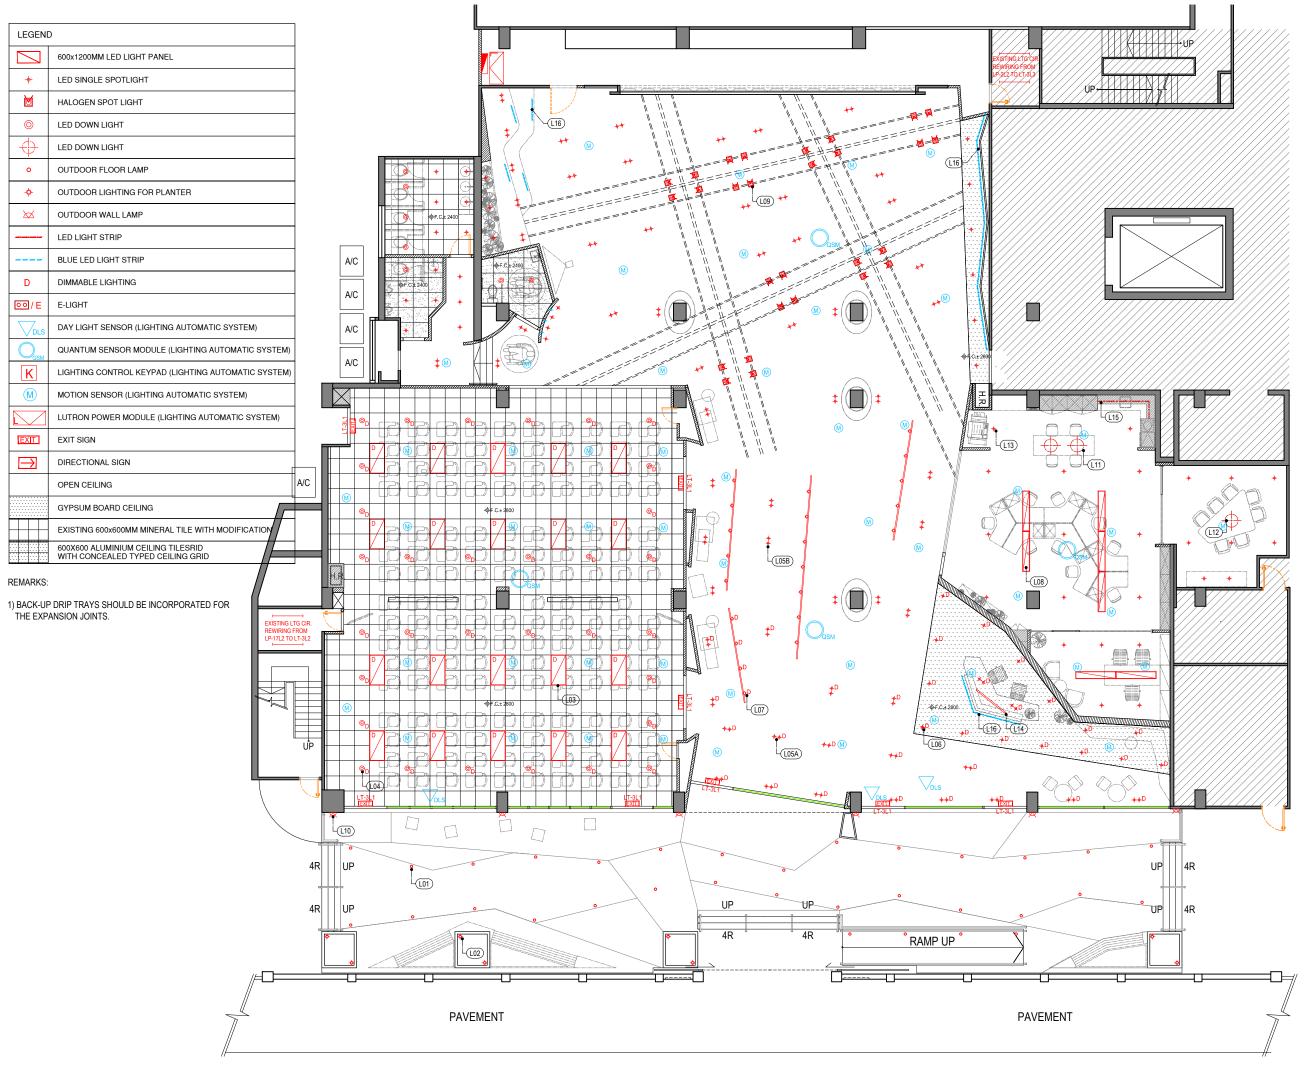



REVISI	ON	
REV.	DESCRIPTION	DATE
$\overline{\bigcirc}$		
$\overline{\bigcirc}$		
$\overline{\bigcirc}$		
$\widetilde{\frown}$		
$\stackrel{\smile}{\sim}$		
$\stackrel{\smile}{\sim}$		
\Rightarrow		
\Rightarrow		
\Rightarrow		
\bigcirc		
NOTES		

ALL DESIGN ARE THE PROPERTY OF AL DESIGN & ASSOCIATES LTD. AND CANNOT BE USED WITHOUT THEIR WRITTEN DEDMISSION

ALL MEASUREMENT MUST BE VERIFIED ON SITE BEFORE CONSTRUCTION. CONTRACTOR SHALL NOTIFY THE DESIGNER OF ANY DISCREPANCY BEFORE STARTING WORK.
AL DESIGN & ASSOCIATES LTD.
WILL NOT RESPONSIBLE FOR ANY ERRORS SHOULD THE CONTRACTOR FAIL TO OBSERVE THIS PROCEDURE. THE CONTRACTOR SHALL BE RESPONSIBLE FOR ANY ERRORS RESULTINGS FROM FAILURE TO DO SO.

CLIENT

CIC Innovation Center (IC)

PROJECT

G/F, 44 Tai Yip Street Kowloon Bay, Hong Kong

DRAWING TITLE

CEILING PLAN

SCALE	DATE
1:150 (A3)	26 . 04 . 2017
DRAWN BY	DESIGNED BY
JH/ SC	AY


APPROVED B

PROJECT NO DWG NO

APQ-17-0117 PL-02A

CAD FILE REF

APQ17-0117 Layout (current).dwg

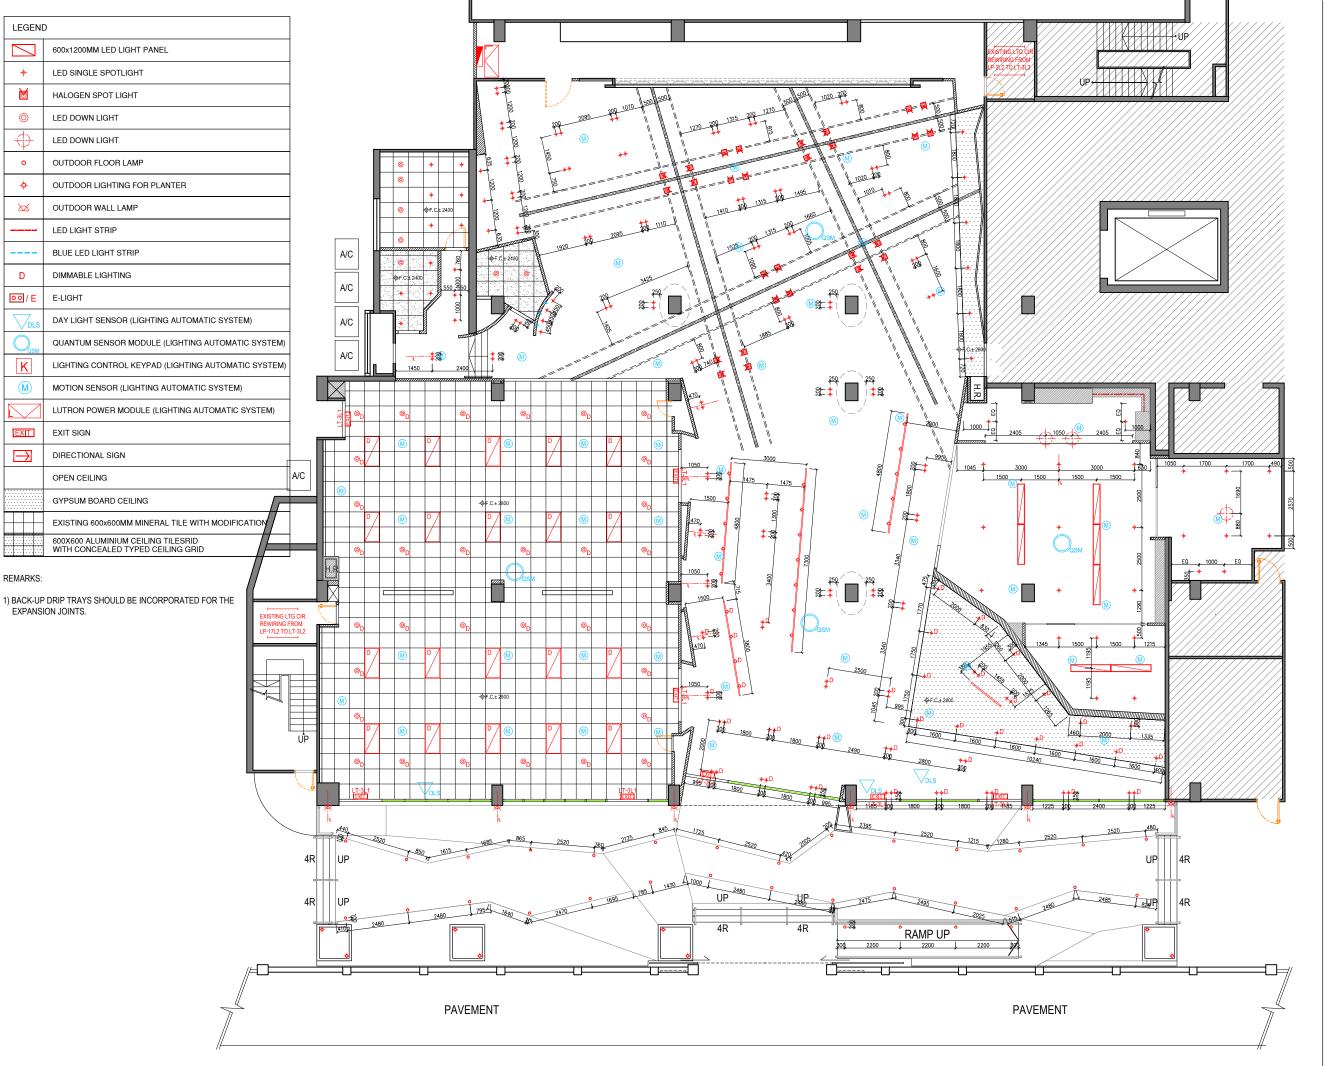



REVISI	ON	
REV.	DESCRIPTION	DATE
$\overline{\bigcirc}$		
Ŏ		
NOTES		

ALL DESIGN ARE THE PROPERTY OF AL DESIGN & ASSOCIATES LTD. AND CANNOT BE USED WITHOUT THEIR WRITTEN DEDMISSION

ALL MEASUREMENT MUST BE VERIFIED ON SITE BEFORE CONSTRUCTION. CONTRACTOR SHALL NOTIFY THE DESIGNER OF ANY DISCREPANCY BEFORE STARTING WORK. AL DESIGN & ASSOCIATES LTD.
WILL NOT RESPONSIBLE FOR ANY ERRORS SHOULD THE CONTRACTOR FAIL TO OBSERVE THIS PROCEDURE. THE CONTRACTOR SHALL BE RESPONSIBLE FOR ANY ERRORS RESULTINGS FROM FAILURE TO DO SO.

CLIENT

CIC Innovation Center (IC)

PROJECT

G/F, 44 Tai Yip Street Kowloon Bay, Hong Kong

DRAWING TITLE

CEILING LIGHT SETTING OUT PLAN

SCALE	DATE
1:150 (A3)	26 . 04 . 2017
DRAWN BY	DESIGNED BY
JH/ SC	AY

APPROVED B

PROJECT NO DWG NO

APQ-17-0117 PL-02B

CAD FILE REF

APQ17-0117 Layout (current).dwg





REVISION	NC	
REV.	DESCRIPTION	DATE
$\overline{\bigcirc}$		
\bigcirc		
NOTES		

ALL DESIGN ARE THE PROPERTY OF AL DESIGN & ASSOCIATES LTD. AND CANNOT BE USED WITHOUT THEIR WRITTEN

SITE BEFORE CONSTRUCTION. CONTRACTOR SHALL NOTIFY THE DESIGNER OF ANY DISCREPANCY BEFORE STARTING WORK. AL DESIGN & ASSOCIATES LTD.
WILL NOT RESPONSIBLE FOR ANY ERRORS SHOULD THE CONTRACTOR FAIL TO OBSERVE THIS PROCEDURE. THE CONTRACTOR SHALL BE RESPONSIBLE FOR ANY ERRORS RESULTINGS FROM FAILURE TO DO SO.


G/F, 44 Tai Yip Street Kowloon Bay, Hong Kong

LIGHTING WIRING PLAN

SCALE	DATE
1:150 (A3)	26 . 04 . 2017
DRAWN BY	DESIGNED BY
JH/ SC	AY

PL-02C

APQ17-0117 Layout (current).dwg

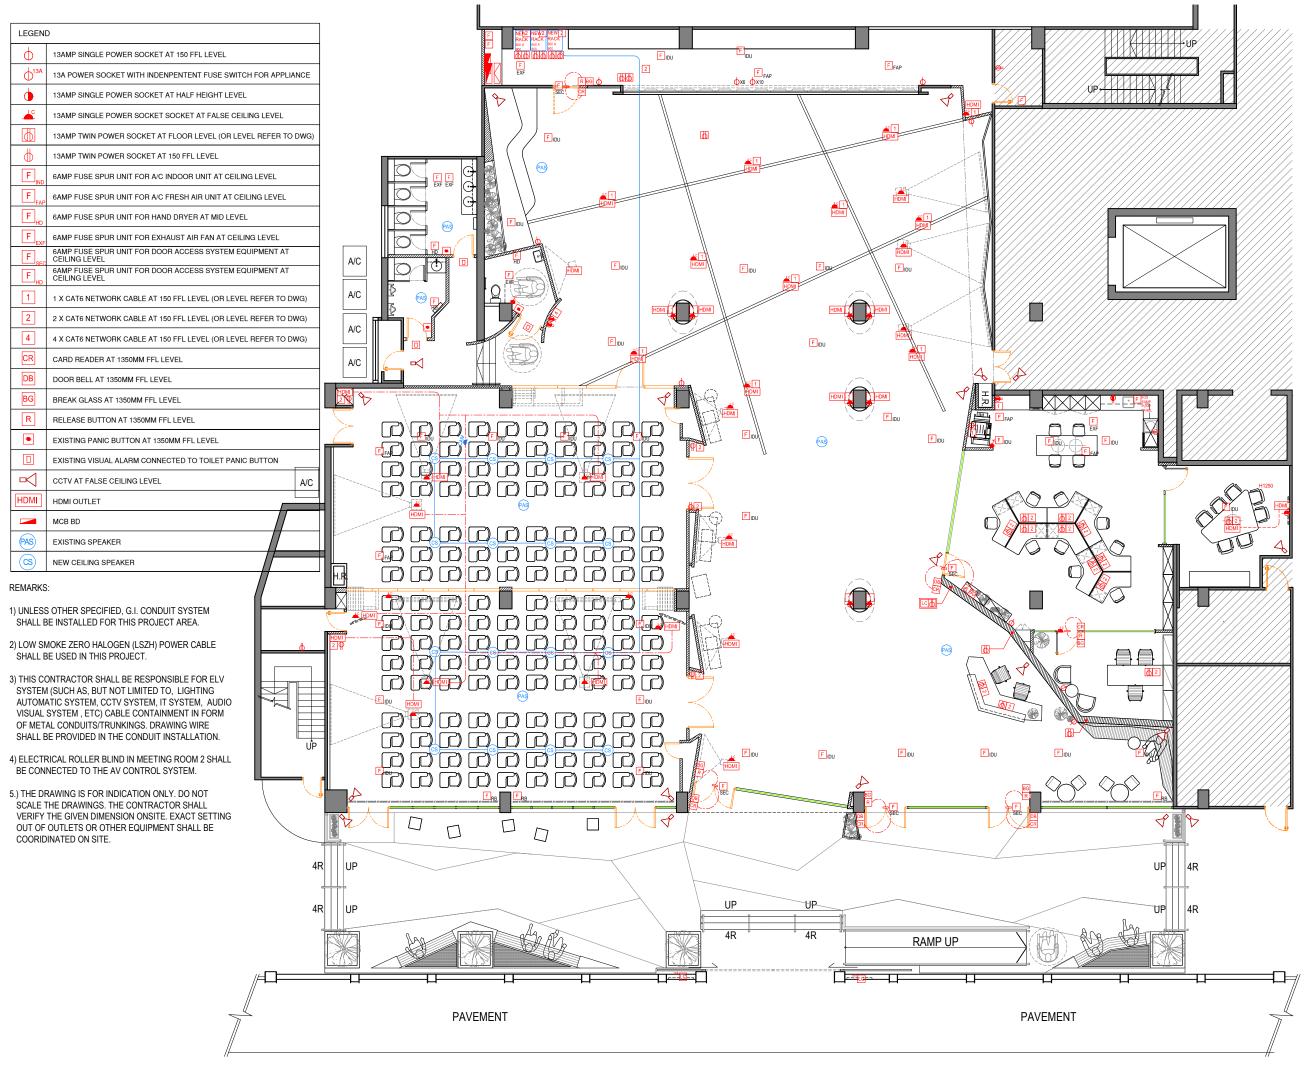



REVISIO	DN	
REV.	DESCRIPTION	DATE
$\overline{\bigcirc}$		
\bigcirc		
\bigcirc		
NOTES		

ALL DESIGN ARE THE PROPERTY OF AL DESIGN & ASSOCIATES LTD. AND CANNOT BE USED WITHOUT THEIR WRITTEN DEPAMESION.

ALL MEASUREMENT MUST BE VERIFIED ON SITE BEFORE CONSTRUCTION. CONTRACTOR SHALL NOTIFY THE DESIGNER OF ANY DISCREPANCY BEFORE STARTING WORK. AL DESIGN & ASSOCIATES LTD. WILL NOT RESPONSIBLE FOR ANY ERRORS SHOULD THE CONTRACTOR FAIL TO OBSERVE THIS PROCEDURE. THE CONTRACTOR SHALL BE RESPONSIBLE FOR ANY ERRORS RESULTINGS FROM FAILURE TO DO SO.

CLIENT

CIC Innovation Center (IC)

PROJECT

G/F, 44 Tai Yip Street Kowloon Bay, Hong Kong

DRAWING TITLE

ELECTRICAL PLAN

SCALE	DATE
1:150 (A3)	26 . 04 . 2017
DRAWN BY	DESIGNED BY
JH/ SC	AY


APPROVED

PROJECT NO DWG NO

APQ-17-0117 PL-03A

CAD FILE REF

APQ17-0117 Layout (current).dwg

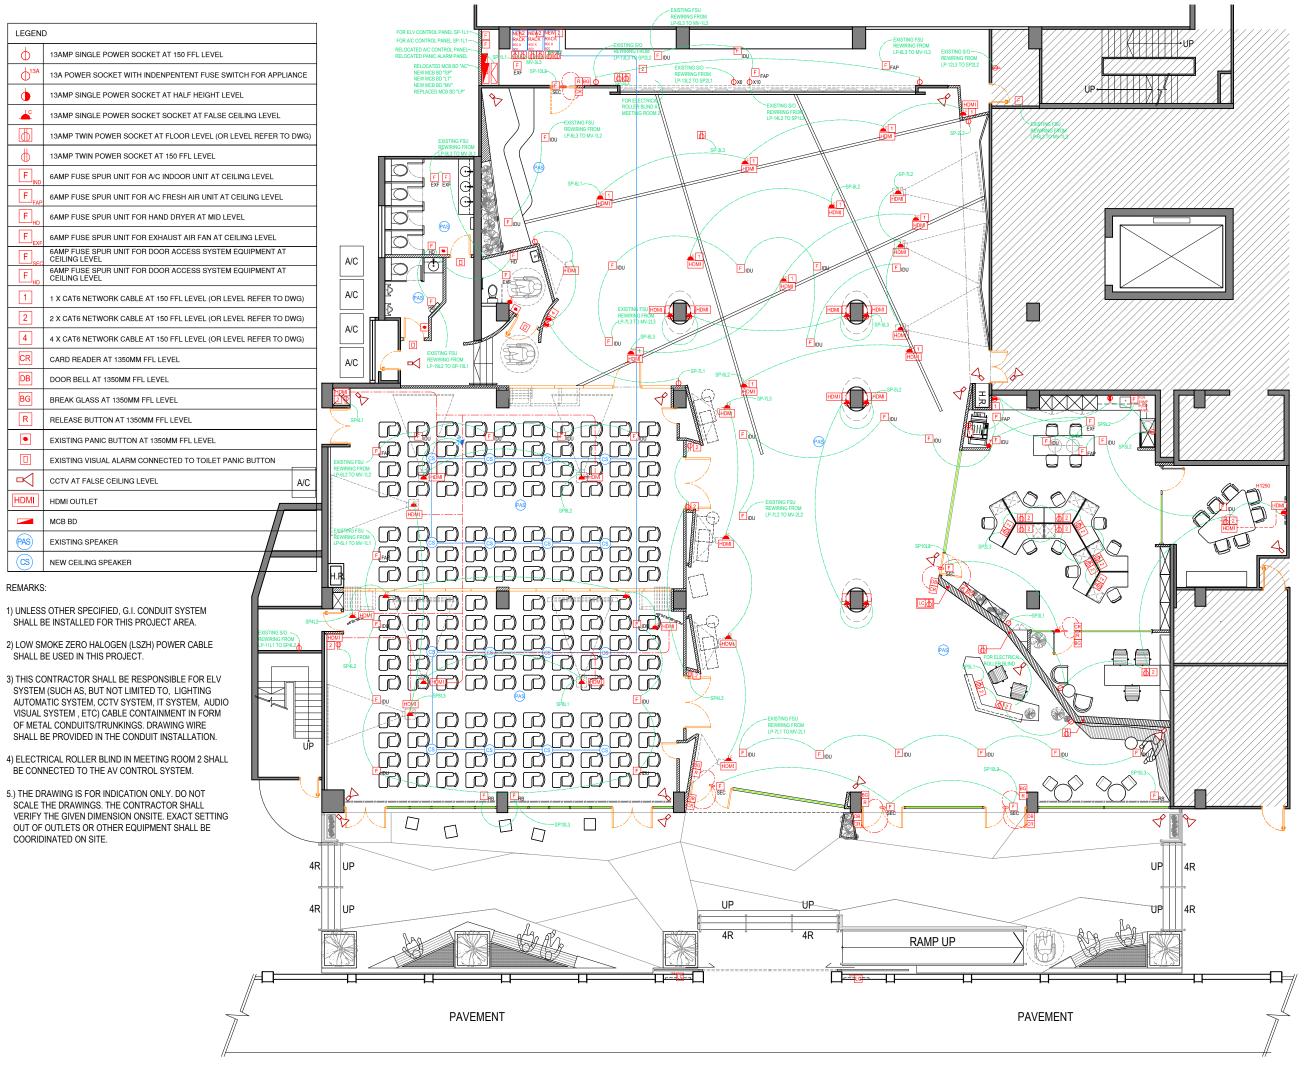



REVISION	ON	
REV.	DESCRIPTION	DATE
$\overline{\bigcirc}$		
$\overline{\bigcirc}$		
$\overline{\bigcirc}$		
\bigcirc		
$\overline{\bigcirc}$		
$\overline{\bigcirc}$		
$\widetilde{\bigcirc}$		
$\overline{\bigcirc}$		
$\overline{\bigcirc}$		
$\widetilde{\bigcirc}$		
$\underline{\hspace{1cm}}$		
NOTES		

ALL DESIGN ARE THE PROPERTY OF AL DESIGN & ASSOCIATES LTD. AND CANNOT BE USED WITHOUT THEIR WRITTEN DEPAMESION.

ALL MEASUREMENT MUST BE VERIFIED ON SITE BEFORE CONSTRUCTION. CONTRACTOR SHALL NOTIFY THE DESIGNER OF ANY DISCREPANCY BEFORE STARTING WORK. AL DESIGN & ASSOCIATES LTD. WILL NOT RESPONSIBLE FOR ANY ERRORS SHOULD THE CONTRACTOR FAIL TO OBSERVE THIS PROCEDURE. THE CONTRACTOR SHALL BE RESPONSIBLE FOR ANY ERRORS RESULTINGS FROM FAILURE TO DO SO.

CLIENT

CIC Innovation Center (IC)

PROJECT

G/F, 44 Tai Yip Street Kowloon Bay, Hong Kong

DRAWING TITLE

ELECTRICAL CIRCUIT PLAN

SCALE	DATE
1:150 (A3)	26 . 04 . 2017
DRAWN BY	DESIGNED BY
JH/ SC	AY


APPROVED B

DATE
PROJECT NO DWG NO

APQ-17-0117 PL-03B

CAD FILE REF

APQ17-0117 Layout (current).dwg

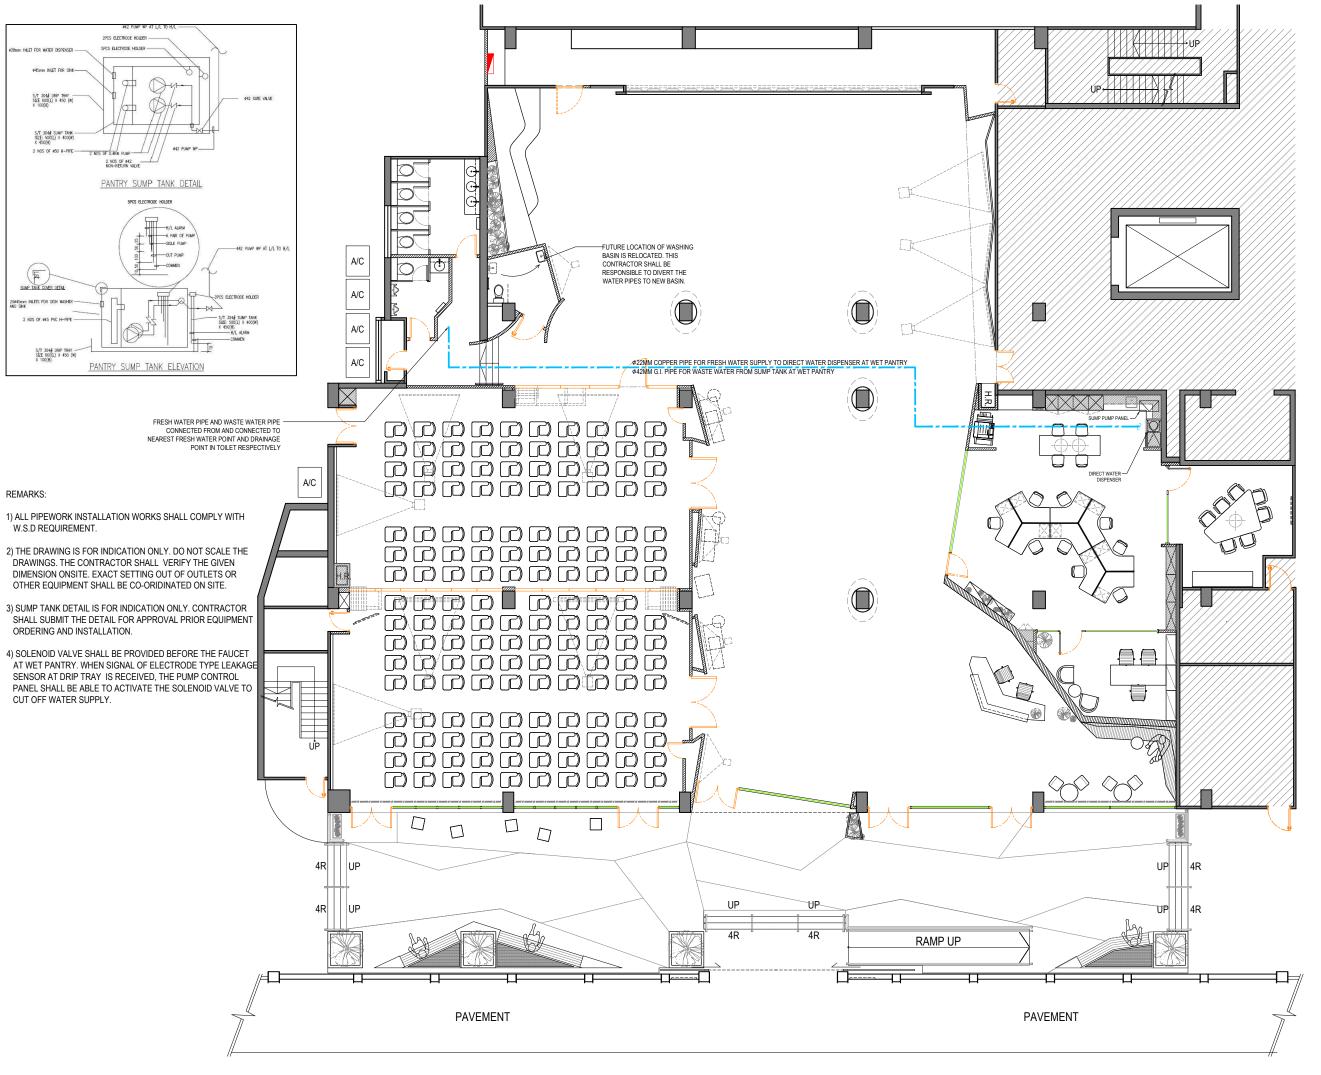



REVISIO	ON	
REV.	DESCRIPTION	DATE
\bigcirc		
$\overline{\bigcirc}$		
\bigcirc		
NOTES		

ALL DESIGN ARE THE PROPERTY OF AL DESIGN & ASSOCIATES LTD. AND CANNOT BE USED WITHOUT THEIR WRITTEN

ALL MEASUREMENT MUST BE VERIFIED ON SITE BEFORE CONSTRUCTION. CONTRACTOR SHALL NOTIFY THE DESIGNER OF ANY DISCREPANCY BEFORE STARTING WORK. AL DESIGN & ASSOCIATES LTD. WILL NOT RESPONSIBLE FOR ANY ERRORS SHOULD THE CONTRACTOR FAIL TO OBSERVE THIS PROCEDURE. THE CONTRACTOR SHALL BE RESPONSIBLE FOR ANY ERRORS RESULTINGS FROM FAILURE TO DO SO.

CLIENT

CIC Innovation Center (IC)

PROJECT

G/F, 44 Tai Yip Street Kowloon Bay, Hong Kong


DRAWING TITLE

P&D PLAN

SCALE	DATE
4 450 (40)	
1 : 150 (A3)	26 . 04 . 2017
DRAWN BY	DESIGNED BY
JH/ SC	AY

PROJECT NO PL-04 APQ-17-0117

APQ17-0117 Layout (current).dwg

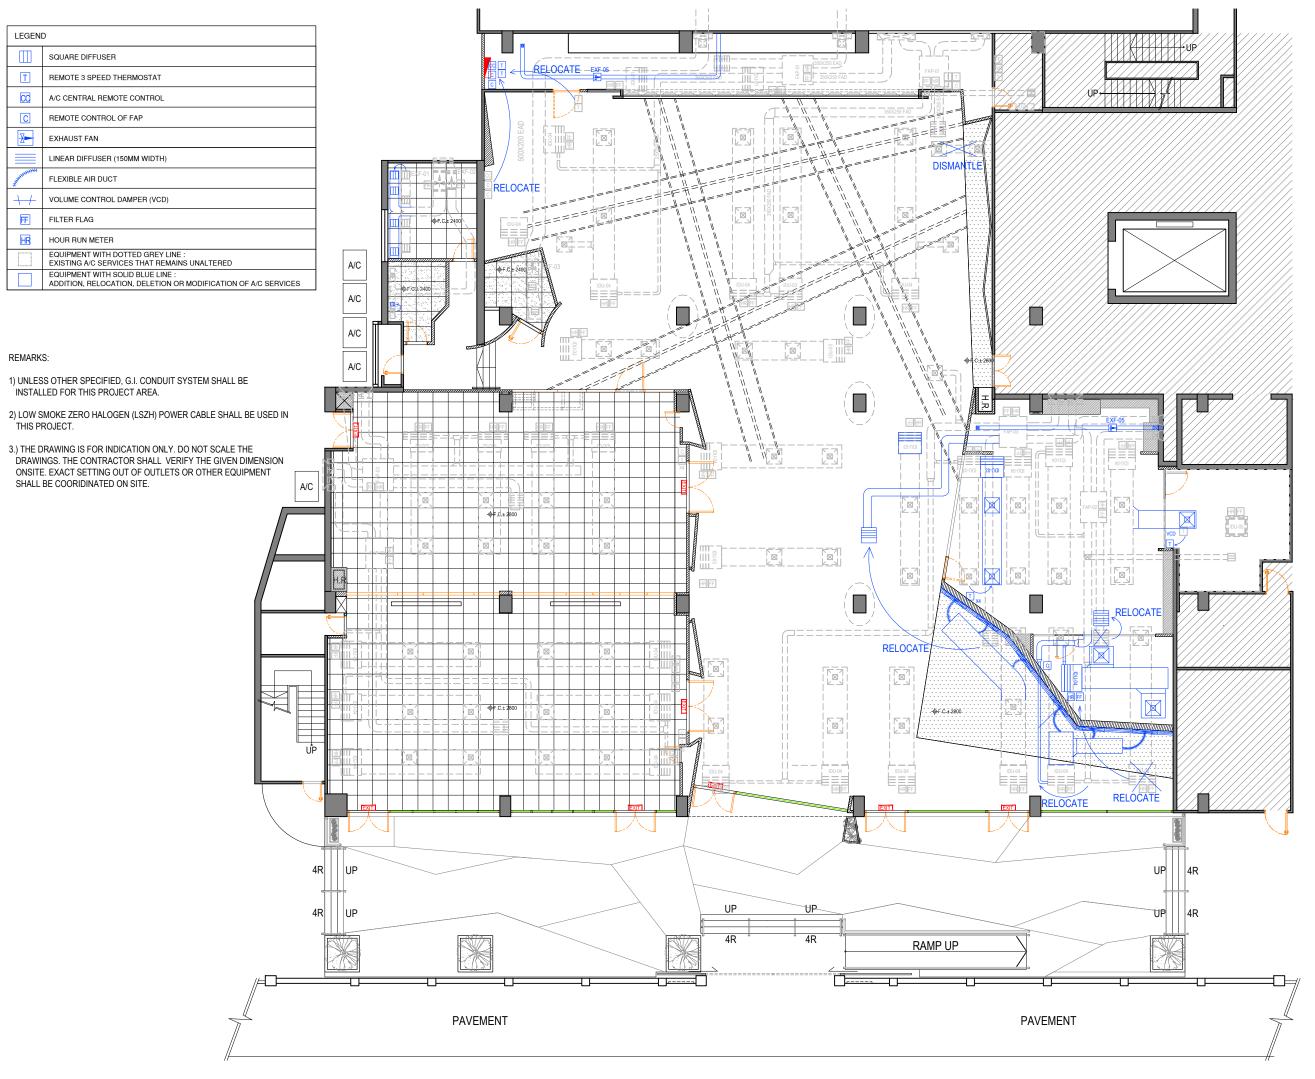



REVISION	ON	
REV.	DESCRIPTION	DATE
$\overline{\bigcirc}$		
$\overline{\bigcirc}$		
$\overline{\bigcirc}$		
\bigcirc		
NOTES		

ALL DESIGN ARE THE PROPERTY OF AL DESIGN & ASSOCIATES LTD. AND CANNOT BE USED WITHOUT THEIR WRITTEN PERMISSION.

ALL MEASUREMENT MUST BE VERIFIED ON SITE BEFORE CONSTRUCTION. CONTRACTOR SHALL NOTIFY THE DESIGNER OF ANY DISCREPANCY BEFORE STARTING WORK. AL DESIGN & ASSOCIATES LTD.
WILL NOT RESPONSIBLE FOR ANY ERRORS SHOULD THE CONTRACTOR FAIL TO OBSERVE THIS PROCEDURE. THE CONTRACTOR SHALL BE RESPONSIBLE FOR ANY ERRORS RESULTINGS FROM FAILURE TO DO SO.

CLIENT

CIC Innovation Center (IC)

PROJECT

G/F, 44 Tai Yip Street Kowloon Bay, Hong Kong

DRAWING TITLE


MVAC PLAN

SCALE DATE 1:150 (A3) 26.04.2017 DESIGNED BY JH/ SC ΑY

APPROVED BY

PROJECT NO PL-05 APQ-17-0117 CAD FILE REF

APQ17-0117 Layout (current).dwg

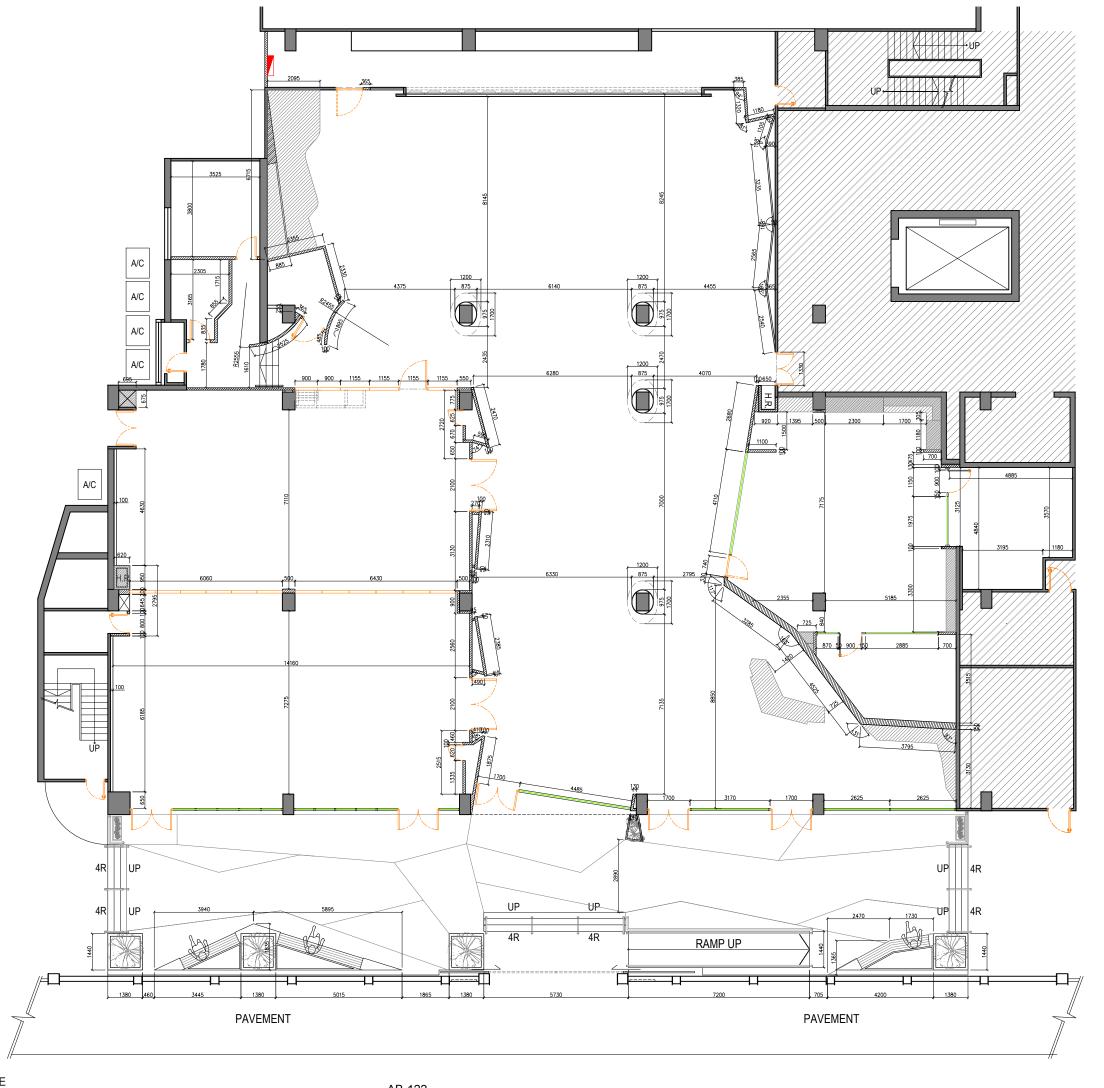



REVISION	NC	
REV.	DESCRIPTION	DATE
$\overline{\bigcirc}$		
\bigcirc		
\bigcirc		
NOTES		

ALL DESIGN ARE THE PROPERTY OF AL DESIGN & ASSOCIATES LTD. AND CANNOT BE USED WITHOUT THEIR WRITTEN PERMISSION.

ALL MEASUREMENT MUST BE VERIFIED ON SITE BEFORE CONSTRUCTION. CONTRACTOR SHALL NOTIFY THE DESIGNER OF ANY DISCREPANCY BEFORE STARTING WORK. AL DESIGN & ASSOCIATES LTD.
WILL NOT RESPONSIBLE FOR ANY ERRORS WILL NOT HESPONSIBLE FOR ANY ERHORS
SHOULD THE CONTRACTOR FAIL TO OBSERVE
THIS PROCEDURE. THE CONTRACTOR SHALL BE
RESPONSIBLE FOR ANY ERRORS RESULTINGS
FROM FAILURE TO DO SO.

CLIENT

CIC Innovation Center (IC)

PROJECT

G/F, 44 Tai Yip Street Kowloon Bay, Hong Kong

DRAWING TITLE


SETTING OUT PLAN

SCALE	D. T.
	DATE
1:150 (A3)	26 . 04 . 2017
DRAWN BY	DESIGNED BY
JH/ SC	AY

PROJECT NO PL-06

APQ-17-0117

CAD FILE REF APQ17-0117 Layout (current).dwg

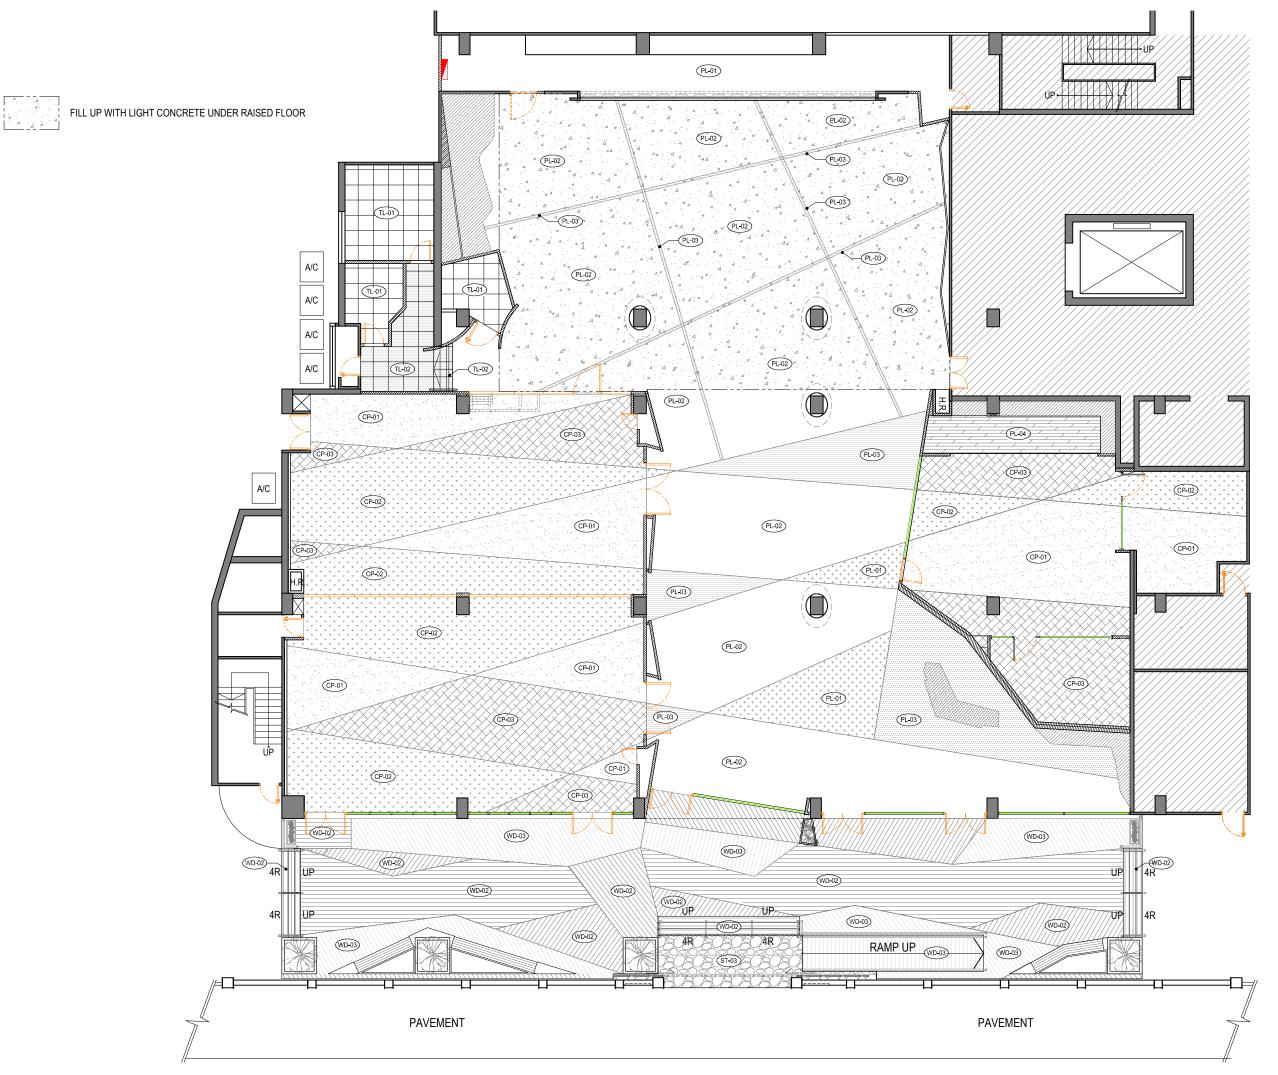



EV.	DESCRIPTION	DATE
$\overline{)}$		
\preceq		
\preceq		
\preccurlyeq		
\prec		
eq		
\geq		
<u>)</u>		
)		
)		
$\overline{)}$		
OTES		

ALL MEASUREMENT MUST BE VERIFIED ON

SITE BEFORE CONSTRUCTION. CONTRACTOR SHALL NOTIFY THE DESIGNER OF ANY DISCREPANCY BEFORE STARTING WORK. AL DESIGN & ASSOCIATES LTD.
WILL NOT RESPONSIBLE FOR ANY ERRORS WILL NOT RESPONSIBLE FOR ANY ERRORS
SHOULD THE CONTRACTOR FAIL TO OBSERVE
THIS PROCEDURE. THE CONTRACTOR SHALL BE
RESPONSIBLE FOR ANY ERRORS RESULTINGS
FROM FAILURE TO DO SO.

CLIENT

CIC Innovation Center (IC)

PROJECT

G/F, 44 Tai Yip Street Kowloon Bay, Hong Kong

DRAWING TITLE

FLOOR FINISH PLAN

SCALE	DATE
1:150 (A3)	26 . 04 . 2017
DRAWN BY	DESIGNED BY
JH/ SC	AY

PROJECT NO PL-07A APQ-17-0117

CAD FILE REF

APQ17-0117 Layout (current).dwg





REVISIO	N	
REV.	DESCRIPTION	DATE
$\overline{\bigcirc}$		
$\overline{\bigcirc}$		
\bigcirc		
NOTES		

ALL DESIGN ARE THE PROPERTY OF AL DESIGN & ASSOCIATES LTD. AND CANNOT BE USED WITHOUT THEIR WRITTEN PERMISSION.

ALL MEASUREMENT MUST BE VERIFIED ON SITE BEFORE CONSTRUCTION. CONTRACTOR SHALL NOTIFY THE DESIGNER OF ANY DISCREPANCY BEFORE STARTING WORK. AL DESIGN & ASSOCIATES LTD.
WILL NOT RESPONSIBLE FOR ANY ERRORS SHOULD THE CONTRACTOR FAIL TO OBSERVE THIS PROCEDURE. THE CONTRACTOR SHALL BE RESPONSIBLE FOR ANY ERRORS SHOULD THE THE CONTRACTOR SHALL BE RESPONSIBLE FOR ANY ERRORS RESULTINGS FROM FAILURE TO DO SO.

CLIENT

CIC Innovation Center (IC)

PROJECT

G/F, 44 Tai Yip Street Kowloon Bay, Hong Kong

DRAWING TITLE

FLOOR FINISH SETTING OUT PLAN

SCALE	DATE
1:150 (A3)	26 . 04 . 2017
DRAWN BY	DESIGNED BY
JH/ SC	AY

7111107202

PROJECT NO DWG NO

APQ-17-0117 PL-07B

CAD FILE REF

APQ17-0117 Layout (current).dwg





ALL DESIGN ARE THE PROPERTY OF AL DESIGN & ASSOCIATES LTD. AND CANNOT BE USED WITHOUT THEIR WRITTEN PERMISSION.

ALL MEASUREMENT MUST BE VERIFIED ON SITE BEFORE CONSTRUCTION. CONTRACTOR SHALL NOTIFY THE DESIGNER OF ANY DISCREPANCY BEFORE STARTING WORK. AL DESIGN & ASSOCIATES LTD.
WILL NOT RESPONSIBLE FOR ANY ERRORS SHOULD THE CONTRACTOR FAIL TO OBSERVE THIS PROCEDURE. THE CONTRACTOR SHALL BE RESPONSIBLE FOR ANY ERRORS RESULTINGS FROM FAILURE TO DO SO.

CLIENT

CIC Innovation Center (IC)

PROJECT

G/F, 44 Tai Yip Street Kowloon Bay, Hong Kong


DRAWING TITLE

WALL FINISH PLAN

SCALE	DATE
1:150 (A3)	26 . 04 . 2017
DRAWN BY	DESIGNED BY
JH/ SC	AY

PROJECT NO PL-08 APQ-17-0117 CAD FILE REF

APQ17-0117 Layout (current).dwg

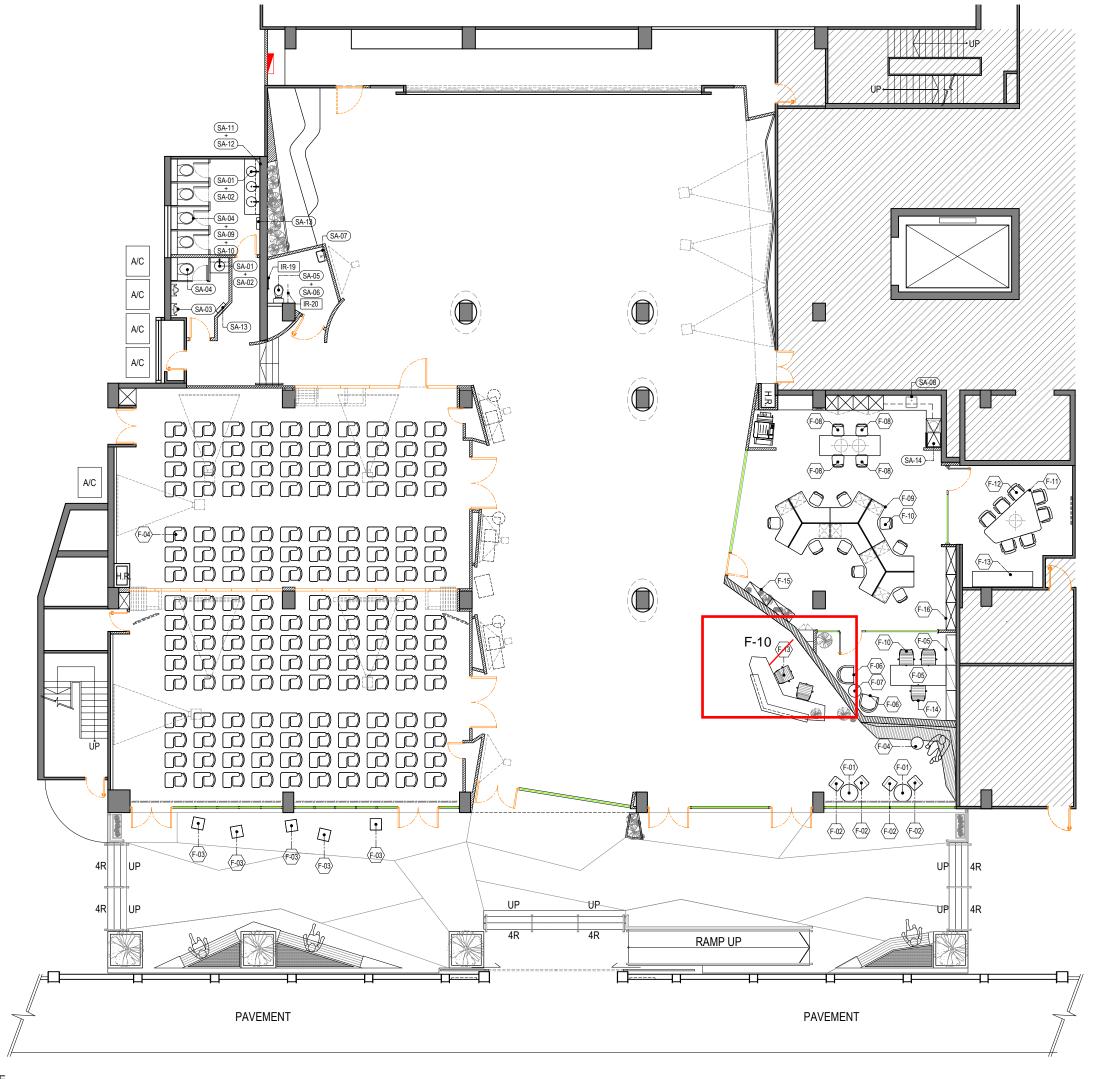



REVISI	ON	
REV.	DESCRIPTION	DATE
$\overline{\bigcirc}$		
$\overline{\bigcirc}$		
\bigcirc		
\bigcirc		
$\overline{\bigcirc}$		
NOTES		

ALL DESIGN ARE THE PROPERTY OF AL DESIGN & ASSOCIATES LTD. AND CANNOT BE USED WITHOUT THEIR WRITTEN DEPMISED ASSOCIATES ASSOCIATED ASSOCIATION OF THE PROPERTY OF THE PROPERTY

ALL MEASUREMENT MUST BE VERIFIED ON SITE BEFORE CONSTRUCTION. CONTRACTOR SHALL NOTIFY THE DESIGNER OF ANY DISCREPANCY BEFORE STARTING WORK.
AL DESIGN & ASSOCIATES LTD.
WILL NOT RESPONSIBLE FOR ANY ERRORS SHOULD THE CONTRACTOR FAIL TO OBSERVE THIS PROCEDURE. THE CONTRACTOR SHALL BE RESPONSIBLE FOR ANY ERRORS RESULTINGS FROM FAILLURE TO DO SO.

CLIENT

CIC Innovation Center (IC)

PROJE

G/F, 44 Tai Yip Street Kowloon Bay, Hong Kong

DRAWING TITLE

LOOSE FURNITURE PLAN

1:150 (A3) 26.04.2017 DRAWN BY DESIGNED BY		
DRAWN BY DESIGNED BY	SCALE	DATE
	1:150 (A3)	26 . 04 . 2017
111/00	DRAWN BY	DESIGNED BY
JH/ SC AY	JH/ SC	AY


APPROVED

PROJECT NO DWG NO

APQ-17-0117 PL-09

D FILE REF

APQ17-0117 Layout (current).dwg

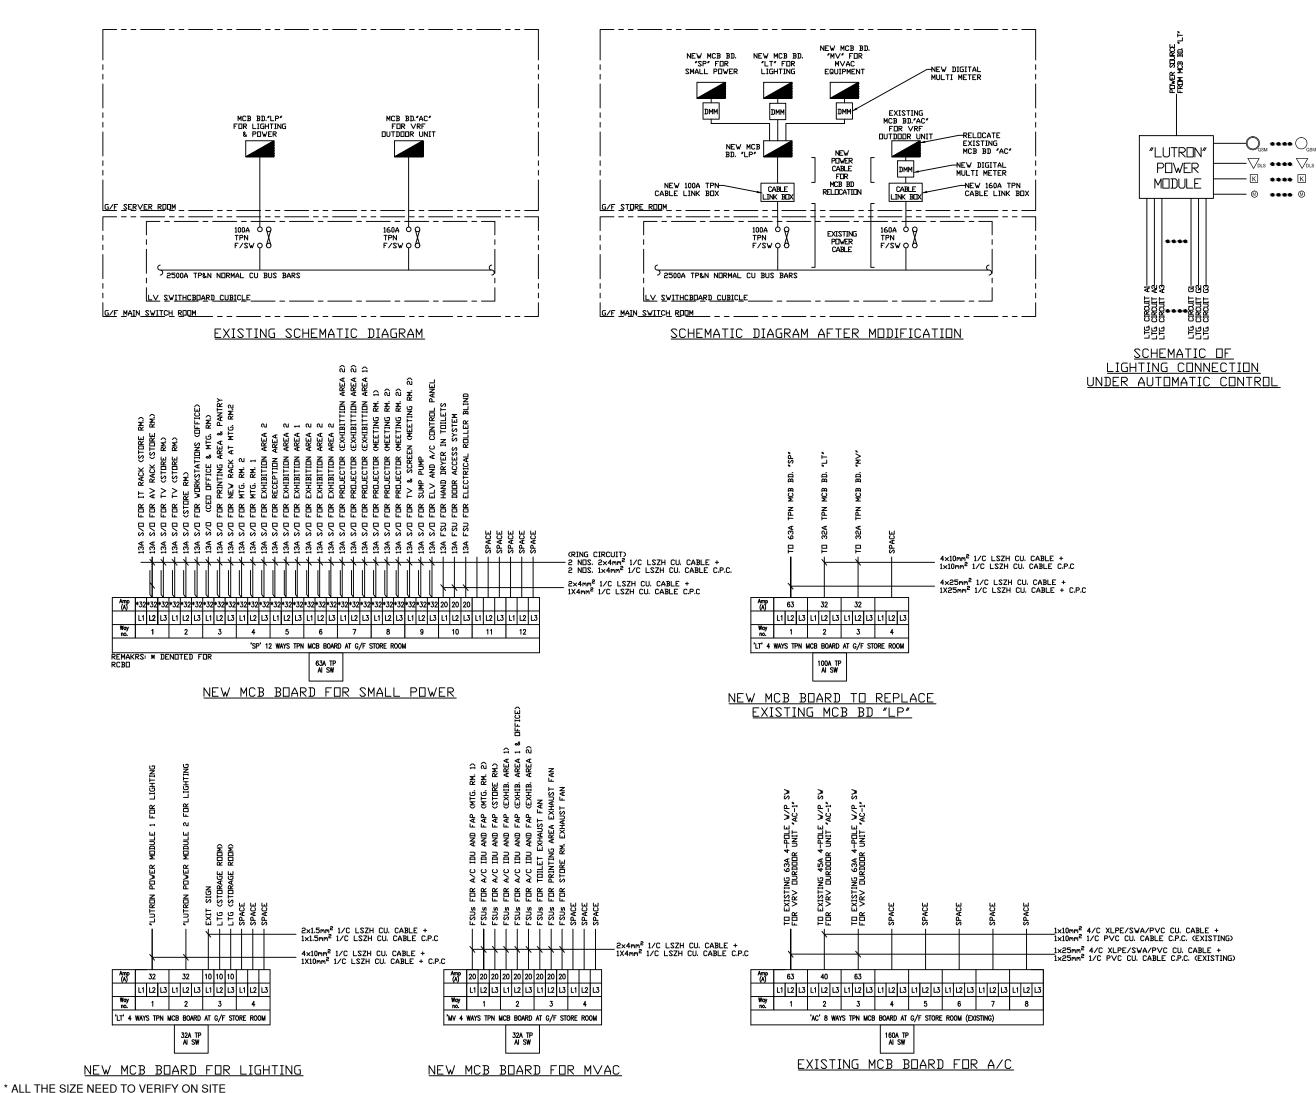

AL Design

REV.	DESCRIPTION	DATE
\bigcap		
$\widetilde{\supset}$		
\preceq		
\preccurlyeq		
\prec		
\prec		
\preceq		
\supseteq		
\bigcirc		
\bigcirc		
\bigcirc		
OTES		

ALL DESIGN ARE THE PROPERTY OF AL DESIGN & ASSOCIATES LTD. AND CANNOT BE USED WITHOUT THEIR WRITTEN PERMISSION.

ALL MEASUREMENT MUST BE VERIFIED ON SITE BEFORE CONSTRUCTION. CONTRACTOR SHALL NOTIFY THE DESIGNER OF ANY DISCREPANCY BEFORE STARTING WORK.
AL DESIGN & ASSOCIATES LTD.
WILL NOT RESPONSIBLE FOR ANY ERRORS SHOULD THE CONTRACTOR FAIL TO OBSERVE THIS PROCEDURE. THE CONTRACTOR SHALL BE RESPONSIBLE FOR ANY ERRORS RESULTINGS FROM FAILURE TO DO SO.

CLIENT

CIC Innovation Center (IC)

PROJECT

G/F, 44 Tai Yip Street Kowloon Bay, Hong Kong

DRAWING TITLE

SCHEMATIC DIAGRAM & MCB DETAILS

SCALE	DATE
-	26 . 04 . 2017
DRAWN BY	DESIGNED BY
JH/ SC	AY

DATE


PROJECT NO DWG N

APQ-17-0117


PL-10


CAD FILE REF

APQ17-0117 Layout (current).dwg

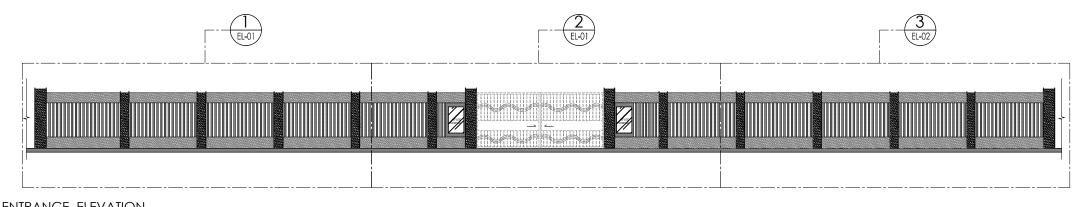

A ENTRANCE ELEVATION SCALE 1:75(A1), 1:150(A3)

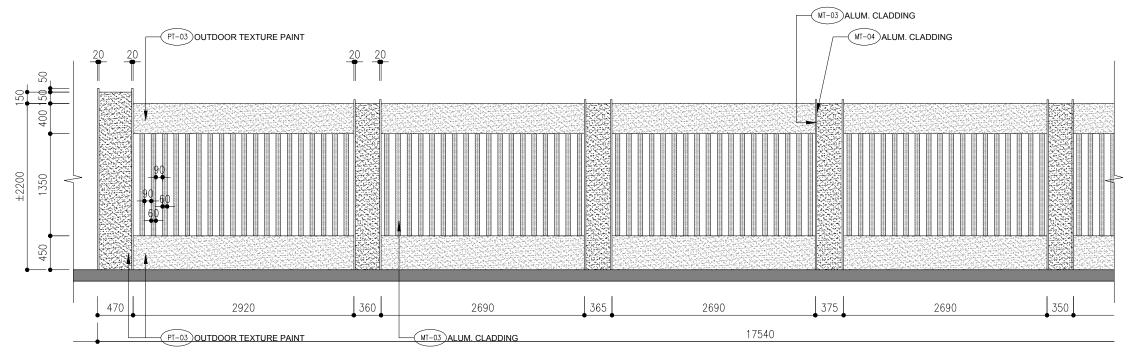


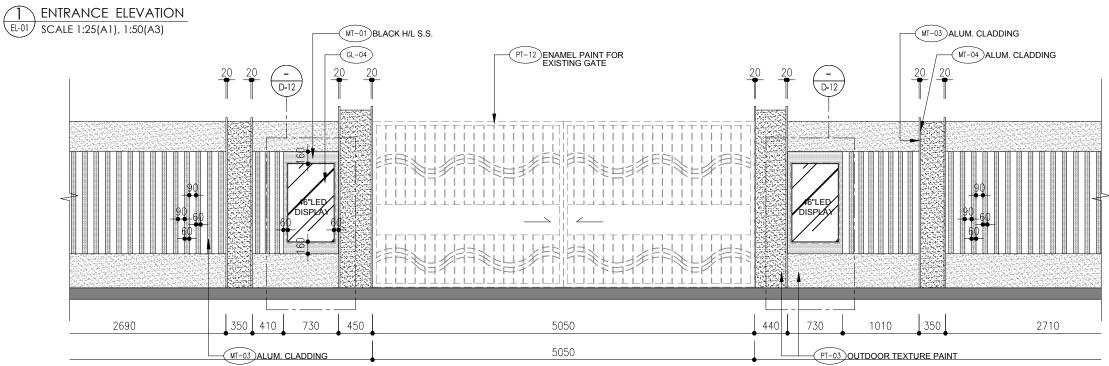


2 ENTRANCE ELEVATION SCALE 1:25(A1), 1:50(A3)

REV.	DESCRIPTION	DATE
$\overline{\bigcirc}$		
$\check{\cap}$		
$\widetilde{\frown}$		
$\widetilde{\prec}$		
\asymp		
\approx		
\cong		
\subseteq		
\supseteq		
\bigcirc		
\bigcirc		
NOTES		
AND CAPERMIS ALL MESITE BISHALL DISCREAL DES WILL NO	EASUREMENT MUST BE VE EFORE CONSTRUCTION. CO NOTIFY THE DESIGNER OF PANCY BEFORE STARTING IGN & ASSOCIATES LTD. DT RESPONSIBLE FOR ANY	RIFIED ON ONTRACTOR F ANY WORK.
AL DES AND CA PERMIS ALL ME SITE BI SHALL DISCRE AL DES WILL NO SHOUL THIS PE RESPO FROM	INNOT BE USED WITHOUT I ISION. CASUREMENT MUST BE VE EFORE CONSTRUCTION. OF NOTIFY THE DESIGNER OI IPANCY BEFORE STARTING IGN & ASSOCIATES LTD.	RIFIED ON ONTRACTOR F ANY S WORK. FERRORS TO OBSERVE TOR SHALL BE
AL DES AND CA PERMIS ALL ME SHALL DISCRE AL DES WILL NO SHOUL THIS PE RESPO FROM CLIENT	INNOT BE USED WITHOUT I SION. EASUREMENT MUST BE VE EFORE CONSTRUCTION. O: MOTIFY THE DESIGNER OI PANCY BEFORE STARTING IGN & ASSOCIATES LTD. DT RESPONSIBLE FOR ANY DESIGNED OF THE CONTRACTOR FAIL ROCEDURE. THE CONTRACT	RIFIED ON ONTRACTOR F ANY & WORK. F ERRORS TO OBSERVE TOR SHALL BE RESULTINGS
AL DES AND CA PERMIS ALL ME SHALL DISCRE AL DES WILL NO SHOUL THIS PE RESPO FROM CLIENT	INNOT BE USED WITHOUT INSION. GASUREMENT MUST BE VERFORE CONSTRUCTION. CONTIFY THE DESIGNER OF PRANCY BEFORE STARTING IGN & ASSOCIATES LTD. DIT RESPONSIBLE FOR ANY DITHE CONTRACTOR FAIL ACCEDURE. THE CONTRACT SPAILURE TO DO SO. INDICATE TO DO SO. INDOVATION CENTER (RIFIED ON ONTRACTOR F ANY & WORK. F ERRORS TO OBSERVE TOR SHALL BE RESULTINGS
AL DES AND CA PERMIS ALL ME BISHALL DISCRES AL DES WILL NO FROM COLIENT CIC CIC G/F,	INNOT BE USED WITHOUT INSION. GASUREMENT MUST BE VERFORE CONSTRUCTION. CONTIFY THE DESIGNER OF PRANCY BEFORE STARTING IGN & ASSOCIATES LTD. DIT RESPONSIBLE FOR ANY DITHE CONTRACTOR FAIL ACCEDURE. THE CONTRACT SPAILURE TO DO SO. INDICATE TO DO SO. INDOVATION CENTER (RIFIED ON ONTRACTOR F ANY S WORK. FERRORS TO OBSERVE TOR SHALL BE RESULTINGS
AL DES AL DES AND CA AN	INNOT BE USED WITHOUT INSION. EASUREMENT MUST BE VE EFORE CONSTRUCTION. CO NOTIFY THE DESIGNER OF PANCY BEFORE STARTING IGN & ASSOCIATES LTD. DIT RESPONSIBLE FOR ANY DITHE CONTRACTOR FAIL ROCEDURE. THE CONTRACT NSIBLE FOR ANY ERRORS FAILURE TO DO SO. Innovation Center (RIFIED ON ONTRACTOR F ANY S WORK. FERRORS TO OBSERVE TOR SHALL BE RESULTINGS
AL DES MAND CA	LINNOT BE USED WITHOUT IN SISION. GRAUPREMENT MUST BE VERFORE CONSTRUCTION. CONTINUT THE DESIGNER OF PRINCE STARTING IN A ASSOCIATES LTD. DOT RESPONSIBLE FOR ANY DOTHER CONTRACTOR FAIL ROCEDURE. THE CONTRACT STALLURE TO DO SO. AND THE CONTRACTOR FAIL ROCEDURE. THE CONTRACT SALLURE TO DO SO. Innovation Center (1) THE CONTRACT SALLURE TO DO SO. CONTRACT SALLURE TO SALLURE TO DO SO. CONTRACT SALLURE TO SALLURE TO SALLURE TO DO SO. CONTRACT SALLURE TO	RIFIED ON ONTRACTOR F ANY S WORK. FERRORS TO OBSERVE TOR SHALL BE RESULTINGS
AL DES MAND CA	LINNOT BE USED WITHOUT TO SISION. GASUREMENT MUST BE VE EFFORE CONSTRUCTION. CO NOTIFY THE DESIGNER OF PARKEY BEFORE STARTING IGN & ASSOCIATES LTD. DOT RESPONSIBLE FOR ANY DOTHE CONTRACTOR FAIL ACCEDURE. THE CONTRACT SPAILURE TO DO SO. Innovation Center (THE CAST OF THE CONTRACT O	RIFIED ON ONTRACTOR F ANY S WORK. FERRORS TO OBSERVE FOR SHALL BE RESULTINGS (IC)
AL DES AND CARAMAN CAR	LINNOT BE USED WITHOUT INSION. CASUREMENT MUST BE VERY BEFORE CONSTRUCTION. CONTINUE THE DESIGNER OF THE DESIGNER OF THE CONTRACT OF FAIL TO THE SPONSIBLE FOR ANY DITHE CONTRACTOR FAIL TO DO SO. INDIVIDUAL THE CONTRACT OF THE CONTRACT O	RIFIED ON ONTRACTOR F ANY S WORK. Y ERRORS TO OBSERVE TOR SHALL BE RESULTINGS (IC)
AL DES MAND CA	LINNOT BE USED WITHOUT TO SISION. CASUREMENT MUST BE VEFORE CONSTRUCTION. CO NOTIFY THE DESIGNER OF PARKY BEFORE STARTING IGN & ASSOCIATES LTD. DOT RESPONSIBLE FOR ANY DITHE CONTRACTOR FAIL ROCEDURE. THE CONTRACT SPAILURE TO DO SO. AND THE YOUNG THE CONTRACT OF THE C	RIFIED ON ONTRACTOR F ANY E AN
AL DES AND CA AND CA AND CA AND CA AND CA AND CA ALL ME BITE BI SHALL LIFE BI SHALL LIFE BI SHOUL FHIS PROJECT CIC CIC CIC CIC CIC CIC CIC CIC CIC C	LINNOT BE USED WITHOUT INSION. CASUREMENT MUST BE VERY BEFORE CONSTRUCTION. CONSTRUCTION. CONSTRUCT THE DESIGNER OF PARTY BEFORE STARTING IGN & ASSOCIATES LTD. DOT RESPONSIBLE FOR ANY DITHE CONTRACTOR FAIL ROCEDURE. THE CONTRACT SAILURE TO DO SO. INNOVATION CENTER TO DO SO. INTO BEFORE ANY ERRORS FAILURE TO DO SO. INTO BEFORE THE START	RIFIED ON ONTRACTOR F ANY E AN
AL DES AND CARAMAN CAR	LINNOT BE USED WITHOUT INSION. CASUREMENT MUST BE VERY BEFORE CONSTRUCTION. CONSTRUCTION. CONSTRUCT THE DESIGNER OF PARTY BEFORE STARTING IGN & ASSOCIATES LTD. DOT RESPONSIBLE FOR ANY DITHE CONTRACTOR FAIL ROCEDURE. THE CONTRACT SAILURE TO DO SO. INNOVATION CENTER TO DO SO. INTO BEFORE ANY ERRORS FAILURE TO DO SO. INTO BEFORE THE START	RIFIED ON ONTRACTOR F ANY E AN
AL DES AND CARAMAN CAR	LINNOT BE USED WITHOUT TO SION. ASSION. ASSION. EASUREMENT MUST BE VE EFFORE CONSTRUCTION, CONTIFY THE DESIGNER OF PANCY BEFORE STARTING IGN & ASSOCIATES LTD. DIT RESPONSIBLE FOR ANY DIT THE CONTRACT OF FAIL CONTRACT OF FAIL CONTRACT OF FAIL CONTRACT OF THE CONTRACT	RIFIED ON ONTRACTOR F ANY S WORK. Y ERRORS TO OBSERVE TOR SHALL BE RESULTINGS (IC) 19 19 19 19 10 11 11 11 11 11 11 11 11 11 11 11 11
AL DES AND CASAND CASAN	LINNOT BE USED WITHOUT TO SION. ASSION. ASSION. EASUREMENT MUST BE VE EFFORE CONSTRUCTION, CONTIFY THE DESIGNER OF PANCY BEFORE STARTING IGN & ASSOCIATES LTD. DIT RESPONSIBLE FOR ANY DIT THE CONTRACT OF FAIL CONTRACT OF FAIL CONTRACT OF FAIL CONTRACT OF THE CONTRACT	RIFIED ON ONTRACTOR F ANY S WORK. Y ERRORS TO OBSERVE TOR SHALL BE RESULTINGS (IC) 19 19 19 19 10 11 11 11 11 11 11 11 11 11 11 11 11

AL Design

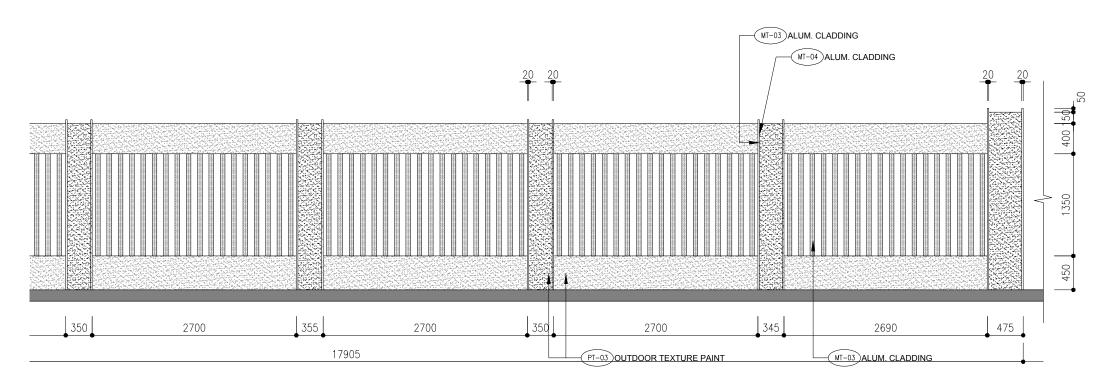

3 ENTRANCE ELEVATION SCALE 1:25(A1), 1:50(A3)

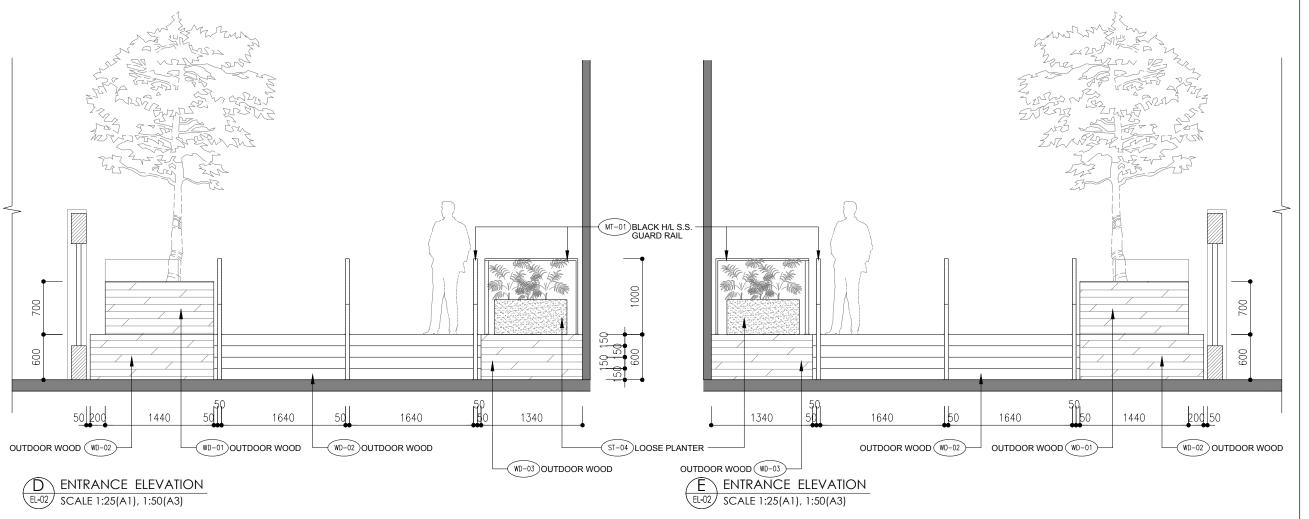

AL Design

AL Design
REVISION
REV. DESCRIPTION DATE
NOTES
ALL DESIGN ARE THE PROPERTY OF AL DESIGN & ASSOCIATES LTD. AND CANNOT BE USED WITHOUT THEIR WRITTEN PERMISSION.
ALL MEASUREMENT MUST BE VERIFIED ON SITE BEFORE CONSTRUCTION. CONTRACTOR SHALL NOTIFY THE DESIGNER OF ANY DISCREPANCY BEFORE STARTING WORK. AL DESIGN & ASSOCIATES LTD. WILL NOT RESPONSIBLE FOR ANY ERRORS SHOULD THE CONTRACTOR FAIL TO OBSERVE THIS PROCEDURE. THE CONTRACTOR SHALL BE RESPONSIBLE FOR ANY ERRORS RESULTINGS FROM FAILURE TO DO SO.
CIC Innovation Center (IC)

PROJECT

G/F, 44 Tai Yip Street Kowloon Bay, Hong Kong


DRAWING TITLE

ELEVATION -OUTDOOR AREA


SCALE	DATE	
AS SHOWN	26 . 04 . 2017	
DRAWN BY	DESIGNED BY	
JH/ SC	AY	

APPROVED BY

DATE		
PROJECT NO	DWG NO	
APQ-17-0117		EL-02
CAD FILE REF		
Elevation (current).d	wg	
TENDER DRAWING	3	

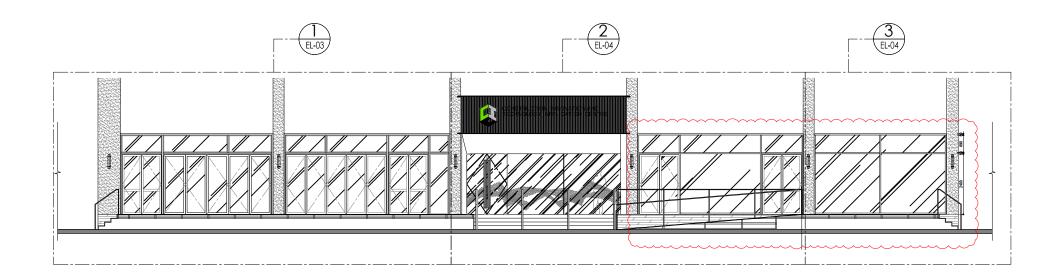

B ENTRANCE ELEVATION SCALE 1:75(A1), 1:150(A3)

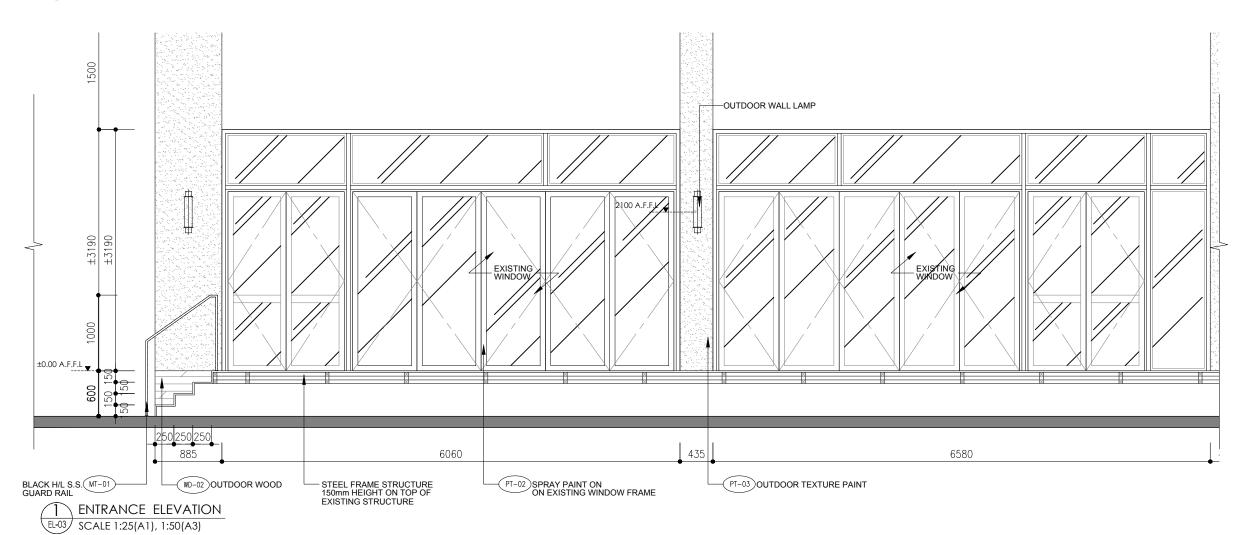



REV.	DESCRIPTION	DATE
$\overline{(A)}$	CLIENT COMMENT	11.05.2
$\check{\cap}$		
$\widetilde{\frown}$		
to		
\rightleftharpoons		
\subseteq		
\bigcirc		
\bigcirc		
\bigcirc		
$\overline{\bigcirc}$		
$\widetilde{\frown}$		
$\overline{}$		
NOTES		
ALL DE	SIGN ARE THE PROF	DERTY OF
WILL NO		
SHOULI THIS PF RESPO	OT RESPONSIBLE FOI OTHE CONTRACTOR ROCEDURE. THE CON NSIBLE FOR ANY ER FAILURE TO DO SO.	FAIL TO OBSERVE TRACTOR SHALL BE
SHOULI THIS PF RESPOI FROM I	THE CONTRACTOR ROCEDURE. THE CON NSIBLE FOR ANY ER	FAIL TO OBSERVE TRACTOR SHALL BE
SHOULI THIS PE RESPOI FROM I	THE CONTRACTOR ROCEDURE. THE CON NSIBLE FOR ANY ER	FAIL TO OBSERVE TRACTOR SHALL BE RORS RESULTINGS
SHOULI THIS PE RESPOI FROM I	DITHE CONTRACTOR IOCEDURE: THE CON ISIBLE FOR ANY ER FAILURE TO DO SO.	FAIL TO OBSERVE TRACTOR SHALL BE RORS RESULTINGS
SHOULI THIS PE RESPOI FROM I	DITHE CONTRACTOR IOCEDURE. THE CON NSIBLE FOR ANY ER FAILURE TO DO SO. INDIVIDUAL TO	FAIL TO OBSERVE TRACTOR SHALL BE RORS RESULTINGS ATTER (IC)
SHOULI THIS PE RESPOI FROM I	DITHE CONTRACTOR IOCEDURE: THE CON ISIBLE FOR ANY ER FAILURE TO DO SO.	FAIL TO OBSERVE TRACTOR SHALL BE RORS RESULTINGS atter (IC)
SHOULI THIS PE RESPOI FROM I	THE CONTRACTOR IOCEDURE. THE CON NSIBLE FOR ANY ER FAILURE TO DO SO. The control of the control	FAIL TO OBSERVE TRACTOR SHALL BE RORS RESULTINGS atter (IC)
SHOULI THIS PE RESPOI FROM I	nnovation Cer T 44 Tai Yip Stre pon Bay, Hong	FAIL TO OBSERVE TRACTOR SHALL BE RORS RESULTINGS atter (IC)
SHOULI THIS PERESPOI FROM I	THE CONTRACTOR OCEDURE: THE CON SIBLE FOR ANY ER FAILURE TO DO SO. TO THE CONTRACTOR THE CONTRA	FAIL TO OBSERVE TRACTOR SHALL BE RORS RESULTINGS atter (IC)
SHOULI THIS PER RESPOI FROM I	THE CONTRACTOR IOCEDURE. THE CON NSIBLE FOR ANY ER FAILURE TO DO SO. TO THE CONTRACTOR THE C	FAIL TO OBSERVE TRACTOR SHALL BE RORS RESULTINGS atter (IC)
SHOULI THIS PER RESPOI FROM I	THE CONTRACTOR OCEDURE: THE CON SIBLE FOR ANY ER FAILURE TO DO SO. TO THE CONTRACTOR THE CONTRA	FAIL TO OBSERVE TRACTOR SHALL BE RORS RESULTINGS atter (IC)
SHOULI THIS PER POINT RESPONDE FROM IT CLIENT CIC I I PROJECT CLIENT CIC I I PROJECT CIC I TO THE PROJECT CIC I TO	THE CONTRACTOR OCEDURE: THE CON SIBLE FOR ANY ER FAILURE TO DO SO. TO THE CONTRACTOR THE CONTRA	FAIL TO OBSERVE TRACTOR SHALL BE RORS RESULTINGS INTER (IC) Pet Kong
SHOULI THIS PER POINT RESPONDE FROM IT CLIENT CIC I I PROJECT CLIENT CIC I I PROJECT CIC I TO THE PROJECT CIC I TO	THE CONTRACTOR DOTHE CONTRACTOR DOCEDIE: THE CON NSIBLE FOR ANY ER ACALURE TO DO SO. INNOVATION CET T 44 Tai Yip Stree DON Bay, Hong GTITLE VATION DOOR AREA	FAIL TO OBSERVE TRACTOR SHALL BE RORS RESULTINGS INTER (IC) THE CONTROL OF THE
SHOULI THIS PROBE THE SPORT FROM IT THE SPORT FR	THE CONTRACTOR OCEDURE: THE CON SIBLE FOR ANY ER FAILURE TO DO SO. INNOVATION CET T 44 Tai Yip Stre DOON Bay, Hong G TITLE /ATION DOOR AREA HOWN	FAIL TO OBSERVE TRACTOR SHALL BE RORS RESULTINGS After (IC) DATE 26.04.2017
SHOULI THIS PERSON IN THIS PERSON IN THE PROJECT G/F, A KOWIG DRAWIN ELEV-OUT SCALE AS S DRAWN	THE CONTRACTOR DOTHE CONTRACTOR DOCEDURE. THE CON NSIBLE FOR ANY ER FAILURE TO DO SO. INNOVATION CET T 44 Tai Yip Stree DOOR Bay, Hong GITTLE VATION DOOR AREA HOWN BY SC	FAIL TO OBSERVE TRACTOR SHALL BE RORS RESULTINGS Atter (IC) DATE 26 . 04 . 2017 DESIGNED BY
SHOULI THIS PROJECT IN THE SPOINT FROM IT IN THE SPOINT FROM IT IN THE SPOINT FROM IT IN THE STATE IN THE STA	THE CONTRACTOR DOTHE CONTRACTOR DOCEDURE. THE CON NSIBLE FOR ANY ER FAILURE TO DO SO. INNOVATION CET T 44 Tai Yip Stree DOOR Bay, Hong GITTLE VATION DOOR AREA HOWN BY SC	FAIL TO OBSERVE TRACTOR SHALL BE RORS RESULTINGS Atter (IC) DATE 26 . 04 . 2017 DESIGNED BY
SHOULI THIS PROJECT IN THE SPOINT FROM IT IN THE SPOINT FROM IT IN THE SPOINT FROM IT IN THE STATE IN THE STA	THE CONTRACTOR DOTHE CONTRACTOR DOCEDURE. THE CON NSIBLE FOR ANY ER FAILURE TO DO SO. INNOVATION CET T 44 Tai Yip Stree DOOR Bay, Hong GITTLE VATION DOOR AREA HOWN BY SC	FAIL TO OBSERVE TRACTOR SHALL BE RORS RESULTINGS Atter (IC) DATE 26 . 04 . 2017 DESIGNED BY
SHOULI THIS POINT IN THIS POIN	THE CONTRACTOR OCEDURE: THE CON SIBLE FOR ANY ER FAILURE TO DO SO. INNOVATION CET T 44 Tai Yip Stree CON Bay, Hong G TITLE VATION DOOR AREA HOWN BY SC	FAIL TO OBSERVE TRACTOR SHALL BE RORS RESULTINGS Inter (IC) DATE 26.04.2017 DESIGNED BY AY
SHOULI THIS PE SHOULI THIS PE SHOULI THIS PE SHOULI FROM I CLIENT CIC I I CLIENT CLIENT CLIENT CLIENT CLIENT CLIENT CAS SALE AS SALE APPROVA APPROVA APPROVA DATE PROJECT	THE CONTRACTOR OCEDURE: THE CON SIBLE FOR ANY ER FAILURE TO DO SO. INNOVATION CET T 44 Tai Yip Stree CON Bay, Hong G TITLE VATION DOOR AREA HOWN BY SC	FAIL TO OBSERVE TRACTOR SHALL BE RORS RESULTINGS After (IC) DATE 26.04.2017 DESIGNED BY AY
SHOULI THIS PE SHOULI THIS PE SHOULI THIS PE SHOULI FROM I CLIENT CIC I I CLIENT CLIENT CLIENT CLIENT CLIENT CLIENT CAS SALE AS SALE APPROVA APPROVA APPROVA DATE PROJECT	THE CONTRACTOR OCEDURE: THE CON INCOME THE CON INCOME THE CON INCOME TO DO SO. INCOME TO DO SO. INCOME TO DO SO. INCOME THE CONTRACTOR INCOME THE CONTR	FAIL TO OBSERVE TRACTOR SHALL BE RORS RESULTINGS Inter (IC) DATE 26.04.2017 DESIGNED BY AY
SHOULI THIS PER RESPOIL FROM I CLIENT CLIC I CLIENT CLIENT PROJEC G/F, 4 KOWK COUNTY SCALE AS S DRAWN JH/ S APPROVE AS APPROVE APQ. CAD FILE	THE CONTRACTOR OCEDURE: THE CON INCOME THE CON INCOME THE CON INCOME TO DO SO. INCOME TO DO SO. INCOME TO DO SO. INCOME THE CONTRACTOR INCOME THE CONTR	FAIL TO OBSERVE TRACTOR SHALL BE RORS RESULTINGS Inter (IC) DATE 26.04.2017 DESIGNED BY AY DWG NO EL-03



DATE 11.05.2017

ALL DESIGN ARE THE PROPERTY OF AL DESIGN & ASSOCIATES LTD. AND CANNOT BE USED WITHOUT THEIR WRITTEN

ALL MEASUREMENT MUST BE VERIFIED ON SITE BEFORE CONSTRUCTION. CONTRACTOR SHALL NOTIFY THE DESIGNER OF ANY DISCREPANCY BEFORE STARTING WORK. AL DESIGN & ASSOCIATES LTD.
WILL NOT RESPONSIBLE FOR ANY ERRORS THIS PROCEDURE. THE CONTRACTOR SHALL BE RESPONSIBLE FOR ANY ERRORS RESULTINGS FROM FAILURE TO DO SO.


G/F, 44 Tai Yip Street Kowloon Bay, Hong Kong

ELEVATION -OUTDOOR AREA


DATE 26.04.2017 DESIGNED BY ΑY

EL-04 APQ-17-0117

Elevation (current).dwg

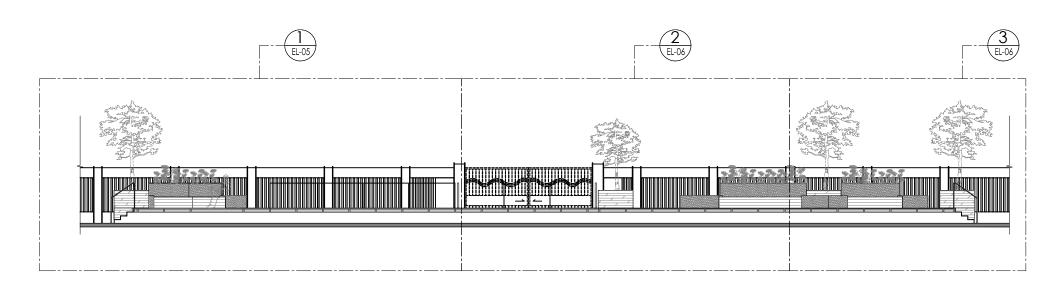


EL-05 ENTRANCE ELEVATION SCALE 1:75(A1), 1:150(A3)

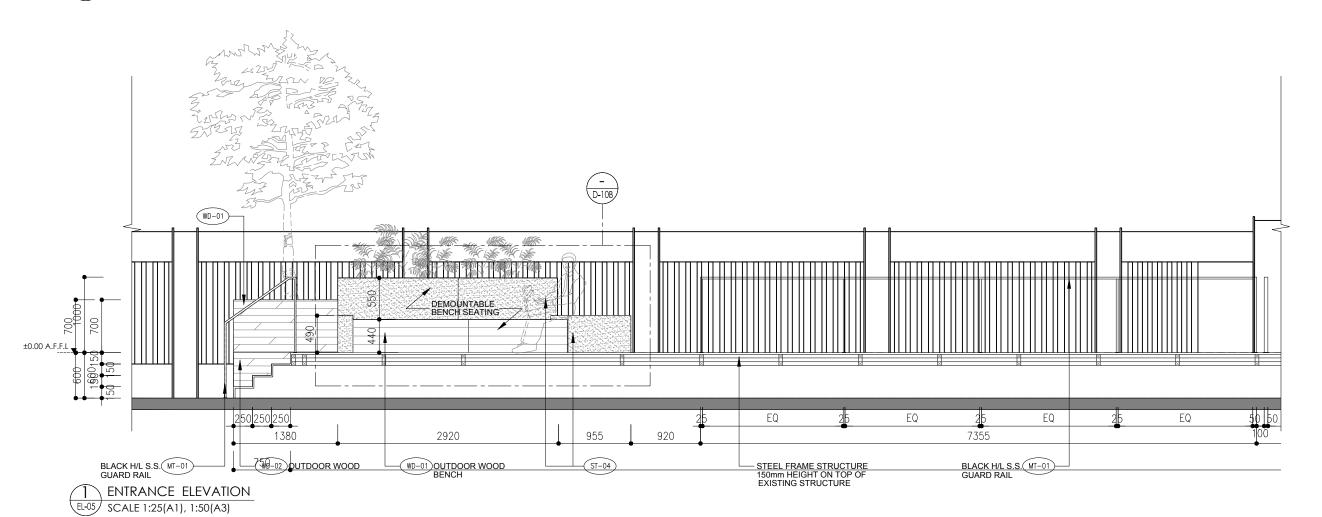




REVISION		
REV. DESCRIPTION	DA ⁻	ſΕ
\supseteq		
\bigcup		
\mathcal{L}		
\supset		
\bigcirc		
$\overline{\bigcirc}$		
$\overline{\bigcirc}$		
		_
\sum		_
$\widetilde{\gamma}$		_
<u> </u>		_
OTES		
		_
		_
		_
ERMISSION. LL MEASUREMENT MU	WITHOUT THEIR WRITTEN	
HIS PROCEDURE. THE	ES LTD. E FOR ANY ERRORS CTOR FAIL TO OBSERVE CONTRACTOR SHALL BE Y ERRORS RESULTINGS	
LIENT		_
CIC Innovation (Center (IC)	
ROJECT		_
6/F, 44 Tai Yip S Cowloon Bay, Ho		
RAWING TITLE		_
ELEVATION OUTDOOR ARI	EA	
CALE	DATE	_
AS SHOWN	26 . 04 . 2017	
RAWN BY	DESIGNED BY	_
JH/ SC	AY	
PPROVED BY		_
ATE		
ROJECT NO	DWG NO	
		_
APQ-17-0117	EL-0	5
APQ-17-0117		5
	EL-0	5

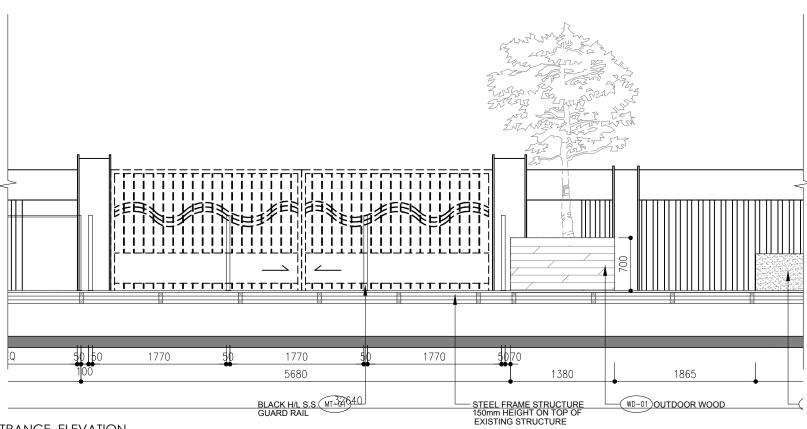

2 ENTRANCE ELEVATION SCALE 1:25(A1), 1:50(A3) ENTRANCE ELEVATION

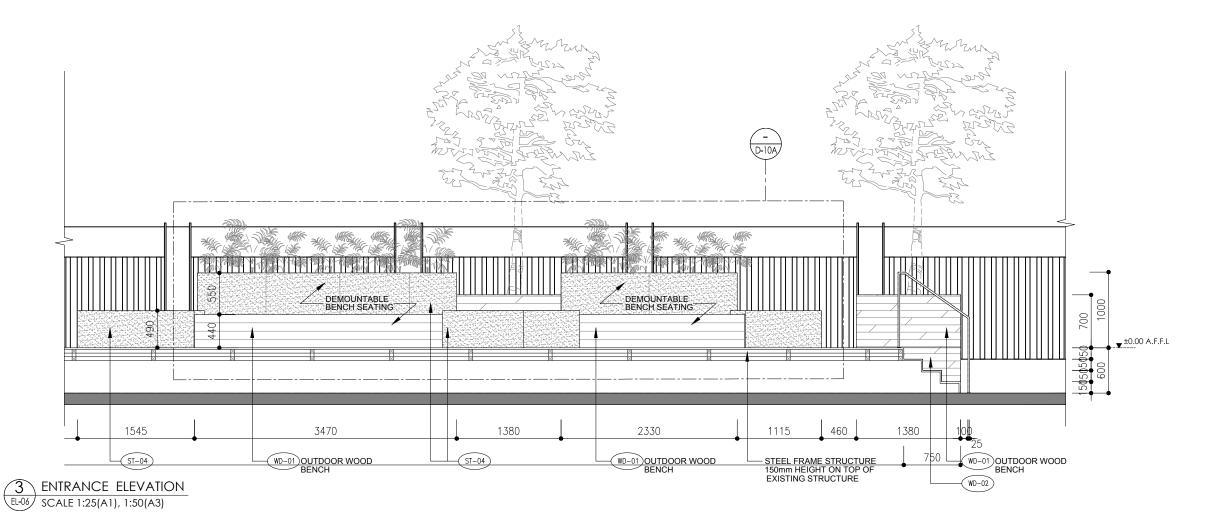

REV. DESCRIPTION	DATE
\bigcirc	
\bigcirc	
Ö	
Ö	
\bigcirc	
\bigcirc	
\bigcirc	
<u> </u>	
\bigcirc	
NOTES	
NOTES	
ALL DESIGN ARE THE PROPERTY	/ OF
AL DESIGN & ASSOCIATES LTD. AND CANNOT BE USED WITHOUT	
PERMISSION. ALL MEASUREMENT MUST BE VE	FRIEIED ON
SITE BEFORE CONSTRUCTION. C SHALL NOTIFY THE DESIGNER O	ONTRACTOR
DISCREPANCY BEFORE STARTING AL DESIGN & ASSOCIATES LTD.	
WILL NOT RESPONSIBLE FOR ANY SHOULD THE CONTRACTOR FAIL	
THIS PROCEDURE. THE CONTRAC	TOR SHALL BE
RESPONSIBLE FOR ANY ERRORS FROM FAILURE TO DO SO.	RESULTINGS
CLIENT	

G/F, 44 Tai Yip Street Kowloon Bay, Hong Kong


DRAWING TITLE


ELEVATION -OUTDOOR AREA

SCALE	DATE
AS SHOWN	26 . 04 . 2017
DRAWN BY	DESIGNED BY
JH/ SC	AY

PROJECT NO EL-06 APQ-17-0117 CAD FILE REF

Elevation (current).dwg

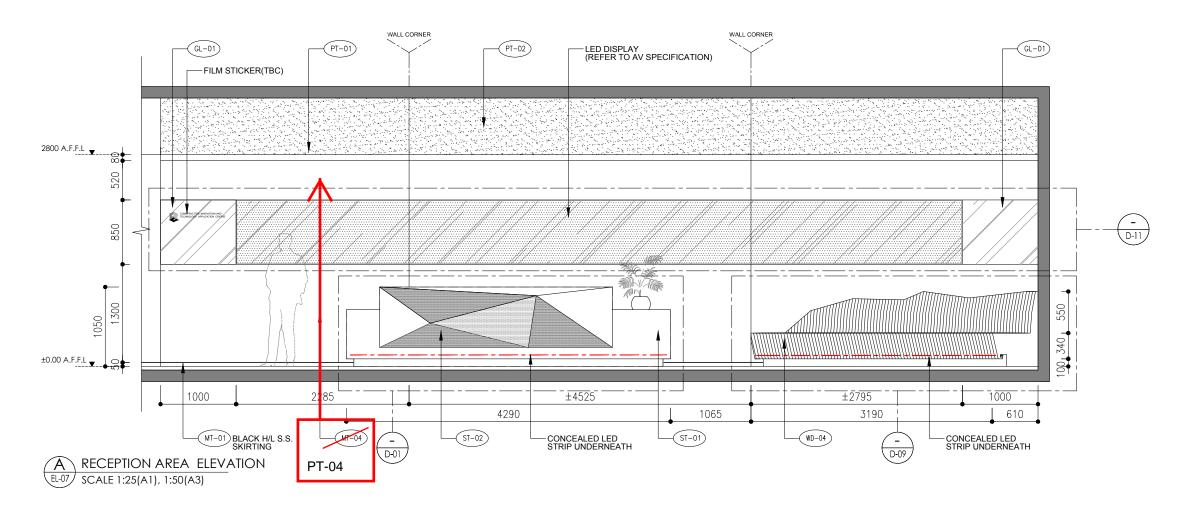


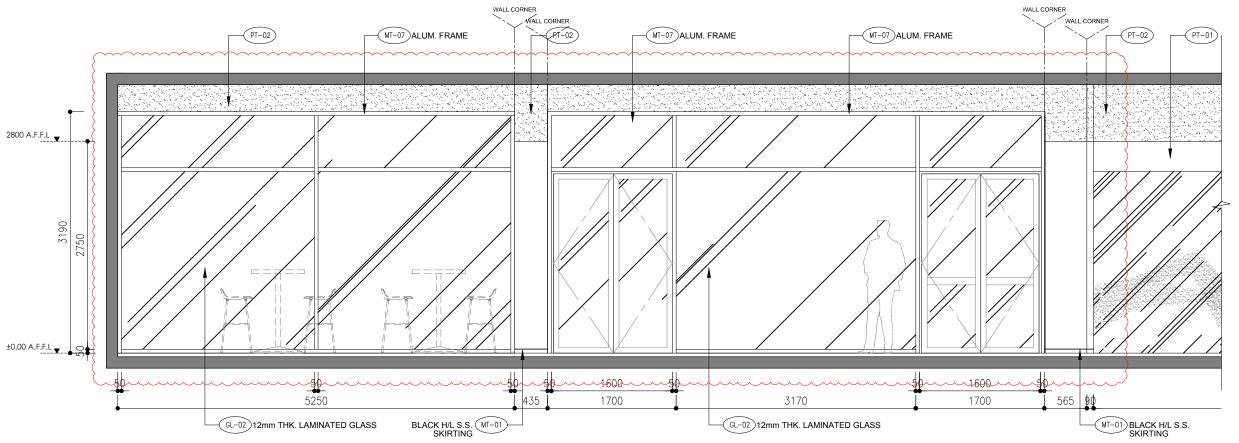


B RECEPTION AREA ELEVATION SCALE 1:25(A1), 1:50(A3)

AL Design

REV.	DESCRIPTION		DATE
(A)	CLIENT COMMENT		11.05.
$\widetilde{\frown}$			
$\widetilde{\frown}$			
\preceq			
\preceq			
top			
\approx			
$ \approx $			
to			
$ \approx $			
\bigcup			
NOTES			
PERMIS ALL ME SITE B SHALL DISCRE AL DES WILL NO	INNOT BE USED WITH ISION. CASUREMENT MUST EFORE CONSTRUCT NOTHEY THE DESIGN ASSOCIATES IN STREAM OF THE STREAM OF	BE VERIFIED FION. CONTRA INER OF ANY FARTING WOR LTD. DR ANY ERRO R FAIL TO OR	O ON ACTOR RK. DRS BSERVE
AND CAPERMIS ALL MESTE B SHALL DISCRE AL DES WILL NO SHOUL THIS PE	NNOT BE USED WITSION. ASUREMENT MUST FORE CONSTRUCT NOTIFY THE DESIG PANCY BEFORE ST IGN & ASSOCIATES I OT RESPONSIBLE FO	BE VERIFIED TION. CONTRA THER OF ANY TARTING WORE LTD. DR ANY ERRO R FAIL TO OF INTRACTOR S FRORS RESU	O ON ACTOR MK. DRS BSERVE HALL BE
AND CAPERMIS ALL MESTE B SHALL DISCRE AL DES WILL NO SHOUL THIS PE	INNOT BE USED WITH ISON. ASSUREMENT MUST FEFORE CONSTRUCT. NOTIFY THE DESIGNAMENT OF THE METERS OF	BE VERIFIED TION. CONTRA THER OF ANY TARTING WORE LTD. DR ANY ERRO R FAIL TO OF INTRACTOR S FRORS RESU	O ON ACTOR MK. DRS BSERVE HALL BE
AND CAPERMIS ALL ME SITE B SHALL DISCRE AL DES WILL NO SHOUL THIS PE RESPO FROM CLIENT	INNOT BE USED WITH ISON. ASSUREMENT MUST FEFORE CONSTRUCT. NOTIFY THE DESIGNAMENT OF THE METERS OF	BE VERIFIED TION, CONTRA NER OF ANY TARTING WOR TTO. OR ANY ERRO R FAIL TO OF NITRACTOR S FRRORS RESU O.	O ON ACTOR MK. DRS BSERVE HALL BE
AND CAPERMIS ALL MESTE B SHALL DISCREAL DESCREAL SHOULL NIS PRESPO FROM CLIENT	INNOT BE USED WITH SION. GASUREMENT MUST EFFORE CONSTRUCT NOTIFY THE DESIGNA ASSOCIATES I DIT RESPONSIBLE FOR THE CONTRACTO NOCEDURE. THE CONSIBLE FOR ANY EFAILURE TO DO SC	BE VERIFIED TION, CONTRA NER OF ANY TARTING WOR TTO. OR ANY ERRO R FAIL TO OF NITRACTOR S FRRORS RESU O.	O ON ACTOR MK. DRS BSERVE HALL BE
AND CAPERMISS ALL MESTE B SHALL DISCREE WILL N. SHOUL THIS PRESPO FROM CLIENT CIC	INNOT BE USED WITH SION. CASUREMENT MUST EFFORE CONSTRUCT NOTIFY THE DESIGNANCY BEFORE STORM ASSOCIATES I DT RESPONSIBLE FOR DITHE CONTRACTO ROCEDURE. THE CONSIBLE FOR ANY EFAILURE TO DO SCONTON CONTRACTOR OF THE CONTRACTOR OF	BE VERIFIED TION. CONTRA INDER OF ANY TARTING WOR TO. TO. TO. TO. TO. TO. TO. T	O ON ACTOR MK. DRS BSERVE HALL BE
AND C/PERMISS ALL ME SITE B SITE B SHALL DES WILL N SHOUL THIS P RESPO FROM CLIENT CIC PROJEC G/F,	INNOT BE USED WITH SION. GASUREMENT MUST EFFORE CONSTRUCT NOTIFY THE DESIGNA ASSOCIATES I DIT RESPONSIBLE FOR THE CONTRACTO NOCEDURE. THE CONSIBLE FOR ANY EFAILURE TO DO SC	BE VERIFIED TION. CONTRA INDER OF ANY TARTING WOR TO. TO. TO. TO. TO. TO. TO. T	O ON ACTOR MK. DRS BSERVE HALL BE
AND C/PERMISS ALL ME SITE B SITE B SHALL DES WILL N SHOUL THIS P RESPO FROM CLIENT CIC PROJEC G/F,	INNOT BE USED WITH SION. ASSOCIATION OF THE DESIGNA ASSOCIATES IN THE CONTRACTO OCCEDURE. THE CONSIBLE FOR ANY EVALUATE TO DO SCIENT OF THE CONTRACTO OCCEDURE. THE CONTRACTO OCCEDURE. THE CONTRACTO OCCEDURE THE CONTRACTO OCCEDURE. THE CONTRACTO OCCEDIRE THE CONTRACTO OCCEDIRE. THE CONTRACTORY OF	BE VERIFIED TION. CONTRA INDER OF ANY TARTING WOR TO. TO. TO. TO. TO. TO. TO. T	O ON ACTOR MK. DRS BSERVE HALL BE
AND CAPERMISS ALL ME SHALL DISCRET AL DESS WILL NI SHOUL THIS PE PROJEC G/F, KOWI DRAWIN ELE\	INNOT BE USED WITH SION. ASSOCIATION OF THE DESIGNA ASSOCIATES IN THE CONTRACTO OCCEDURE. THE CONSIBLE FOR ANY EVALUATE TO DO SCIENT OF THE CONTRACTO OCCEDURE. THE CONTRACTO OCCEDURE. THE CONTRACTO OCCEDURE THE CONTRACTO OCCEDURE. THE CONTRACTO OCCEDIRE THE CONTRACTO OCCEDIRE. THE CONTRACTORY OF	BE VERIFIED TION. CONTRA INNER OF ANY TARTING WOR TO. OR ANY ERROR INTRACTOR S ERRORS RESU O. Enter (IC) Teet	O ON ACTOR MK. DRS BSERVE HALL BE
AND CAPERMISS ALL ME SHALL DISCRET AL DESS WILL NI SHOUL THIS PE PROJEC G/F, KOWI DRAWIN ELE\	INNOT BE USED WITH SION. AGASUREMENT MUST EFFORE CONSTRUCT NOTIFY THE DESIGNA ASSOCIATES I DIT RESPONSIBLE FOR THE CONTRACTO INCEDURE. THE CONSIBLE FOR ANY EFAILURE TO DO SCIENT OF THE CONTRACTO OCCUR. THE CONTRACTOR OCCUR.	BE VERIFIED TION. CONTRA INNER OF ANY TARTING WOR TO. OR ANY ERROR INTRACTOR S ERRORS RESU O. Enter (IC) Teet	O ON ACTOR MK. DRS BSERVE HALL BE
AND CAPPERMISS ALL ME SITE B SHALL DISCRET AL DESS WILL N'S SHOUL THIS PE PROJECT G/F, KOWI DRAWIN ELEV -RECC	INNOT BE USED WITH SION. AGASUREMENT MUST EFFORE CONSTRUCT NOTIFY THE DESIGNA ASSOCIATES I DIT RESPONSIBLE FOR THE CONTRACTO INCEDURE. THE CONSIBLE FOR ANY EFAILURE TO DO SCIENT OF THE CONTRACTO OCCUR. THE CONTRACTOR OCCUR.	BE VERIFIED TION. CONTRA INDER OF ANY FARTING WOR T.TD. OR ANY ERRO R FAIL TO OF INTRACTOR S RRORS RESU Center (IC) THE TO THE TO THE TO THE	O ON ICTOR IK. DRS BSERVE HALL BE JLTINGS
AND CAPPERMISS ALL ME SITE B SHALL DISCRET AL DESS WILL N'S SHOUL THIS PE PROJECT G/F, KOWI DRAWIN ELEV -RECC	INNOT BE USED WITH INSTANCE AND THE PERSON. CASUREMENT MUST EFFORE CONSTRUCT NOTIFY THE DESIGN ASSOCIATED TO TRESPONSIBLE FOR THE CONTRACTO ROCEDURE. THE CONSIBLE FOR ANY EFAILURE TO DO SCORD TO THE STANCE TH	BE VERIFIED FION. CONTRA INDER OF ANY FARTING WOR LTD. OR ANY ERROR INTRACTOR S FRORS RESU Center (IC) Reet g Kong	O ON ICTOR JANUARY OF THE STREET OF T
AND CAPERMISS ALL ME SITE B SHALL DISCRE AL DES SITE B SHALL DISCRE SHALL DISCRE SHALL DISCRE SHALL DISCRE SHALL DISCRE SHALL SHOUL THIS PI RESPO FROM CLIENT CIC PROJEC G/F, KOWI DRAWIN ELEV -REC SCALE AS S	INNOT BE USED WITH SION. ASSUREMENT MUST EFFORE CONSTRUCT NOTIFY THE DESIGNA ASSOCIATES IN DIT RESPONSIBLE FOR THE CONSTRUCT OCCEDURE. THE CONSIBLE FOR ANY EFAILURE TO DO SCIENT OF THE CONSEDERATION OF THE CONSTRUCT OF THE CON	BE VERIFIED TION. CONTRA INDER OF ANY TARTING WOR TO TO TO TO TO TO TO TO TO	O ON ICTOR JANUARY OF THE STREET OF T
AND C/PERMISIAN AND CAPERMISIAN CAPERMISIAN AND CAPERMISIAN CAPERMISIAN CAPERMISIAN CAPERMISIA	INNOT BE USED WITH SION. ASSUREMENT MUST EFFORE CONSTRUCT NOTIFY THE DESIGNANCE STATE OF THE CONTRACTO NOTEDURE. THE CONSIBLE FOR ANY EFAILURE TO DO SCIENTIFY TO DO SCIENT STATE OF THE CONSIBLE FOR ANY EFAILURE TO DO SCIENT STATE OF THE CONSIBLE FOR ANY EFAILURE TO DO SCIENT STATE OF THE CONSIBLE FOR ANY EFAILURE TO DO SCIENT STATE OF THE CONSIDERATION OF THE CON	BE VERIFIED TION. CONTRA INDER OF ANY FARTING WOR T.T. OR ANY ERRO R FAIL TO OF INTRACTOR S RERORS RESU CITY C	O ON ICTOR JANUARY OF THE STREET OF T
AND CAPPERMISS ALL ME SHALL DISCRET AL DESS WILL NY SHOULD HE RESPO FROM CLIENT CIC PROJEC G/F, KOWI DRAWIN BLEV -REC SCALE AS S APPROV DATE	ANOTE USED WITSION. ASSON. ASSONEMENT MUST EFFORE CONSTRUCT NOTIFY THE DESIG PANCY BEFORE ST OT RESPONSIBLE FO D THE CONTRACTO NOCEDURE. THE CON SIBLE FOR ANY E FAILURE TO DO SC INNOVATION G TITLE //ATION BY BY BC //ED BY	BE VERIFIED TION. CONTRA INDER OF ANY TARTING WOR TO TO TO TO TO TO TO TO TO	O ON ICTOR JANUARY OF THE STREET OF T
AND CAPERMISIS ALL ME SITE B SHALL DISCRE AL DESS SITE B SHALL DISCRE AL DESS SHALL DISCRE AL DESS FROM CLIENT CIC PROJEC G/F, KOWI DRAWIN BLEV -REC AS S APPROVE DATE PROJEC DATE PROJEC	ANOTE USED WITSION. ASSON. ASSONEMENT MUST EFFORE CONSTRUCT NOTIFY THE DESIG PANCY BEFORE ST OT RESPONSIBLE FO D THE CONTRACTO NOCEDURE. THE CON SIBLE FOR ANY E FAILURE TO DO SC INNOVATION G TITLE //ATION BY BY BC //ED BY	BE VERIFIED TION. CONTRA INDER OF ANY FARTING WOR T.T. OR ANY ERRO R FAIL TO OF INTRACTOR S RERORS RESU CITY C	O ON ICTOR JANUARY OF THE STREET OF T

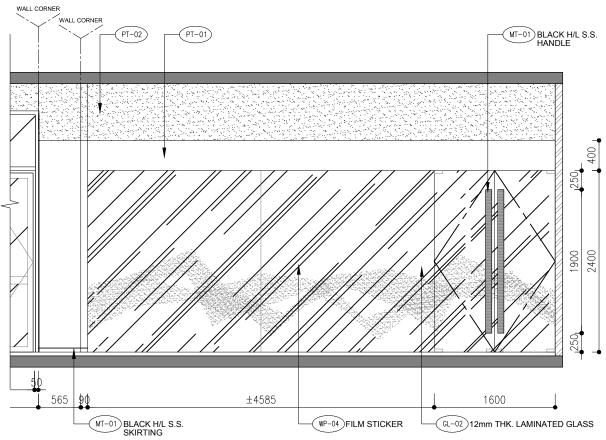

B RECEPTION AREA ELEVATION SCALE 1:25(A1), 1:50(A3)

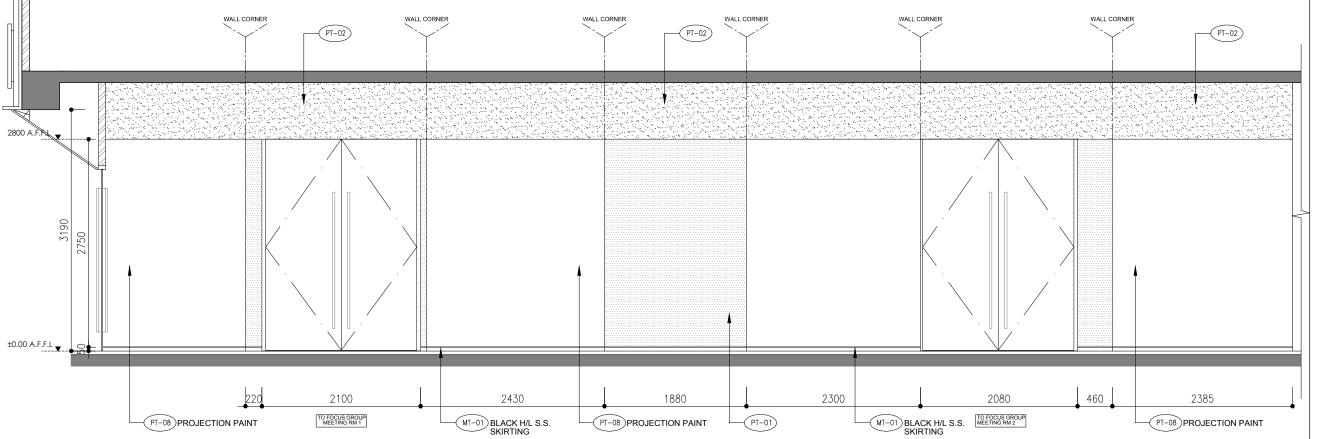

RECEPTION AREA ELEVATION SCALE 1:25(A1), 1:50(A3)

AB-135



REV.	DESCRIPTION	DATE
$\overline{\bigcirc}$		
$\check{\bigcirc}$		
$\check{\cap}$		
$\check{\cap}$		
$\widetilde{\bigcirc}$		
$\widetilde{\frown}$		
$\widetilde{\frown}$		
$\widetilde{\frown}$		
\widetilde{h}		
$\overset{\smile}{\vdash}$		
\bigcirc		
NOTES		

AND CANNOT BE USED WITHOUT THEIR WRITTEN PERMISSION.

ALL MEASUREMENT MUST BE VERIFIED ON SITE BEFORE CONSTRUCTION. CONTRACTOR SHALL NOTIFY THE DESIGNER OF ANY DISCREPANCY BEFORE STARTING WORK. AL DESIGN & ASSOCIATES LTD.
WILL NOT RESPONSIBLE FOR ANY ERRORS SHOULD THE CONTRACTOR FAIL TO OBSERVE THIS PROCEDURE. THE CONTRACTOR SHALL BE RESPONSIBLE FOR ANY ERRORS RESULTINGS FROM FAILURE TO DO SO.

CLIENT

CIC Innovation Center (IC)

PROJECT


G/F, 44 Tai Yip Street Kowloon Bay, Hong Kong

DRAWING TITLE


ELEVATION -RECEPTION AREA

SCALE	DATE
AS SHOWN	26 . 04 . 2017
DRAWN BY	DESIGNED BY
JH/ SC	AY

DATE		
PROJECT NO	DWG NO	
APQ-17-0117		EL-08
CAD FILE REF		
Elevation (current)	.dwg	
TENDER DRAWIN	NG	-

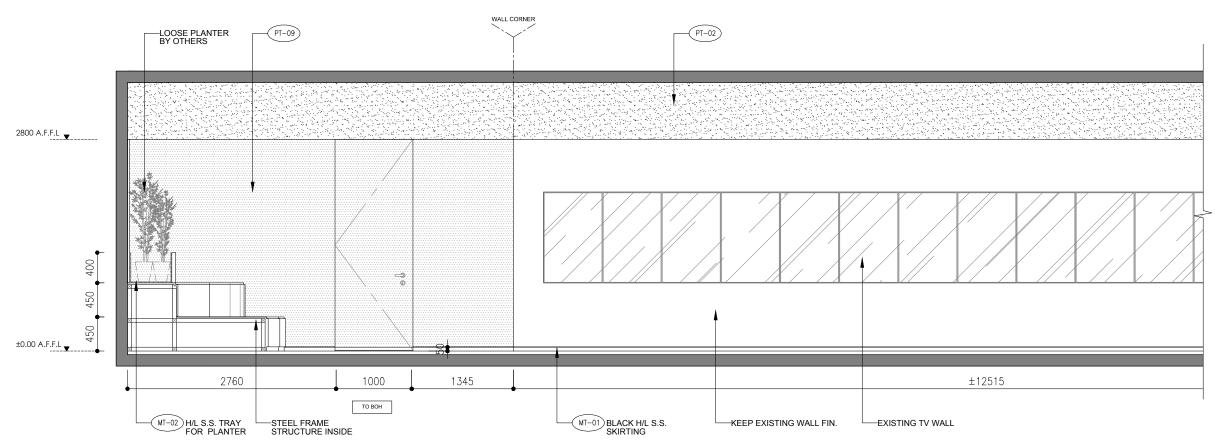

A EXHIBITION AREA ELEVATION SCALE 1:25(A1), 1:50(A3)

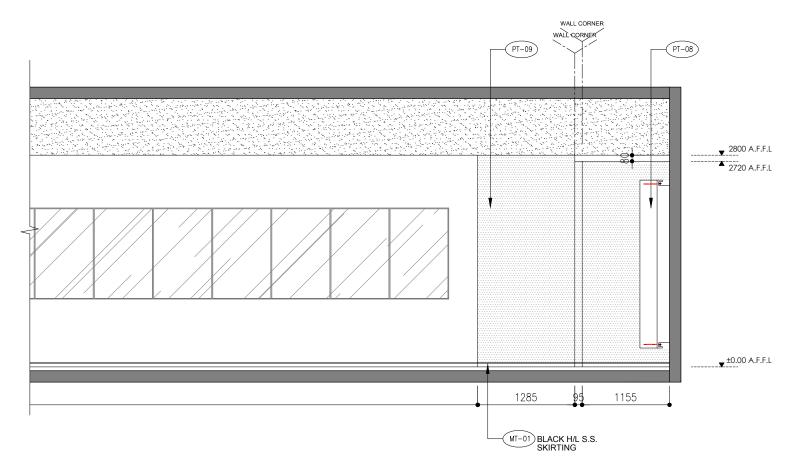

EL-09 SCALE 1:25(A1), 1:50(A3)

AB-136



NOTES ALL DESIGN ARE THE PROPERTY OF AL DESIGN & ASSOCIATES LTD. AND CANNOT BE USED WITHOUT THEIR WRITTEN PERMISSION. ALL MEASUREMENT MUST BE VERIFIED ON ASITE BEFORE CONSTRUCTION. CONTRACTOR SHALL NOTIFY THE DESIGNER OF ANY DISCREPANCY BEFORE STARTING WORK. AL DESIGN & ASSOCIATES LTD. WILL NOT RESPONSIBLE FOR ANY ERRORS SHOULD THE CONTRACTOR FAIL TO OBSERVE HIS PROCEDURE. THE CONTRACTOR SHALL BE RESPONSIBLE FOR ANY ERRORS SHOULD THE CONTRACTOR SHALL BE RESPONSIBLE FOR ANY ERRORS RESULTINGS FROM FAILURE TO DO SO.	REVISION	ON		
ALL DESIGN ARE THE PROPERTY OF AL DESIGN & ASSOCIATES LTD. AND CANNOT BE USED WITHOUT THEIR WRITTEN DERMISSION. ALL MEASUREMENT MUST BE VERIFIED ON ASTE BEFORE CONSTRUCTION. CONTRACTOR BHALL NOTIFY THE DESIGNER OF ANY DISCREPANCY BEFORE STARTING WORK. ALDESIGN & ASSOCIATES LTD. WILL NOT RESPONSIBLE FOR ANY ERRORS SHOULD THE CONTRACTOR FAIL TO OBSERVE HIS PROCEDURE. THE CONTRACTOR SHALL BE RESPONSIBLE FOR ANY ERRORS RESULTINGS FROM FAILURE TO DO SO. CLIENT CIC Innovation Center (IC) PROJECT G/F, 44 Tai Yip Street KOWLOON Bay, Hong Kong DRAWING TITLE ELEVATION EXHIBITION AREA	REV.	DESCRIPTION	DAT	E
ALL DESIGN ARE THE PROPERTY OF AL DESIGN & ASSOCIATES LTD. AND CANNOT BE USED WITHOUT THEIR WRITTEN DERMISSION. ALL MEASUREMENT MUST BE VERIFIED ON ASTE BEFORE CONSTRUCTION. CONTRACTOR BHALL NOTIFY THE DESIGNER OF ANY DISCREPANCY BEFORE STARTING WORK. ALDESIGN & ASSOCIATES LTD. WILL NOT RESPONSIBLE FOR ANY ERRORS SHOULD THE CONTRACTOR FAIL TO OBSERVE HIS PROCEDURE. THE CONTRACTOR SHALL BE RESPONSIBLE FOR ANY ERRORS RESULTINGS FROM FAILURE TO DO SO. CLIENT CIC Innovation Center (IC) PROJECT G/F, 44 Tai Yip Street KOWLOON Bay, Hong Kong DRAWING TITLE ELEVATION EXHIBITION AREA	$\overline{\bigcirc}$			
ALL DESIGN ARE THE PROPERTY OF AL DESIGN & ASSOCIATES LTD. AND CANNOT BE USED WITHOUT THEIR WRITTEN DERMISSION. ALL MEASUREMENT MUST BE VERIFIED ON ASTE BEFORE CONSTRUCTION. CONTRACTOR BHALL NOTIFY THE DESIGNER OF ANY DISCREPANCY BEFORE STARTING WORK. ALDESIGN & ASSOCIATES LTD. WILL NOT RESPONSIBLE FOR ANY ERRORS SHOULD THE CONTRACTOR FAIL TO OBSERVE HIS PROCEDURE. THE CONTRACTOR SHALL BE RESPONSIBLE FOR ANY ERRORS RESULTINGS FROM FAILURE TO DO SO. CLIENT CIC Innovation Center (IC) PROJECT G/F, 44 Tai Yip Street KOWLOON Bay, Hong Kong DRAWING TITLE ELEVATION EXHIBITION AREA	Ŏ			
ALL DESIGN ARE THE PROPERTY OF AL DESIGN & ASSOCIATES LTD. AND CANNOT BE USED WITHOUT THEIR WRITTEN DERMISSION. ALL MEASUREMENT MUST BE VERIFIED ON ASTE BEFORE CONSTRUCTION. CONTRACTOR BHALL NOTIFY THE DESIGNER OF ANY DISCREPANCY BEFORE STARTING WORK. ALDESIGN & ASSOCIATES LTD. WILL NOT RESPONSIBLE FOR ANY ERRORS SHOULD THE CONTRACTOR FAIL TO OBSERVE HIS PROCEDURE. THE CONTRACTOR SHALL BE RESPONSIBLE FOR ANY ERRORS RESULTINGS FROM FAILURE TO DO SO. CLIENT CIC Innovation Center (IC) PROJECT G/F, 44 Tai Yip Street KOWLOON Bay, Hong Kong DRAWING TITLE ELEVATION EXHIBITION AREA	Ō			
ALL DESIGN ARE THE PROPERTY OF AL DESIGN & ASSOCIATES LTD. AND CANNOT BE USED WITHOUT THEIR WRITTEN DERMISSION. ALL MEASUREMENT MUST BE VERIFIED ON ASTE BEFORE CONSTRUCTION. CONTRACTOR BHALL NOTIFY THE DESIGNER OF ANY DISCREPANCY BEFORE STARTING WORK. ALDESIGN & ASSOCIATES LTD. WILL NOT RESPONSIBLE FOR ANY ERRORS SHOULD THE CONTRACTOR FAIL TO OBSERVE HIS PROCEDURE. THE CONTRACTOR SHALL BE RESPONSIBLE FOR ANY ERRORS RESULTINGS FROM FAILURE TO DO SO. CLIENT CIC Innovation Center (IC) PROJECT G/F, 44 Tai Yip Street KOWLOON Bay, Hong Kong DRAWING TITLE ELEVATION EXHIBITION AREA	$\overline{\bigcirc}$			
ALL DESIGN ARE THE PROPERTY OF AL DESIGN & ASSOCIATES LTD. AND CANNOT BE USED WITHOUT THEIR WRITTEN DERMISSION. ALL MEASUREMENT MUST BE VERIFIED ON ASTE BEFORE CONSTRUCTION. CONTRACTOR BHALL NOTIFY THE DESIGNER OF ANY DISCREPANCY BEFORE STARTING WORK. ALDESIGN & ASSOCIATES LTD. WILL NOT RESPONSIBLE FOR ANY ERRORS SHOULD THE CONTRACTOR FAIL TO OBSERVE HIS PROCEDURE. THE CONTRACTOR SHALL BE RESPONSIBLE FOR ANY ERRORS RESULTINGS FROM FAILURE TO DO SO. CLIENT CIC Innovation Center (IC) PROJECT G/F, 44 Tai Yip Street KOWLOON Bay, Hong Kong DRAWING TITLE ELEVATION EXHIBITION AREA	\bigcirc			
ALL DESIGN ARE THE PROPERTY OF AL DESIGN & ASSOCIATES LTD. AND CANNOT BE USED WITHOUT THEIR WRITTEN DERMISSION. ALL MEASUREMENT MUST BE VERIFIED ON ASTE BEFORE CONSTRUCTION. CONTRACTOR BHALL NOTIFY THE DESIGNER OF ANY DISCREPANCY BEFORE STARTING WORK. ALDESIGN & ASSOCIATES LTD. WILL NOT RESPONSIBLE FOR ANY ERRORS SHOULD THE CONTRACTOR FAIL TO OBSERVE HIS PROCEDURE. THE CONTRACTOR SHALL BE RESPONSIBLE FOR ANY ERRORS RESULTINGS FROM FAILURE TO DO SO. CLIENT CIC Innovation Center (IC) PROJECT G/F, 44 Tai Yip Street KOWLOON Bay, Hong Kong DRAWING TITLE ELEVATION EXHIBITION AREA	\bigcirc			
ALL DESIGN ARE THE PROPERTY OF AL DESIGN & ASSOCIATES LTD. AND CANNOT BE USED WITHOUT THEIR WRITTEN DERMISSION. ALL MEASUREMENT MUST BE VERIFIED ON ASTE BEFORE CONSTRUCTION. CONTRACTOR BHALL NOTIFY THE DESIGNER OF ANY DISCREPANCY BEFORE STARTING WORK. ALDESIGN & ASSOCIATES LTD. WILL NOT RESPONSIBLE FOR ANY ERRORS SHOULD THE CONTRACTOR FAIL TO OBSERVE HIS PROCEDURE. THE CONTRACTOR SHALL BE RESPONSIBLE FOR ANY ERRORS RESULTINGS FROM FAILURE TO DO SO. CLIENT CIC Innovation Center (IC) PROJECT G/F, 44 Tai Yip Street KOWLOON Bay, Hong Kong DRAWING TITLE ELEVATION EXHIBITION AREA	\bigcirc			
ALL DESIGN ARE THE PROPERTY OF AL DESIGN & ASSOCIATES LTD. AND CANNOT BE USED WITHOUT THEIR WRITTEN DERMISSION. ALL MEASUREMENT MUST BE VERIFIED ON ASTE BEFORE CONSTRUCTION. CONTRACTOR BHALL NOTIFY THE DESIGNER OF ANY DISCREPANCY BEFORE STARTING WORK. ALDESIGN & ASSOCIATES LTD. WILL NOT RESPONSIBLE FOR ANY ERRORS SHOULD THE CONTRACTOR FAIL TO OBSERVE HIS PROCEDURE. THE CONTRACTOR SHALL BE RESPONSIBLE FOR ANY ERRORS RESULTINGS FROM FAILURE TO DO SO. CLIENT CIC Innovation Center (IC) PROJECT G/F, 44 Tai Yip Street KOWLOON Bay, Hong Kong DRAWING TITLE ELEVATION EXHIBITION AREA	\bigcirc			
ALL DESIGN ARE THE PROPERTY OF AL DESIGN & ASSOCIATES LTD. AND CANNOT BE USED WITHOUT THEIR WRITTEN DERMISSION. ALL MEASUREMENT MUST BE VERIFIED ON ASTE BEFORE CONSTRUCTION. CONTRACTOR BHALL NOTIFY THE DESIGNER OF ANY DISCREPANCY BEFORE STARTING WORK. ALDESIGN & ASSOCIATES LTD. WILL NOT RESPONSIBLE FOR ANY ERRORS SHOULD THE CONTRACTOR FAIL TO OBSERVE HIS PROCEDURE. THE CONTRACTOR SHALL BE RESPONSIBLE FOR ANY ERRORS RESULTINGS FROM FAILURE TO DO SO. CLIENT CIC Innovation Center (IC) PROJECT G/F, 44 Tai Yip Street KOWLOON Bay, Hong Kong DRAWING TITLE ELEVATION EXHIBITION AREA	\bigcirc			
ALL DESIGN ARE THE PROPERTY OF AL DESIGN & ASSOCIATES LTD. AND CANNOT BE USED WITHOUT THEIR WRITTEN DERMISSION. ALL MEASUREMENT MUST BE VERIFIED ON ASTE BEFORE CONSTRUCTION. CONTRACTOR BHALL NOTIFY THE DESIGNER OF ANY DISCREPANCY BEFORE STARTING WORK. ALDESIGN & ASSOCIATES LTD. WILL NOT RESPONSIBLE FOR ANY ERRORS SHOULD THE CONTRACTOR FAIL TO OBSERVE HIS PROCEDURE. THE CONTRACTOR SHALL BE RESPONSIBLE FOR ANY ERRORS RESULTINGS FROM FAILURE TO DO SO. CLIENT CIC Innovation Center (IC) PROJECT G/F, 44 Tai Yip Street KOWLOON Bay, Hong Kong DRAWING TITLE ELEVATION EXHIBITION AREA	\bigcirc			
ALL DESIGN ARE THE PROPERTY OF AL DESIGN & ASSOCIATES LTD. AND CANNOT BE USED WITHOUT THEIR WRITTEN DERMISSION. ALL MEASUREMENT MUST BE VERIFIED ON ASTE BEFORE CONSTRUCTION. CONTRACTOR BHALL NOTIFY THE DESIGNER OF ANY DISCREPANCY BEFORE STARTING WORK. ALDESIGN & ASSOCIATES LTD. WILL NOT RESPONSIBLE FOR ANY ERRORS SHOULD THE CONTRACTOR FAIL TO OBSERVE HIS PROCEDURE. THE CONTRACTOR SHALL BE RESPONSIBLE FOR ANY ERRORS RESULTINGS FROM FAILURE TO DO SO. CLIENT CIC Innovation Center (IC) PROJECT G/F, 44 Tai Yip Street KOWLOON Bay, Hong Kong DRAWING TITLE ELEVATION EXHIBITION AREA	NOTES			
AL DESIGN & ASSOCIATES LTD. WILL MEASUREMENT MUST BE VERIFIED ON BETE BEFORE CONSTRUCTION. CONTRACTOR SHALL NOTIFY THE DESIGNER OF ANY DISCREPANCY BEFORE STARTING WORK. AL DESIGN & ASSOCIATES LTD. WILL NOT RESPONSIBLE FOR ANY ERRORS SHOULD THE CONTRACTOR FAIL TO OBSERVE FINIS PROCEDURE. THE CONTRACTOR SHALL BE RESPONSIBLE FOR ANY ERRORS RESULTINGS FROM FAILURE TO DO SO. CLIENT CIC Innovation Center (IC) PROJECT G/F, 44 Tai Yip Street Kowloon Bay, Hong Kong DRAWING TITLE ELEVATION EXHIBITION AREA				
AL DESIGN & ASSOCIATES LTD. WILL MEASUREMENT MUST BE VERIFIED ON BETE BEFORE CONSTRUCTION. CONTRACTOR SHALL NOTIFY THE DESIGNER OF ANY DISCREPANCY BEFORE STARTING WORK. AL DESIGN & ASSOCIATES LTD. WILL NOT RESPONSIBLE FOR ANY ERRORS SHOULD THE CONTRACTOR FAIL TO OBSERVE FINIS PROCEDURE. THE CONTRACTOR SHALL BE RESPONSIBLE FOR ANY ERRORS RESULTINGS FROM FAILURE TO DO SO. CLIENT CIC Innovation Center (IC) PROJECT G/F, 44 Tai Yip Street Kowloon Bay, Hong Kong DRAWING TITLE ELEVATION EXHIBITION AREA				
AL DESIGN & ASSOCIATES LTD. WILL MEASUREMENT MUST BE VERIFIED ON BETE BEFORE CONSTRUCTION. CONTRACTOR SHALL NOTIFY THE DESIGNER OF ANY DISCREPANCY BEFORE STARTING WORK. AL DESIGN & ASSOCIATES LTD. WILL NOT RESPONSIBLE FOR ANY ERRORS SHOULD THE CONTRACTOR FAIL TO OBSERVE FINIS PROCEDURE. THE CONTRACTOR SHALL BE RESPONSIBLE FOR ANY ERRORS RESULTINGS FROM FAILURE TO DO SO. CLIENT CIC Innovation Center (IC) PROJECT G/F, 44 Tai Yip Street Kowloon Bay, Hong Kong DRAWING TITLE ELEVATION EXHIBITION AREA				
AL DESIGN & ASSOCIATES LTD. WILL MEASUREMENT MUST BE VERIFIED ON BETE BEFORE CONSTRUCTION. CONTRACTOR SHALL NOTIFY THE DESIGNER OF ANY DISCREPANCY BEFORE STARTING WORK. AL DESIGN & ASSOCIATES LTD. WILL NOT RESPONSIBLE FOR ANY ERRORS SHOULD THE CONTRACTOR FAIL TO OBSERVE FINIS PROCEDURE. THE CONTRACTOR SHALL BE RESPONSIBLE FOR ANY ERRORS RESULTINGS FROM FAILURE TO DO SO. CLIENT CIC Innovation Center (IC) PROJECT G/F, 44 Tai Yip Street Kowloon Bay, Hong Kong DRAWING TITLE ELEVATION EXHIBITION AREA				
AL DESIGN & ASSOCIATES LTD. WILL MEASUREMENT MUST BE VERIFIED ON BETE BEFORE CONSTRUCTION. CONTRACTOR SHALL NOTIFY THE DESIGNER OF ANY DISCREPANCY BEFORE STARTING WORK. AL DESIGN & ASSOCIATES LTD. WILL NOT RESPONSIBLE FOR ANY ERRORS SHOULD THE CONTRACTOR FAIL TO OBSERVE FINIS PROCEDURE. THE CONTRACTOR SHALL BE RESPONSIBLE FOR ANY ERRORS RESULTINGS FROM FAILURE TO DO SO. CLIENT CIC Innovation Center (IC) PROJECT G/F, 44 Tai Yip Street Kowloon Bay, Hong Kong DRAWING TITLE ELEVATION EXHIBITION AREA				
CIC Innovation Center (IC) PROJECT G/F, 44 Tai Yip Street Kowloon Bay, Hong Kong PRAWING TITLE ELEVATION EXHIBITION AREA	AL DES	IGN & ASSOCIATES LTD ANNOT BE USED WITHO).	
PROJECT G/F, 44 Tai Yip Street Kowloon Bay, Hong Kong PRAWING TITLE ELEVATION EXHIBITION AREA	AL DES AND CAPERMIS ALL ME SITE B SHALL DISCRE AL DES WILL NO SHOUL FHIS PE RESPO	IGN & ASSOCIATES LTE NINOT BE USED WITH SISION. EASUREMENT MUST B EFORE CONSTRUCTIO NOTIFY THE DESIGNE FPANCY BEFORE STAF IGN & ASSOCIATES LTE OT RESPONSIBLE FOR D THE CONTRACTOR ROCEDURE. THE CONT NSIBLE FOR ANY ERF	DUIT THEIR WRITTEN E VERIFIED ON N. CONTRACTOR OF ANY RTING WORK. D. ANY ERRORS FAIL TO OBSERVE FRACTOR SHALL BE	
CALE DATE	AL DES AND CAPERMIS ALL ME SITE B SHALL DISCRE AL DES WILL NO SHOUL FHIS PE RESPO	IGN & ASSOCIATES LTE NINOT BE USED WITH SISION. EASUREMENT MUST B EFORE CONSTRUCTIO NOTIFY THE DESIGNE FPANCY BEFORE STAF IGN & ASSOCIATES LTE OT RESPONSIBLE FOR D THE CONTRACTOR ROCEDURE. THE CONT NSIBLE FOR ANY ERF	DUIT THEIR WRITTEN E VERIFIED ON N. CONTRACTOR OF ANY RTING WORK. D. ANY ERRORS FAIL TO OBSERVE FRACTOR SHALL BE	
Cowloon Bay, Hong Kong DRAWING TITLE ELEVATION EXHIBITION AREA SCALE DATE	AL DES AND CA PERMIS ALL ME SITE B SHALL DISCRE AL DES WILL NO SHOUL THIS PF RESPO FROM	IGN & ASSOCIATES LTD NNOT BE USED WITH SISION. ASSUREMENT MUST B EFORE CONSTRUCTIO NOTIFY THE DESIGNE PPANCY BEFORE STAF IGN & ASSOCIATES LTD OT RESPONSIBLE FOR D THE CONTRACTOR ROCEDURE. THE CONT NSIBLE FOR ANY ERF FAILURE TO DO SO.	DOUT THEIR WRITTEN E VERIFIED ON N. CONTRACTOR ER OF ANY RTING WORK. D. ANY ERRORS FAIL TO OBSERVE RACTOR SHALL BE RORS RESULTINGS	
ELEVATION EXHIBITION AREA	AL DES ALL ME ALL ME BEHALL DISCRE AL DES BHOUL THIS PO FROM	IGN & ASSOCIATES LTD NNNOT BE USED WITHO SISION. ASSUREMENT MUST B EFORE CONSTRUCTIO NOTIFY THE DESIGNE PPANCY BEFORE STAF IGN & ASSOCIATES LTD OT RESPONSIBLE FOR D THE CONTRACTOR ROCEDURE. THE CONT NSIBLE FOR ANY ERF FAILURE TO DO SO. Innovation Cent	DOUT THEIR WRITTEN E VERIFIED ON N. CONTRACTOR ER OF ANY RTING WORK. D. ANY ERRORS FAIL TO OBSERVE RACTOR SHALL BE RORS RESULTINGS	
EXHIBITION AREA SCALE DATE	ALL MEDISCREE ALL MEDISCREE ALL MEDISCREE ALL DES WILL NO FROM CLIENT CIC G/F,	IGN & ASSOCIATES LTE WINNOT BE USED WITHOUSE ON THE PROPERTY OF THE PESIGNE PROPERTY OF THE PESIGNE PROPERTY OF THE PESIGNE PROPERTY OF THE PESIGNE FOR THE CONTRACTOR ROCEDURE. THE CONTRACTOR SOLUTION NSIBLE FOR ANY ERFAILURE TO DO SO. Innovation Center of The Pesigne Property Of The Contractor Rocedure.	DOUT THEIR WRITTEN E VERIFIED ON N. CONTRACTOR ER OF ANY RTING WORK. D. ANY ERRORS FAIL TO OBSERVE RACTOR SHALL BE RORS RESULTINGS EVER (IC)	
	ALL ME ALL ME ALL ME BHALL BHA	IGN & ASSOCIATES LTE INNOT BE USED WITH INNOT BE USED WITH INSION. ASSUREMENT MUST BEFORE CONSTRUCTION NOTIFY THE DESIGNE PRANCY BEFORE STAFFIGN & ASSOCIATES LTE OT RESPONSIBLE FOR DITHE CONTRACTOR ROCEDURE. THE CONTRIBULE FOR ANY ERFEAILURE TO DO SO. Innovation Center 144 Tai Yip Street Oon Bay, Hong	DOUT THEIR WRITTEN E VERIFIED ON N. CONTRACTOR ER OF ANY RTING WORK. D. ANY ERRORS FAIL TO OBSERVE RACTOR SHALL BE RORS RESULTINGS EVER (IC)	
AS SHOWN 26 . 04 . 2017	AL DES ALL DES AND CA A	IGN & ASSOCIATES LTE MINOT BE USED WITHOUSION. EASUREMENT MUST B EFORE CONSTRUCTION NOTIFY THE DESIGNE PRANCY BEFORE STAFFIGHT & ASSOCIATES LTE OT RESPONSIBLE FOR DITHE CONTRACTOR ROCEDURE. THE CONTRIBUTE FOR ANY ERFEAILURE TO DO SO. Innovation Centary Contraction Centary	DOUT THEIR WRITTEN E VERIFIED ON N. CONTRACTOR ER OF ANY RTING WORK. D. ANY ERRORS FAIL TO OBSERVE RACTOR SHALL BE RORS RESULTINGS EVER (IC)	
	AL DES SIND CANDON SIND CANDON SIND CANDON SIND CANDON SIND CANDON SIND SIND SIND SIND SIND SIND SIND SIN	IGN & ASSOCIATES LTE MINOT BE USED WITHOUSE ON MINOT BE USED WITHOUSE ON MINOT BE USED WITHOUSE ON MINOT BE EFORE CONSTRUCTION NOTIFY THE DESIGNE FRANCY BEFORE STAFFIGN & ASSOCIATES LTE OT RESPONSIBLE FOR DITHE CONTRACTOR ROCEDURE. THE CONTRACTOR ROCEDURE. THE CONTRACTOR SOLUTION OF THE CONTRACTOR ON MINOTE TO DO SO. Innovation Center of The Contract of The Contract on The Contr	DOUT THEIR WRITTEN E VERIFIED ON N. CONTRACTOR ER OF ANY RING WORK. D. ANY ERRORS FAIL TO OBSERVE RACTOR SHALL BE OORS RESULTINGS ET (IC) THE CONTRACTOR T	
	AL DES SIND CANDON SIND CANDON SIND CANDON SIND CANDON SIND CANDON SIND SIND SIND SIND SIND SIND SIND SIN	IGN & ASSOCIATES LTE WINNOT BE USED WITHOUSEND. EASUREMENT MUST B EFORE CONSTRUCTION NOTIFY THE DESIGNE PRONCY BEFORE STAFF IGN & ASSOCIATES LTD. OT RESPONSIBLE FOR DOTHE CONTRACTOR ROCEDURE. THE CONTRACTOR ROCEDURE. THE CONTRACTOR FAILURE TO DO SO. Innovation Central Contractor Central Contractor Central Contractor Central Centr	DOUT THEIR WRITTEN E VERIFIED ON N. CONTRACTOR ER OF ANY RING WORK. D. ANY ERRORS FAIL TO OBSERVE RACTOR SHALL BE OORS RESULTINGS ET (IC) THE CONTRACTOR T	

DATE PROJECT NO


DWG NO

APQ-17-0117


EL-09

CAD FILE REF

Elevation (current).dwg

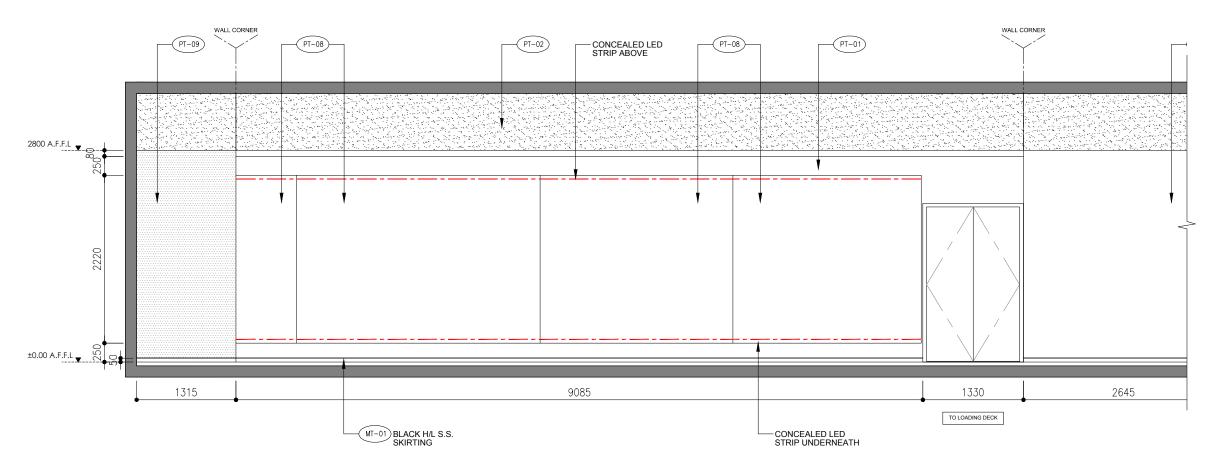

B EXHIBITION AREA ELEVATION SCALE 1:25(A1), 1:50(A3)

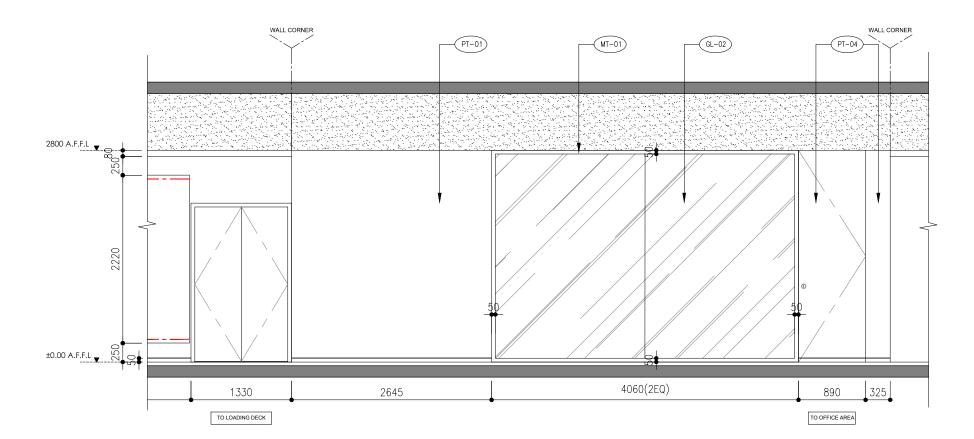


- EXHIBITION AREA ELEVATION SCALE 1:25(A1), 1:50(A3)

* ALL THE SIZE NEED TO VERIFY ON SITE




REVISION	
REV. DESCRIPTION	DATE
\bigcirc	
\bigcirc	
\bigcirc	
$\overline{\bigcirc}$	
$\overline{\bigcirc}$	
\bigcirc	
NOTES	
NOTES	
AND CANNOT BE USED WITHO PERMISSION. ALL MEASUREMENT MUST BI SITE BEFORE CONSTRUCTION SHALL NOTIFY THE DESIGNE DISCREPANCY BEFORE STAF AL DESIGN & ASSOCIATES LTD	E VERIFIED ON N. CONTRACTOR R OF ANY ITING WORK.
AND CANNOT BE USED WITHO PERMISSION. ALL MEASUREMENT MUST BI SITE BEFORE CONSTRUCTION SHALL NOTIFY THE DESIGNE DISCREPANCY BEFORE STAFAL DESIGN & ASSOCIATES LTE WILL NOT RESPONSIBLE FOR SHOULD THE CONTRACTOR IT THIS PROCEDURE. THE CONTRESPONSIBLE FOR RESPONSIBLE FOR ANY ERR	DUIT THEIR WRITTEN E VERIFIED ON N. CONTRACTOR R OF ANY ITING WORK. D. ANY ERRORS ANI TO OBSERVE RACTOR SHALL BE
AND CANNOT BE USED WITHO PERMISSION. ALL MEASUREMENT MUST BI SITE BEFORE CONSTRUCTION SHALL NOTIFY THE DESIGNE DISCREPANCY BEFORE STAFF ALL DESIGN & ASSOCIATES LTC WILL NOT RESPONSIBLE FOR SHOULD THE CONTRACTOR INTIC THIS PROCEDURE. THE CONTRESPONSIBLE FOR ANY ERRESPONSIBLE FOR ANY ER	DUIT THEIR WRITTEN E VERIFIED ON N. CONTRACTOR R OF ANY ITING WORK. D. ANY ERRORS ANI TO OBSERVE RACTOR SHALL BE
AND CANNOT BE USED WITHO PERMISSION. ALL MEASUREMENT MUST BI SITE BEFORE CONSTRUCTION SHALL NOTIFY THE DESIGNE DISCREPANCY BEFORE STAFF ALL DESIGN & ASSOCIATES LTC WILL NOT RESPONSIBLE FOR SHOULD THE CONTRACTOR INTIC THIS PROCEDURE. THE CONTRESPONSIBLE FOR ANY ERRESPONSIBLE FOR ANY ER	DUIT THEIR WRITTEN E VERIFIED ON N. CONTRACTOR R OF ANY ITING WORK. D. ANY ERRORS ANI TO OBSERVE RACTOR SHALL BE
AND CANNOT BE USED WITHO PPERMISSION. ALL MEASUREMENT MUST BI SITE BEFORE CONSTRUCTION SHALL NOTIFY THE DESIGNE DISCREPANCY BEFORE STAF AL DESIGN & ASSOCIATES LTC WILL NOT RESPONSIBLE FOR SHOULD THE CONTRACTOR I THIS PROCEDURE. THE CONT RESPONSIBLE FOR ANY ERR FROM FAILURE TO DO SO. CLIENT	DUIT THEIR WRITTEN E VERIFIED ON N. CONTRACTOR R OF ANY STITING WORK. D. ANY ERRORS FAIL TO OBSERVE RACTOR SHALL BE ORS RESULTINGS
AL DESIGN & ASSOCIATES LTC AND CANNOT BE USED WITHO PERMISSION. ALL MEASUREMENT MUST BI SITE BEFORE CONSTRUCTION SHALL NOTIFY THE DESIGNE DISCREPANCY BEFORE STAFAL DESIGN & ASSOCIATES LTC WILL NOT RESPONSIBLE FOR SHOULD THE CONTRACTOR IT HIS PROCEDURE. THE CONTRESPONSIBLE FOR ANY ERREPONSIBLE FOR ANY	DUIT THEIR WRITTEN E VERIFIED ON N. CONTRACTOR R OF ANY STITING WORK. D. ANY ERRORS FAIL TO OBSERVE RACTOR SHALL BE ORS RESULTINGS
AND CANNOT BE USED WITHO PERMISSION. ALL MEASUREMENT MUST BI SITE BEFORE CONSTRUCTIO SHALL NOTIFY THE DESIGNE DISCREPANCY BEFORE STAF AL DESIGN & ASSOCIATES LTE WILL NOT RESPONSIBLE FOR SHOULD THE CONTRACTOR I THIS PROCEDURE. THE CONT RESPONSIBLE FOR ANY ERR FROM FAILURE TO DO SO. CLIENT CIC Innovation Cent	DUIT THEIR WRITTEN E VERIFIED ON N. CONTRACTOR R OF ANY ITTING WORK. D. ANY ERRORS FAIL TO OBSERVE RACTOR SHALL BE ORS RESULTINGS er (IC)
AND CANNOT BE USED WITHO PERMISSION. ALL MEASUREMENT MUST BI SITE BEFORE CONSTRUCTIO SHALL NOTIFY THE DESIGNE DISCREPANCY BEFORE STAF AL DESIGN & ASSOCIATES LTE WILL NOT RESPONSIBLE FOR SHOULD THE CONTRACTOR I THIS PROCEDURE. THE CONT RESPONSIBLE FOR ANY ERR FROM FAILURE TO DO SO. CLIENT CIC Innovation Cent PROJECT G/F, 44 Tai Yip Stree	DUIT THEIR WRITTEN E VERIFIED ON N. CONTRACTOR R OF ANY ITTING WORK. D. ANY ERRORS FAIL TO OBSERVE RACTOR SHALL BE ORS RESULTINGS er (IC)
AND CANNOT BE USED WITHO PERMISSION. ALL MEASUREMENT MUST BISSTE BEFORE CONSTRUCTION SHALL NOTIFY THE DESIGNE DISCREPANCY BEFORE STAF ALL DESIGN & ASSOCIATES LTC WILL NOT RESPONSIBLE FOR SHOULD THE CONTRACTOR ITHIS PROCEDURE. THE CONTRESPONSIBLE FOR ANY ERRESPONSIBLE FOR ANY ERRESPONSIBLE FOR DESPONSIBLE FOR DESPONS	DUIT THEIR WRITTEN E VERIFIED ON N. CONTRACTOR R OF ANY ITTING WORK. D. ANY ERRORS FAIL TO OBSERVE RACTOR SHALL BE ORS RESULTINGS er (IC)
AND CANNOT BE USED WITHOUSE BEFORE SOON. ALL MEASUREMENT MUST BISTE BEFORE CONSTRUCTION SHALL NOTIFY THE DESIGNE DISCREPANCY BEFORE STAFAL DESIGN & ASSOCIATES LTD. WILL NOT RESPONSIBLE FOR SHOULD THE CONTRACTOR INTERPROCEDURE. THE CONTRACTOR INTERPROMEDIAL FOR ANY ERREPONSIBLE FO	DUIT THEIR WRITTEN E VERIFIED ON N. CONTRACTOR R OF ANY ITTING WORK. D. ANY ERRORS FAIL TO OBSERVE RACTOR SHALL BE ORS RESULTINGS er (IC)
AND CANNOT BE USED WITHOUT PERMISSION. ALL MEASUREMENT MUST BISTTE BEFORE CONSTRUCTION SHALL NOTIFY THE DESIGNE DISCREPANCY BEFORE STAFAL DESIGN & ASSOCIATES LTD WILL NOT RESPONSIBLE FOR SHOULD THE CONTRACTOR INTHIS PROCEDURE. THE CONTRESPONSIBLE FOR ANY ERRESPONSIBLE FOR ANY ERRESPON	DUIT THEIR WRITTEN E VERIFIED ON N. CONTRACTOR R OF ANY ITTING WORK. D. ANY ERRORS FAIL TO OBSERVE RACTOR SHALL BE ORS RESULTINGS er (IC)
AND CANNOT BE USED WITHOUSE BY SITE BEFORE CONSTRUCTION SHALL NOTIFY THE DESIGNE DISCREPANCY BEFORE STAFAL DESIGN & ASSOCIATES LTD WILL NOT RESPONSIBLE FOR SHOULD THE CONTRACTOR ITHIS PROCEDURE. THE CONTRACTOR ITHIS PROCEDURE TO DO SO. CLIENT CIC Innovation Cent PROJECT G/F, 44 Tai Yip Street Kowloon Bay, Hong DRAWING TITLE ELEVATION EXHIBITION AREA	DUIT THEIR WRITTEN E VERIFIED ON N. CONTRACTOR R OF ANY ITTING WORK. D. ANY ERRORS FAIL TO OBSERVE RACTOR SHALL BE ORS RESULTINGS er (IC)
AND CANNOT BE USED WITHOUSE BY SITE BEFORE CONSTRUCTION SHALL NOTIFY THE DESIGNE DISCREPANCY BEFORE STAFAL DESIGN & ASSOCIATES LTD WILL NOT RESPONSIBLE FOR SHOULD THE CONTRACTOR ITHIS PROCEDURE. THE CONTRACTOR ITHIS PROCEDURE TO DO SO. CLIENT CIC Innovation Cent PROJECT G/F, 44 Tai Yip Street Kowloon Bay, Hong DRAWING TITLE ELEVATION EXHIBITION AREA	DUIT THEIR WRITTEN E VERIFIED ON N. CONTRACTOR R OF ANY ITING WORK. D. ANY ERRORS FAIL TO OBSERVE RACTOR SHALL BE ORS RESULTINGS ET (IC)
AND CANNOT BE USED WITHOUSE BETWEEN SIGNAL ALL MEASUREMENT MUST BISSITE BEFORE CONSTRUCTION SHALL NOTIFY THE DESIGNE DISCREPANCY BEFORE STAFAL DESIGNA & ASSOCIATES LITU WILL NOT RESPONSIBLE FOR SHOULD THE CONTRACTOR INTHIS PROCEDURE. THE CONT RESPONSIBLE FOR ANY ERR FROM FAILURE TO DO SO. CLIENT CIC Innovation Cent PROJECT G/F, 44 Tai Yip Street Kowloon Bay, Hong DRAWING TITLE ELEVATION EXHIBITION AREA SCALE AS SHOWN	DUIT THEIR WRITTEN E VERIFIED ON N. CONTRACTOR R OF ANY ITING WORK. D. ANY ERRORS FAIL TO OBSERVE RACTOR SHALL BE ORS RESULTINGS ET (IC) ET KONG
AND CANNOT BE USED WITHOPPERMISSION. ALL MEASUREMENT MUST BISITE BEFORE CONSTRUCTION SHALL NOTIFY THE DESIGNE DISCREPANCY BEFORE STAFA AL DESIGN & ASSOCIATES LIT. WILL NOT RESPONSIBLE FOR SHOULD THE CONTRACTOR INTHIS PROCEDURE. THE CONT RESPONSIBLE FOR ANY ERR FROM FAILURE TO DO SO. CLIENT CIC Innovation Cent PROJECT G/F, 44 Tai Yip Street Kowloon Bay, Hong DRAWING TITLE ELEVATION -EXHIBITION AREA SCALE AS SHOWN	DUIT THEIR WRITTEN E VERIFIED ON N. CONTRACTOR R OF ANY STITING WORK. J. ANY ERRORS FAIL TO OBSERVE RACTOR SHALL BE ORS RESULTINGS ET (IC) DATE 26.04.2017
AND CANNOT BE USED WITHO PERMISSION. ALL MEASUREMENT MUST BI SITE BEFORE CONSTRUCTION SHALL NOTIFY THE DESIGNE DISCREPANCY BEFORE STAF AL DESIGN & ASSOCIATES LITE WILL NOT RESPONSIBLE FOR SHOULD THE CONTRACTOR I THIS PROCEDURE. THE CONT RESPONSIBLE FOR ANY ERR FROM FAILURE TO DO SO. CLIENT CIC Innovation Cent PROJECT G/F, 44 Tai Yip Street Kowloon Bay, Hong DRAWING TITLE ELEVATION -EXHIBITION AREA SCALE AS SHOWN DRAWN BY	DUIT THEIR WRITTEN E VERIFIED ON N. CONTRACTOR R OF ANY ITTING WORK. J. ANY ERRORS FAIL TO OBSERVE RACTOR SHALL BE ORS RESULTINGS ET (IC) DATE 26.04.2017 DESIGNED BY
AND CANNOT BE USED WITHOPPERMISSION. ALL MEASUREMENT MUST BISSITE BEFORE CONSTRUCTION SHALL NOTIFY THE DESIGNE DISCREPANCY BEFORE STAFAL DESIGNA & ASSOCIATES LITU WILL NOT RESPONSIBLE FOR SHOULD THE CONTRACTOR INTHIS PROCEDURE. THE CONT RESPONSIBLE FOR ANY ERR FROM FAILURE TO DO SO. CLIENT CIC Innovation Cent PROJECT G/F, 44 Tai Yip Stree KOWIOON Bay, Hong DRAWING TITLE ELEVATION EXHIBITION AREA SCALE AS SHOWN DRAWN BY IP/ SC	DUIT THEIR WRITTEN E VERIFIED ON N. CONTRACTOR R OF ANY ITTING WORK. J. ANY ERRORS FAIL TO OBSERVE RACTOR SHALL BE ORS RESULTINGS ET (IC) DATE 26.04.2017 DESIGNED BY
AND CANNOT BE USED WITHOUSE BLOWN THE PROPERMISSION. ALL MEASUREMENT MUST BISTE BEFORE CONSTRUCTION SHALL NOTIFY THE DESIGNE DISCREPANCY BEFORE STAFAL DESIGN & ASSOCIATES LTD WILL NOT RESPONSIBLE FOR SHOULD THE CONTRACTOR INTERPROPERMINE FOR ANY ERREPONSIBLE F	DUIT THEIR WRITTEN E VERIFIED ON N. CONTRACTOR R OF ANY ITTING WORK. J. ANY ERRORS FAIL TO OBSERVE RACTOR SHALL BE ORS RESULTINGS ET (IC) DATE 26.04.2017 DESIGNED BY

Elevation (current).dwg

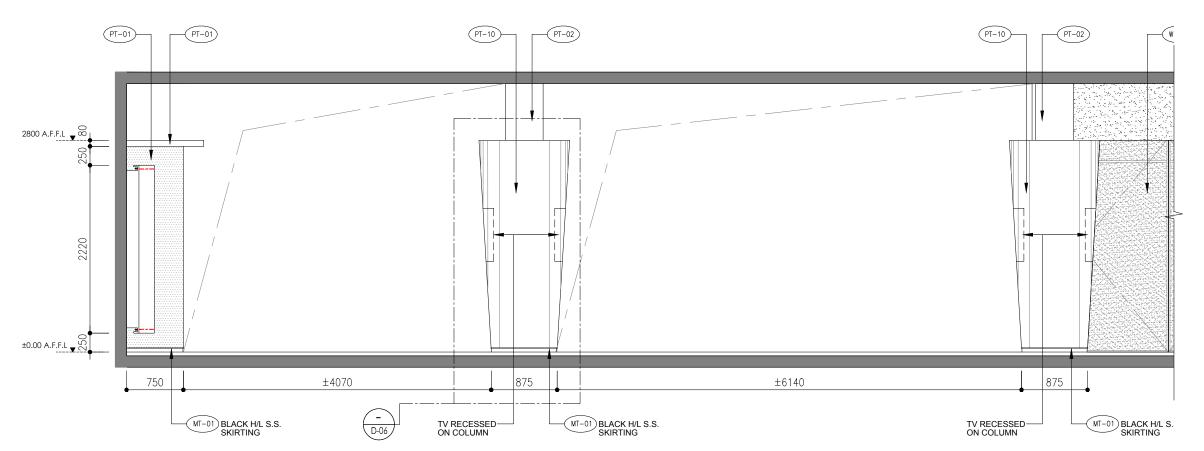

EXHIBITION AREA ELEVATION SCALE 1:25(A1), 1:50(A3)

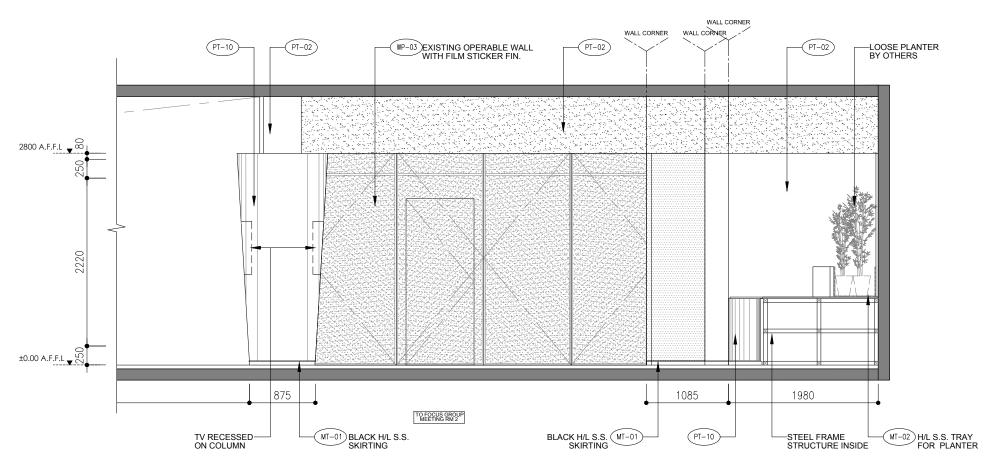

EXHIBITION AREA ELEVATION
SCALE 1:25(A1), 1:50(A3)

* ALL THE SIZE NEED TO VERIFY ON SITE AB-138




	_	
AL	Desig	n
REVISION		
REV. DESCRIPTION		DATE
$\overline{\bigcirc}$		
$\overline{\bigcirc}$		
Ō		
$\overline{\bigcirc}$		
Ō		
\bigcirc		
$\overline{\bigcirc}$		
$\overline{\bigcirc}$		
\bigcirc		
\bigcirc		
NOTES		
PERMISSION. ALL MEASUREMENT MUSITE BEFORE CONSTRUSHALL NOTIFY THE DESIGNATION OF THE DESIGNATION OF THE DESIGNATION OF THE SECONDARY OF THE PROCEDURE. THE RESPONSIBLE FOR ANY FROM FAILURE TO DOCULENT	ICTION. CONTRIGUER OF ANY STARTING WC SELTD. FOR ANY ERFOR FAIL TO CONTRACTOR FERONS RES	RACTOR (*) RORS RORS DBSERVE SHALL BE UULTINGS
PROJECT		
-/- // Fai Via C	street	
	ong Kong	
Kowloon Bay, Ho	ong Kong	
Cowloon Bay, Ho		
Cowloon Bay, Ho DRAWING TITLE ELEVATION EXHIBITION AR		
G/F, 44 Tai Yip S Kowloon Bay, Ho DRAWING TITLE ELEVATION EXHIBITION AF SCALE AS SHOWN	REA	ł . 2017
Cowloon Bay, Ho	REA	

PROJECT NO DWG

APQ-17-0117 EL-11

CAD FILE REF


Elevation (current).dwg

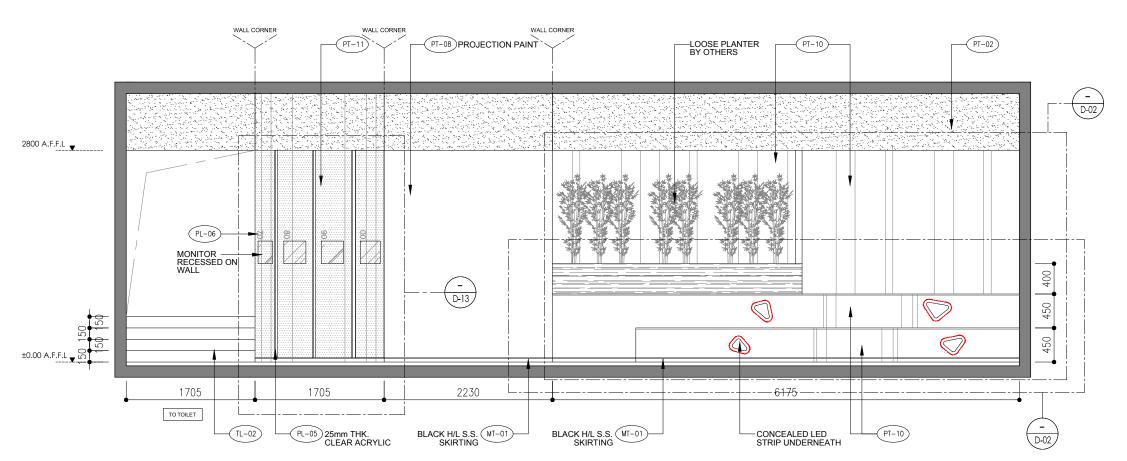



D EXHIBITION AREA ELEVATION SCALE 1:25(A1), 1:50(A3)



REV.	DESCRIPTION	DATE
$\overline{\bigcirc}$		
$\check{\cap}$		
$\widetilde{\frown}$		
$\widetilde{\prec}$		
$\stackrel{\smile}{\sim}$		
$\stackrel{\smile}{\sim}$		
\cong		
\subseteq		
\bigcirc		
\bigcirc		
\bigcirc		
NOTES		
AL DES AND CA PERMIS ALL ME SITE BI SHALL DISCRE AL DES WILL NO SHOUL	EASUREMENT MUST BE VE EFORE CONSTRUCTION. C NOTIFY THE DESIGNER O PANCY BEFORE STARTING IGN & ASSOCIATES LTD. DT RESPONSIBLE FOR ANY D THE CONTRACTOR FAIL	THEIR WRITTEN ERIFIED ON ONTRACTOR F ANY G WORK. C ERRORS TO OBSERVE
AL DES AND CA PERMIS ALL ME SITE BI SHALL DISCRE AL DES WILL NO SHOUL THIS PE RESPO FROM	IGN & ASSOCIATES LTD. INNOT BE USED WITHOUT ISSION. EASUREMENT MUST BE VE EFORE CONSTRUCTION. C NOTIFY THE DESIGNER O EPANCY BEFORE STARTING IGN & ASSOCIATES LTD. DT RESPONSIBLE FOR ANY	THEIR WRITTEN ERIFIED ON ONTRACTOR F ANY 3 WORK. / ERRORS TO OBSERVE TOR SHALL BE
AL DES AND CA PERMIS ALL ME SITE BI SHALL DISCRE AL DES WILL NO SHOUL THIS PE RESPO FROM	IGN & ASSOCIATES LTD. INNOT BE USED WITHOUT ISSION. EASUREMENT MUST BE VE EFORE CONSTRUCTION. C NOTIFY THE DESIGNER O FEANCY BEFORE STARTING IGN & ASSOCIATES LTD. DT RESPONSIBLE FOR ANY D THE CONTRACTOR FAIL ROCEDURE. THE CONTRAC NSIBLE FOR ANY ERRORS	ERIFIED ON ONTRACTOR F ANY G WORK. / ERRORS TO OBSERVE TOR SHALL BE RESULTINGS
AL DES AND CA PERMIS ALL ME SITE BI SHALL DISCRE AL DES WILL NO SHOUL THIS PE RESPO FROM	IGN & ASSOCIATES LTD. INNOT BE USED WITHOUT ISSION. EASUREMENT MUST BE VE EFORE CONSTRUCTION. C NOTIFY THE DESIGNER O FPANCY BEFORE STARTING IGN & ASSOCIATES LTD. DT RESPONSIBLE FOR ANY D THE CONTRACT NSIBLE FOR ANY ERRORS FAILURE TO DO SO. INNOVATION CENTER INN	ERIFIED ON ONTRACTOR F ANY G WORK. / ERRORS TO OBSERVE TOR SHALL BE RESULTINGS
AL DES AND CA PERMIS ALL ME BISHABL DISCRE BISHABL FRES FRES FRES FRES FRES FRES FRES FRES	IGN & ASSOCIATES LTD. INNOT BE USED WITHOUT ISSION. EASUREMENT MUST BE VE EFORE CONSTRUCTION. C NOTIFY THE DESIGNER O FPANCY BEFORE STARTING IGN & ASSOCIATES LTD. DT RESPONSIBLE FOR ANY D THE CONTRACT NSIBLE FOR ANY ERRORS FAILURE TO DO SO. INNOVATION CENTER INN	THEIR WRITTEN ERIFIED ON ONTRACTOR F ANY 3 WORK. F ERRORS TO OBSERVE TOO SHALL BE RESULTINGS (IC)
AL DES AL DES AND CA AN	IGN & ASSOCIATES LTD. INNOT BE USED WITHOUT ISSION. EASUREMENT MUST BE VE EFORE CONSTRUCTION. C NOTIFY THE DESIGNER O IFONICY BEFORE STARTING IGN & ASSOCIATES LTD. DT RESPONSIBLE FOR ANY DT RESPONSIBLE FOR ANY ROCEDURE. THE CONTRACTOR FAIL ROCEDURE. THE CONTRACT NSIBLE FOR ANY ERRORS FAILURE TO DO SO. INNOVATION CENTER INT 444 Tai Yip Street	THEIR WRITTEN ERIFIED ON ONTRACTOR F ANY 3 WORK. F ERRORS TO OBSERVE TOO SHALL BE RESULTINGS (IC)
AL DES MAND CA	IGN & ASSOCIATES LTD. INNOT BE USED WITHOUT ISSION. EASUREMENT MUST BE VE EFORE CONSTRUCTION. C NOTIFY THE DESIGNER O PEPANCY BEFORE STARTING IGN & ASSOCIATES LTD. DT RESPONSIBLE FOR ANY D THE CONTRACT NSIBLE FOR ANY ERRORS FAILURE TO DO SO. Innovation Center (TT 44 Tai Yip Street TOON BAY, Hong Koi	THEIR WRITTEN ERIFIED ON ONTRACTOR F ANY 3 WORK. F ERRORS TO OBSERVE TOO SHALL BE RESULTINGS (IC)
AL DES MAND CA	IGN & ASSOCIATES LTD. INNOT BE USED WITHOUT ISSION. EASUREMENT MUST BE VE EFORE CONSTRUCTION. C NOTIFY THE DESIGNER O PERNICY BEFORE STARTING IGN & ASSOCIATES LTD. DT RESPONSIBLE FOR ANY DT THE CONTRACTOR FAIL OCCEDURE. THE CONTRACT NSIBLE FOR ANY ERRORS FAILURE TO DO SO. INNOVATION CENTER 44 Tai Yip Street DOON Bay, Hong KOI IG TITLE //ATION IIBITION AREA	THEIR WRITTEN ERIFIED ON ONTRACTOR F ANY G WORK. F ERRORS TO OBSERVE TOR SHALL BE RESULTINGS (IC)
AL DES AND CARAMAN CAR	IGN & ASSOCIATES LTD. INNOT BE USED WITHOUT SION. EASUREMENT MUST BE VE EFORE CONSTRUCTION. C NOTIFY THE DESIGNER O IGN & ASSOCIATES LTD. DT RESPONSIBLE FOR ANY DT HE CONTRACTOR FAIL. ROCEDURE. THE CONTRACT NSIBLE FOR ANY ERRORS FAILURE TO DO SO. INNOVATION Center (THE CONTRACTOR FAIL ROCEDURE. THE CONTRACT SIBLE FOR ANY ERRORS FAILURE TO DO SO. INNOVATION CENTER THE CONTRACT THE CONTRACT AND THE CONTRACT	THEIR WRITTEN ERIFIED ON ONTRACTOR F ANY G WORK. (ERRORS TO OBSERVE TOR SHALL BE F RESULTINGS (IC)
AL DES SAND CAS SAND	IGN & ASSOCIATES LTD. INNOT BE USED WITHOUT SIGN. EASUREMENT MUST BE VEFORE CONSTRUCTION. C NOTIFY THE DESIGNER O PERMICY BEFORE STARTING IGN & ASSOCIATES LTD. DIT RESPONSIBLE FOR ANY DITHE CONTRACTOR FAIL ACCEDURE. THE CONTRACT NSIBLE FOR ANY ERRORS FAILURE TO DO SO. INNOVATION Center (THE CONTRACTOR FAIL ACCEDURE. THE CONTRACT NSIBLE FOR ANY ERRORS FAILURE TO DO SO. INNOVATION CENTER THE CONTRACTOR FAIL THE CONTRAC	THEIR WRITTEN ERIFIED ON ONTRACTOR F ANY G WORK. (ERRORS TO OBSERVE TOO SHALL BE G RESULTINGS (IC)
AL DES AND CARAMAN CAR	IGN & ASSOCIATES LTD. INNOT BE USED WITHOUT SION. EASUREMENT MUST BE VE EFORE CONSTRUCTION. C NOTIFY THE DESIGNER O IGN & ASSOCIATES LTD. DT RESPONSIBLE FOR ANY DT HE CONTRACTOR FAIL. ROCEDURE. THE CONTRACT NSIBLE FOR ANY ERRORS FAILURE TO DO SO. INNOVATION Center (ATT ATTON HIBITION AREA BY DESIGN ET ALL ET	THEIR WRITTEN ERIFIED ON ONTRACTOR F ANY G WORK. (ERRORS TO OBSERVE TOO SHALL BE G RESULTINGS (IC)
AL DES AND CA AN	IGN & ASSOCIATES LTD. INNOT BE USED WITHOUT SION. EASUREMENT MUST BE VE EFORE CONSTRUCTION. C NOTIFY THE DESIGNER O IGN & ASSOCIATES LTD. DT RESPONSIBLE FOR ANY DT HE CONTRACTOR FAIL. ROCEDURE. THE CONTRACT NSIBLE FOR ANY ERRORS FAILURE TO DO SO. INNOVATION Center (ATT ATTON HIBITION AREA BY DESIGN ET ALL ET	THEIR WRITTEN ERIFIED ON ONTRACTOR F ANY G WORK. (ERRORS TO OBSERVE TOO SHALL BE G RESULTINGS (IC)
AL DES MAND CAMAND CAMA	IGN & ASSOCIATES LTD. WINOT BE USED WITHOUT SISION. EASUREMENT MUST BE VE EFORE CONSTRUCTION. C NOTIFY THE DESIGNER O PERMICY BEFORE STARTING IGN & ASSOCIATES LTD. DT RESPONSIBLE FOR ANY ET CONTRACTOR FAIL ROCEDURE. THE CONTRACT NSIBLE FOR ANY ERRORS FAILURE TO DO SO. INNOVATION CENTER AT 144 Tai Yip Street DOON Bay, Hong KOI GTITLE VATION IIBITION AREA DATE SHOWN 26 BY DESI ACC AY VED BY	ERIFIED ON ONTRACTOR F ANY G WORK. (FERRORS TO OBSERVE TOR SHALL BE RESULTINGS (IC)

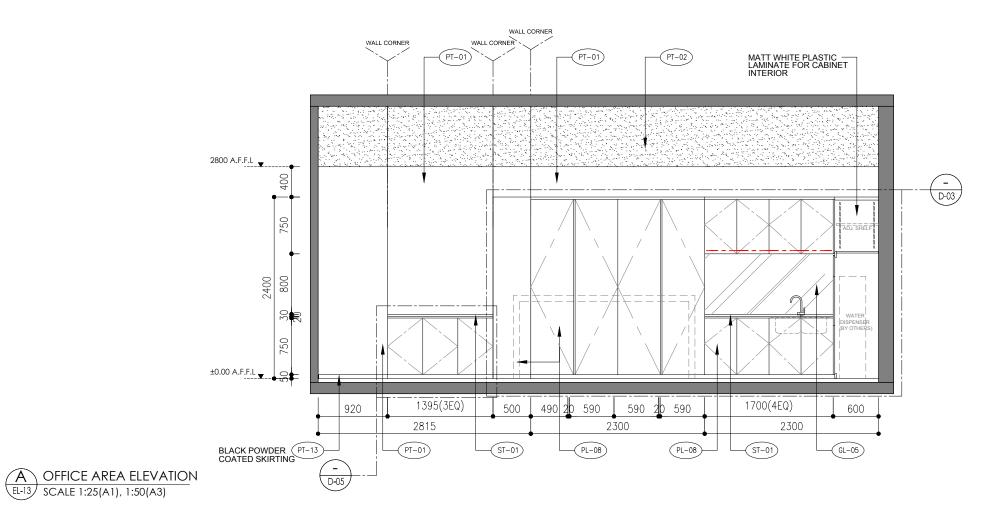

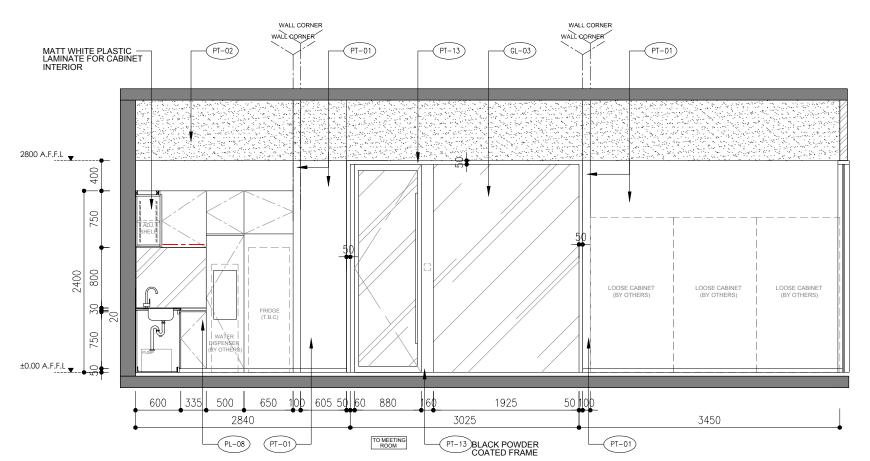

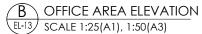

* ALL THE SIZE NEED TO VERIFY ON SITE AB-140




REVISION	
REV. DESCRIPTION	DAT
<u> </u>	
\bigcirc	
$\overline{\bigcirc}$	
NOTES	
PERMISSION. ALL MEASUREMENT SITE BEFORE CONST	NTES LTD. ID WITHOUT THEIR WRITTEN MUST BE VERIFIED ON TRUCTION. CONTRACTOR
AL DESIGN & ASSOCIAND CANNOT BE USE PERMISSION. ALL MEASUREMENT SITE BEFORE CONST SHALL NOTIFY THE IDISCREPANCY BEFOR ALDESIGN & ASSOCIANULL NOT RESPONSIES SHOULD THE CONTR THIS PROCEDURE. TH	MUST BE VERIFIED ON PROCESSION OF A STATE OF ANY CONTRACTOR DESIGNER OF ANY CONTRACTOR DESIGNER OF ANY CONTRACTOR DESIGNER OF ANY CONTRACTOR CONTRACTOR CONTRACTOR CONTRACTOR CONTRACTOR SHALL BE CONTRACTOR SHALL BE CONTRACTOR SHALL BE
AL DESIGN & ASSOCIA AND CANNOT BE USE PERMISSION. ALL MEASUREMENT SITE BEFORE CONST SHALL NOTIFY THE I DISCREPANCY BEFOR AL DESIGN & ASSOCIA WILL NOT RESPONSIE SHOULD THE CONTR THIS PROCEDURE. TH RESPONSIBLE FOR A	MUST BE VERIFIED ON PROCESSION OF A STATE OF ANY CONTRACTOR DESIGNER OF ANY CONTRACTOR DESIGNER OF ANY CONTRACTOR DESIGNER OF ANY CONTRACTOR CONTRACTOR CONTRACTOR CONTRACTOR CONTRACTOR SHALL BE CONTRACTOR SHALL BE CONTRACTOR SHALL BE
AL DESIGN & ASSOCIA AND CANNOT BE USE PERMISSION. ALL MEASUREMENT SITE BEFORE CONST SHALL NOTIFY THE ID DISCREPANCY BEFORE AL DESIGN & ASSOCIA WILL NOT RESPONSIE SHOULD THE CONTR RESPONSIBLE FOR A FROM FAILURE TO DE	NTES LTD. ID WITHOUT THEIR WRITTEN MUST BE VERIFIED ON RUCTION. CONTRACTOR DESIGNER OF ANY RE STARTING WORK. INTES LTD. LE FOR ANY ERRORS ACTOR FAIL TO OBSERVE HE CONTRACTOR SHALL BE INY ERRORS RESULTINGS TO SO.
AL DESIGN & ASSOCIA AND CANNOT BE USE PERMISSION. ALL MEASUREMENT SITE BEFORE CONST SHALL NOTIFY THE ID DISCREPANCY BEFOR AL DESIGN & ASSOCIA WILL NOT RESPONSIE SHOULD THE CONTR RESPONSIBLE FOR A FROM FAILURE TO E	NTES LTD. ID WITHOUT THEIR WRITTEN MUST BE VERIFIED ON RUCTION. CONTRACTOR DESIGNER OF ANY RE STARTING WORK. INTES LTD. LE FOR ANY ERRORS ACTOR FAIL TO OBSERVE HE CONTRACTOR SHALL BE INY ERRORS RESULTINGS TO SO.
AL DESIGN & ASSOCIÓ AND CANNOT BE USE PERMISSION. ALL MEASUREMENT SITE BEFORE CONST SHALL NOTIFY THE I DISCREPANCY BEFOI AL DESIGN & ASSOCIÓ WILL NOT RESPONSIE SHOULD THE CONTT THIS PROCEDURE. TI RESPONSIBLE FOR A FROM FAILURE TO E CLIENT CIC Innovation PROJECT	NTES LTD. ID WITHOUT THEIR WRITTEN MUST BE VERIFIED ON RUCTION. CONTRACTOR DESIGNER OF ANY RE STARTING WORK. NITES LTD. LE FOR ANY ERRORS ACTOR FAIL TO OBSERVE HE CONTRACTOR SHALL BE INY ERRORS RESULTINGS TO SO.
AL DESIGN & ASSOCI/ AND CANNOT BE USE PERMISSION. ALL MEASUREMENT SITE BEFORE CONST SHALL NOTIFY THE I DISCREPANCY BEFOI AL DESIGN & ASSOCI/ WILL NOT RESPONSIE SHOULD THE CONTR HIS PROCEDURE. TH RESPONSIBLE FOR A FROM FAILURE TO DE CLIENT CIC Innovation	MUST BE VERIFIED ON PROCESSION OF A CONTRACTOR DESIGNER OF ANY RESTARTING WORK. ATTES LTD. LE FOR ANY ERRORS ACTOR FAIL TO OBSERVE HE CONTRACTOR SHALL BE NAY ERRORS RESULTINGS TO SO.
AL DESIGN & ASSOCI/ AND CANNOT BE USE PERMISSION. ALL MEASUREMENT SITE BEFORE CONST SHALL NOTIFY THE I DISCREPANCY BEFOR AL DESIGN & ASSOCI/ WILL NOT RESPONSIE SHOULD THE CONTENT THIS PROCEDURE. TH RESPONSIBLE FOR A FROM FAILURE TO DE CLIENT CIC Innovation PROJECT G/F, 44 Tai Yip	MUST BE VERIFIED ON PROCESSION OF A CONTRACTOR DESIGNER OF ANY RESTARTING WORK. ATTES LTD. LE FOR ANY ERRORS ACTOR FAIL TO OBSERVE HE CONTRACTOR SHALL BE NAY ERRORS RESULTINGS TO SO.
AL DESIGN & ASSOCIA AND CANNOT BE USE PERMISSION. ALL MEASUREMENT SITE BEFORE CONST SHALL NOTIFY THE I DISCREPANCY BEFOR AL DESIGN & ASSOCIA WILL NOT RESPONSIE SHOULD THE CONTR HIS PROCEDURE. TH RESPONSIBLE FOR A FROM FAILURE TO DE CLIENT CIC Innovation PROJECT G/F, 44 Tai Yip Kowloon Bay, I	MUST BE VERIFIED ON PRUCTION. CONTRACTOR DESIGNER OF ANY RESTARTING WORK. ATTES LTD. LE FOR ANY ERRORS ACTOR FAIL TO OBSERVE HE CONTRACTOR SHALL BE INVERTORS RESULTINGS TO SO. A Center (IC)
AL DESIGN & ASSOCIA AND CANNOT BE USE PERMISSION. ALL MEASUREMENT SITE BEFORE CONST SHALL NOTIFY THE I DISCREPANCY BEFOR AL DESIGN & ASSOCIA WILL NOT RESPONSIE SHOULD THE CONTT RESPONSIBLE FOR A FROM FAILURE TO E CLIENT CIC Innovation PROJECT G/F, 44 Tai Yip Kowloon Bay, I DRAWING TITLE ELEVATION	MUST BE VERIFIED ON PRUCTION. CONTRACTOR DESIGNER OF ANY RESTARTING WORK. ATTES LTD. LE FOR ANY ERRORS ACTOR FAIL TO OBSERVE HE CONTRACTOR SHALL BE INVERTORS RESULTINGS TO SO. A Center (IC)
AL DESIGN & ASSOCIA AND CANNOT BE USE PERMISSION. ALL MEASUREMENT SITE BEFORE CONST SHALL NOTIFY THE I DISCREPANCY BEFOR AL DESIGN & ASSOCIA WILL NOT RESPONSIE SHOULD THE CONTR RESPONSIBLE FOR A FROM FAILURE TO D CLIENT CIC Innovation PROJECT G/F, 44 Tai YIP KOWIOON Bay, I DRAWING TITLE ELEVATION -OFFICE ARE.	MUST BE VERIFIED ON PRUCTION. CONTRACTOR DESIGNER OF ANY RESTARTING WORK. ATTES LTD. LE FOR ANY ERRORS ACTOR FAIL TO OBSERVE HE CONTRACTOR SHALL BE INVERTED SO. CHARACTER (IC)
AL DESIGN & ASSOCIA AND CANNOT BE USE PERMISSION. ALL MEASUREMENT SITE BEFORE CONST SHALL NOTIFY THE I DISCREPANCY BEFOR AL DESIGN & ASSOCIA WILL NOT RESPONSIE SHOULD THE CONTT THIS PROCEDURE. TH RESPONSIBLE FOR A FROM FAILURE TO E CLIENT CIC Innovation PROJECT G/F, 44 Tai Yip Kowloon Bay, I DRAWING TITLE ELEVATION -OFFICE ARE.	MUST BE VERIFIED ON PRUCTION. CONTRACTOR DESIGNER OF ANY RESTARTING WORK. ATTES LTD. LE FOR ANY ERRORS ACTOR FAIL TO OBSERVE HE CONTRACTOR SHALL BE NY ERRORS RESULTINGS TO SO. I Center (IC)

PROJECT NO DWG


APQ-17-0117 EL-13

CAD FILE REF

Elevation - office area.dwg

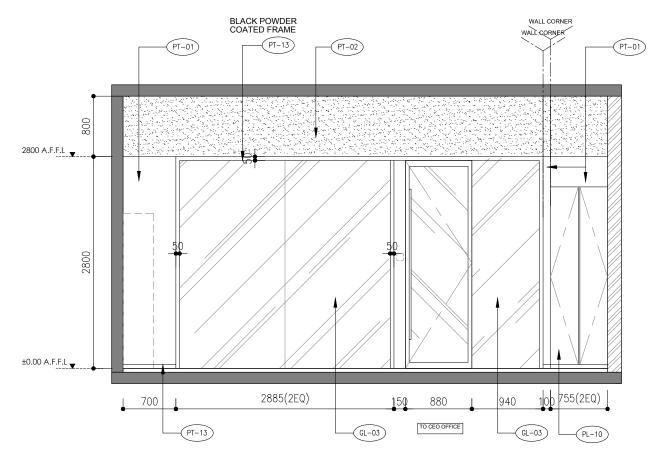


OFFICE AREA ELEVATION SCALE 1:50(A3)

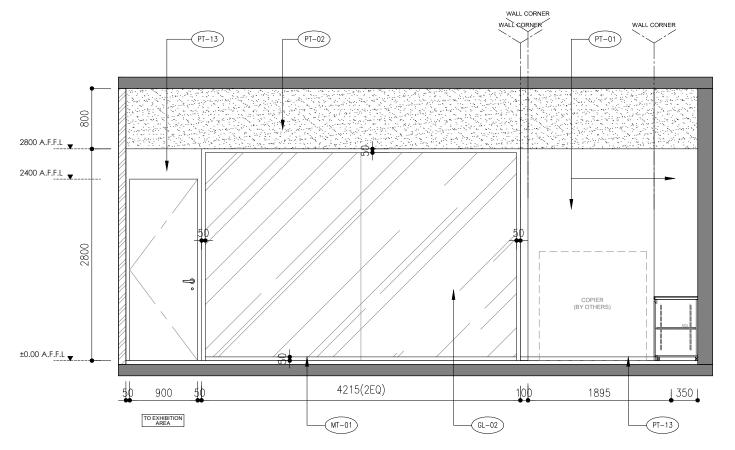


OFFICE AREA ELEVATION SCALE 1:50(A3)





REV.	DESCRIPTION	DAT
$\overline{\bigcirc}$		
\preceq		
\approx		
\approx		
\Rightarrow		
\cong		
\supseteq		
\bigcirc		
NOTES		
AL DES AND CA PERMIA ALL M SITE E SHALL	SIGN & ASSOCIATES LTD. ANNOT BE USED WITHOUT	ERIFIED ON CONTRACTOR OF ANY
AL DES AND C. PERMI ALL M SITE E SHALL DISCRI AL DES WILL N SHOUL THIS P RESPORTED FROM	SIGN & ASSOCIATES LTD. ANNOT BE USED WITHOUT SSION. EASUREMENT MUST BE VI SEFORE CONSTRUCTION. (NOTIFY THE DESIGNER (THEIR WRITTEN ERIFIED ON CONTRACTOR OF ANY G WORK. Y ERRORS TO OBSERVE CTOR SHALL BE S RESULTINGS
AL DES AND C. PERMI ALL M SITE E SHALL DISCRIAL DI	SIGN & ASSOCIATES LTD. ANNOT BE USED WITHOUT SSION. EASUREMENT MUST BE VI DEFORE CONSTRUCTION. (C) NOTIFY THE DESIGNER (C) EPPANCY BEFORE STARTIN SIGN & ASSOCIATES LTD. OT RESPONSIBLE FOR AN LD THE CONTRACTOR FAIL ONSIBLE FOR ANY ERRORS FAILURE TO DO SO. Innovation Center CT 44 Tai Yip Street	THEIR WRITTEN ERIFIED ON CONTRACTOR DF ANY G WORK. Y ERRORS TO OBSERVE STOR SHALL BE S RESULTINGS (IC)
AL DES AND C. PERMI ALL M ALL M SHALL DISCRI AL DES SHALL DISCRI AL DES CLIENT CLIENT CLIENT CIC PROJEC G/F, KOWI	SIGN & ASSOCIATES LTD. ANNOT BE USED WITHOUT SSION. EASUREMENT MUST BE VI DEFORE CONSTRUCTION. C NOTIFY THE DESIGNER C EPPANCY BEFORE STARTIN SIGN & ASSOCIATES LTD. OUT RESPONSIBLE FOR AN LD THE CONTRACTOR FAIL ROCEDURE. THE CONTRACT NISIBLE FOR ANY ERRORS FAILURE TO DO SO. Innovation Center 44 Tai Yip Street IOON Bay, Hong Ko	THEIR WRITTEN ERIFIED ON CONTRACTOR DF ANY G WORK. Y ERRORS TO OBSERVE STOR SHALL BE S RESULTINGS (IC)
AL DES AND C. ALL M SITE E SHALL M SITE E SHALL DISCHIEF ALL DES CHIEF A	SIGN & ASSOCIATES LTD. ANNOT BE USED WITHOUT SSION. EASUREMENT MUST BE VI DEFORE CONSTRUCTION. (C) NOTIFY THE DESIGNER (C) EPPANCY BEFORE STARTIN SIGN & ASSOCIATES LTD. OT RESPONSIBLE FOR AN LD THE CONTRACTOR FAIL ONSIBLE FOR ANY ERRORS FAILURE TO DO SO. Innovation Center CT 44 Tai Yip Street	THEIR WRITTEN ERIFIED ON CONTRACTOR DF ANY G WORK. Y ERRORS TO OBSERVE STOR SHALL BE S RESULTINGS (IC)
AL DES AND C. ALL M SITE E SHALL M SITE E SHALL DISCHIEF ALL DES CHIEF A	SIGN & ASSOCIATES LTD. ANNOT BE USED WITHOUT SSION. EASUREMENT MUST BE VI DEFORE CONSTRUCTION. O NOTIFY THE DESIGNER O EPPANCY BEFORE STARTIN SIGN & ASSOCIATES LTD. OT RESPONSIBLE FOR AN LOTHE CONTRACTOR FAIL DISTRIBLE FOR ANY ERRORS FAILURE TO DO SO. Innovation Center 44 Tai Yip Street Ioon Bay, Hong Ko	THEIR WRITTEN ERIFIED ON CONTRACTOR OF ANY G WORK. Y ERRORS TO OBSERVE ETOR SHALL BE IS RESULTINGS (IC)
AL DES AND C. ALL M SITE E SHALL AL DES SHALL AL DES WILL N SHOUL THIS P RESPC FROM CLIENT CIC PROJEC G/F, KOWI DRAWII ELE -OFI SCALE	SIGN & ASSOCIATES LTD. ANNOT BE USED WITHOUT SSION. EASUREMENT MUST BE VIDEO FOR THE PERSON. EASUREMENT OF THE PERSON. EASUREMENT OF THE CONTRACTOR FAIL ENSIBLE FOR ANY ERRORS FAILURE TO DO SO. Innovation Center CT 44 Tai Yip Street Ioon Bay, Hong Ko ING TITLE VATION FICE AREA	THEIR WRITTEN ERIFIED ON CONTRACTOR OF ANY G WORK. Y ERRORS TO OBSERVE ETOR SHALL BE IS RESULTINGS (IC)
AL DES AND C. ALL M SITE E SHALL AL DES SHALL AL DES WILL N SHOUL THIS P RESPC FROM CLIENT CIC PROJEC G/F, KOWI DRAWII ELE -OFI SCALE	SIGN & ASSOCIATES LTD. ANNOT BE USED WITHOUT SSION. EASUREMENT MUST BE VI SEFORE CONSTRUCTION. (IN NOTIFY THE DESIGNER CONTENT OF THE PERSONS SIGN & ASSOCIATES LTD. OT RESPONSIBLE FOR AN LICENSE FOR ANY ERRORS FAILURE TO DO SO. Innovation Center 44 Tai Yip Street IOON Bay, Hong Ko	THEIR WRITTEN ERIFIED ON CONTRACTOR OF ANY G WORK. Y ERRORS TO OBSERVE TOTOR SHALL BE S RESULTINGS (IC)
AL DES AND C. ALL M SITE E SHALL M SITE E SHALL M SITE E SHALL M SHOULD FROM THIS P RESPONDE FROM CLIENT CIC PROJECT FROM CLIENT CIC PROJECT FROM DEAWNING STATE S	SIGN & ASSOCIATES LTD. ANNOT BE USED WITHOUT SSION. EASUREMENT MUST BE VI DEFORE CONSTRUCTION. CONOTIFY THE DESIGNER CONSTRUCTION. CONOTIFY THE DESIGNER CONSTRUCTION. CONOTIFY THE DESIGNER CONTRACTOR FAIL DITHE TO DO SO. INTO THE CONTRACTOR FAIL DITHE CONTRACTOR	THEIR WRITTEN ERIFIED ON CONTRACTOR OF ANY G WORK. Y ERRORS TO OBSERVE TOR SHALL BE S RESULTINGS (IC) Ing E 6 . 04 . 2017
AL DES AND C. ALL M SITE E SHALL M SITE E SHALL M SITE E SHALL M SHOULD FROM THIS P RESPONSIVE FROM CLIENT CIC PROJECT FROM DRAWIII SCALE AS DRAWN JH/	SIGN & ASSOCIATES LTD. ANNOT BE USED WITHOUT SSION. EASUREMENT MUST BE VI DEFORE CONSTRUCTION. CONOTIFY THE DESIGNER CONSTRUCTION. CONOTIFY THE DESIGNER CONSTRUCTION. CONOTIFY THE DESIGNER CONTRACTOR FAIL DITHE TO DO SO. INTO THE CONTRACTOR FAIL DITHE CONTRACTOR	THEIR WRITTEN ERIFIED ON CONTRACTOR OF ANY G WORK. Y ERRORS TO OBSERVE TOR SHALL BE S RESULTINGS (IC) Ing E 6 . 04 . 2017
AL DES AND C. ALL M SITE E SHALL M SITE E SHALL DISCHED IN THIS P RESPONSITION OF THE SHALL DISCHED IN THIS PROJECT OF THE SHALL DISCHED IN THIS PROJECT OF THE SHALL DISCHED IN THE SHALL DIS	SIGN & ASSOCIATES LTD. ANNOT BE USED WITHOUT SSION. EASUREMENT MUST BE VIDEO FOR THE DESIGNER OF THE CONTRACTOR FAIL OF THE CONTRACTOR FAILURE TO DO SO. Innovation Center 44 Tai Yip Street Hoon Bay, Hong Ko NG TITLE VATION FICE AREA DAT SHOWN 21 BY DES SC A* VED BY	THEIR WRITTEN ERIFIED ON CONTRACTOR OF ANY G WORK. Y ERRORS TO OBSERVE STOR SHALL BE S RESULTINGS (IC) Ing E 6 . 04 . 2017
AL DES AND C. ALL M SITE E SHALL M SITE E SHALL M SITE E SHALL M SHOULD FROM THIS P RESPONSIVE FROM CLIENT CIC PROJECT FROM DRAWII SCALE AS DRAWN JH/ APPRO	SIGN & ASSOCIATES LTD. ANNOT BE USED WITHOUT SSION. EASUREMENT MUST BE VI SEFORE CONSTRUCTION. CONTIFY THE DESIGNER CONTENT OF THE PERSONS SIDE FOR AN LITTURE TO THE POST OF THE CONTRACTOR FAILURE TO DO SO. Innovation Center THE CONTRACTOR FAILURE TO DO SO. Innovation Center CT 44 Tai Yip Street Idoon Bay, Hong Ko NG TITLE VATION FICE AREA DAT SHOWN 20 SC A CT NO DWC	THEIR WRITTEN ERIFIED ON CONTRACTOR OF ANY G WORK. Y ERRORS TO OBSERVE TOR SHALL BE S RESULTINGS (IC) Ing E 6 . 04 . 2017

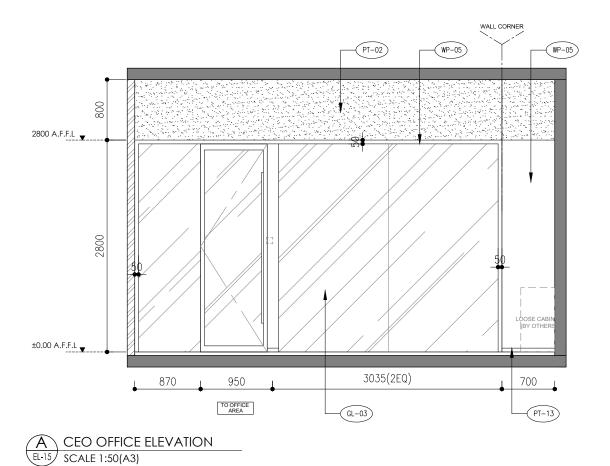

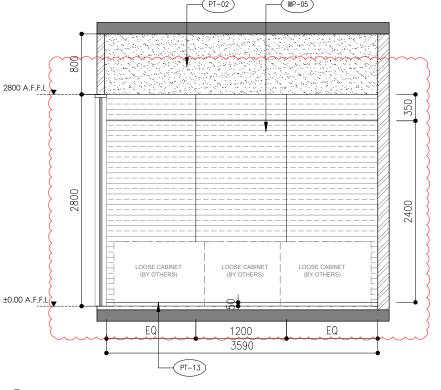

B CEO OFFICE ELEVATION SCALE 1:50(A3)

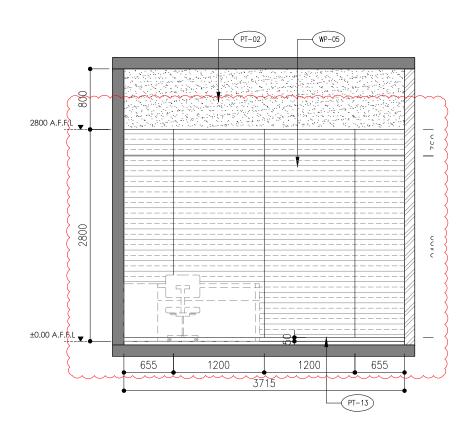

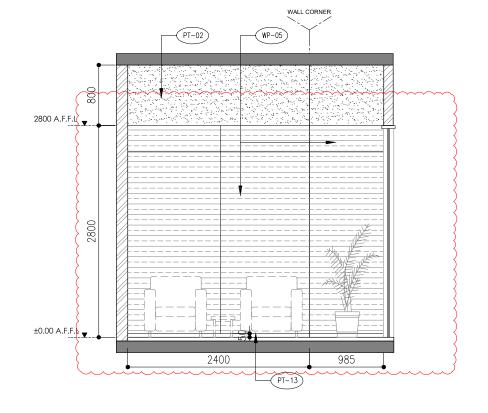

D CEO OFFICE ELEVATION SCALE 1:50(A3)

* ALL THE SIZE NEED TO VERIFY ON SITE

AB-142



REV.	DESCRIPTION	DATE
1	CLIENT COMMENT	11-05-2017
\bigcirc		
NOTES		

ALL DESIGN ARE THE PROPERTY OF AL DESIGN & ASSOCIATES LTD. AND CANNOT BE USED WITHOUT THEIR WRITTEN PERMISSION.

ALL MEASUREMENT MUST BE VERIFIED ON SITE BEFORE CONSTRUCTION. CONTRACTOR SHALL NOTIFY THE DESIGNER OF ANY DISCREPANCY BEFORE STARTING WORK. AL DESIGN & ASSOCIATES LTD.
WILL NOT RESPONSIBLE FOR ANY ERRORS SHOULD THE CONTRACTOR FAIL TO OBSERVE THIS PROCEDURE. THE CONTRACTOR SHALL BE RESPONSIBLE FOR ANY ERRORS RESULTINGS FROM FAILURE TO DO SO.

CLIENT

CIC Innovation Center (IC)

PROJECT

G/F, 44 Tai Yip Street Kowloon Bay, Hong Kong

DRAWING TITLE

ELEVATION CEO OFFICE


SCALE	DATE
AS SHOWN	26 . 04 . 2017
DRAWN BY	DESIGNED BY
JH/ SC	AY

APPROVED BY

DATE		
PROJECT NO	DWG NO	_
APQ-17-0117	EL-15	
CAD FILE REF		_

Elevation - office area.dwg

CEO OFFICE EL-15 SCALE 1:50(A3) CEO OFFICE ELEVATION

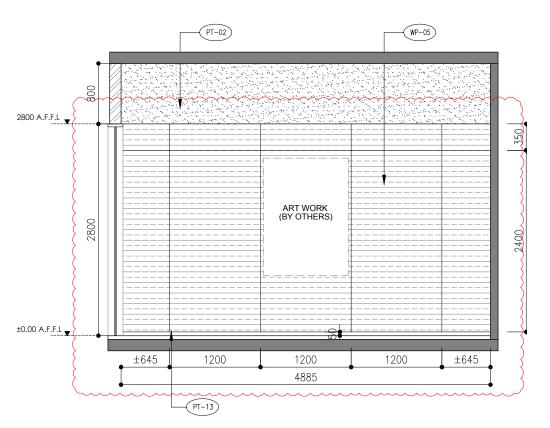

±0.00 A.F.F.L 1200 ±118\$ ±1185 3570 1265

WP-05

- PT-02

2800 A.F.F.L ▼.


WALL CORNER

MEETING ROOM ELEVATION

EL-16 SCALE 1:50(A3)

WP-05 2800 A.F.F.L ±0.00 A.F.F.L ±995 1200 ±995 1180 3195 510 -(PT-13)

MEETING ROOM ELEVATION
SCALE 1:50(A3)

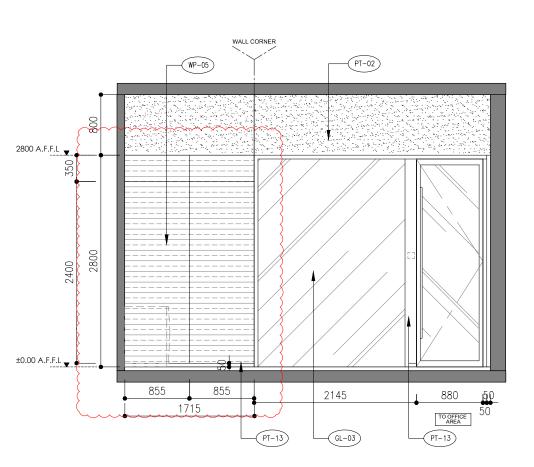

D MEETING ROOM ELEVATION SCALE 1:50(A3)

B MEETING ROOM ELEVATION

EL-16 SCALE 1:50(A3)



REV.	DESCRIPTION	DATE
1	CLIENT COMMENT	11-05-201
\bigcirc		
$\overline{\bigcirc}$		
NOTES		
AL DES	SIGN ARE THE PROPERTY OF IGN & ASSOCIATES LTD. INNOT BE USED WITHOUT THE SSION.	
ALL ME SITE B SHALL DISCRE	EASUREMENT MUST BE VERIF EFORE CONSTRUCTION. CONT NOTIFY THE DESIGNER OF AR EPANCY BEFORE STARTING WIGN & ASSOCIATES LTD.	TRACTOR NY

WILL NOT RESPONSIBLE FOR ANY ERRORS SHOULD THE CONTRACTOR FAIL TO OBSERVE THIS PROCEDURE. THE CONTRACTOR SHALL BE RESPONSIBLE FOR ANY ERRORS RESULTINGS FROM FAILURE TO DO SO.

CLIENT

CIC Innovation Center (IC)

PROJECT

G/F, 44 Tai Yip Street Kowloon Bay, Hong Kong


DRAWING TITLE


ELEVATION -MEETING ROOM


SCALE DATE AS SHOWN 26.04.2017 DESIGNED BY ΑY JH/ SC APPROVED BY


PROJECT NO DWG NO EL-16 APQ-17-0117 CAD FILE REF


Elevation - office area.dwg

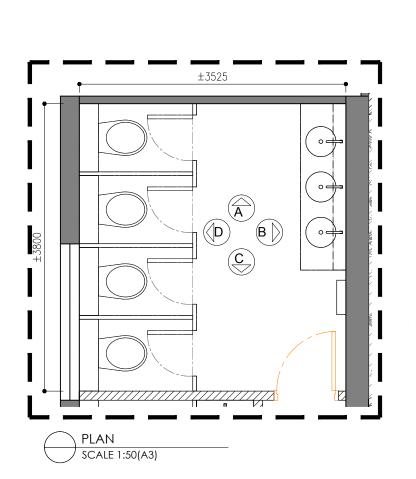

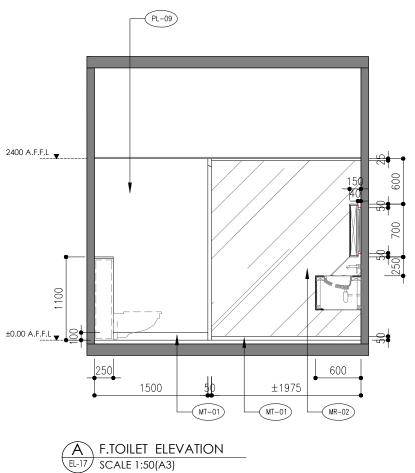

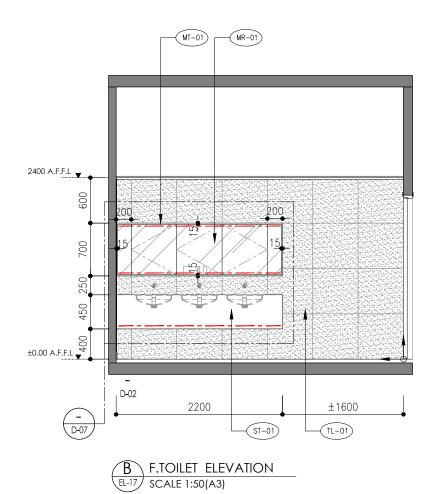

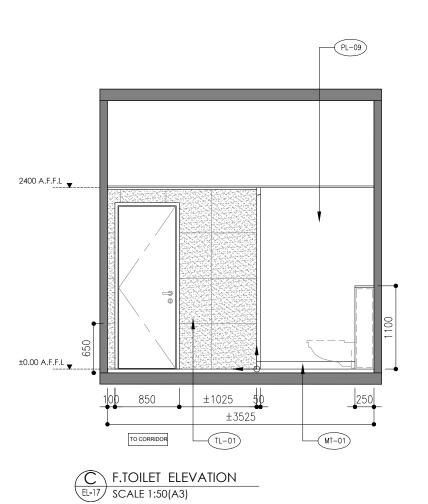

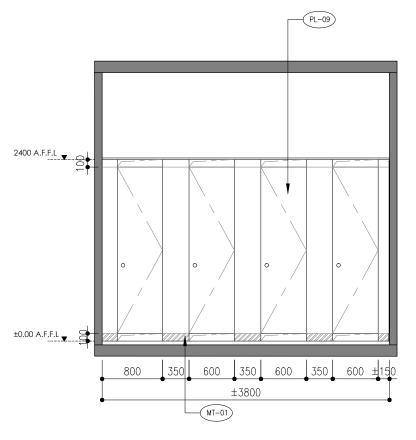

D F.TOILET ELEVATION SCALE 1:50(A3)




DATE F LIR WRITTEN
F
TED ON
TRACTOR
NY /ORK.
RRORS
OBSERVE R SHALL BE
ESULTINGS
()
04 . 2017
D BY


APPROVED BY


TENDER DRAWING


DATE	
PROJECT NO	DWG NO
APQ-17-0117	EL-17
CAD FILE REF	
Elevation (current)	-toilet+meeting room.dwg

* ALL THE SIZE NEED TO VERIFY ON SITE

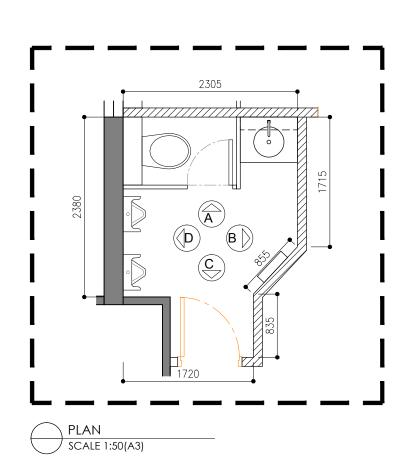

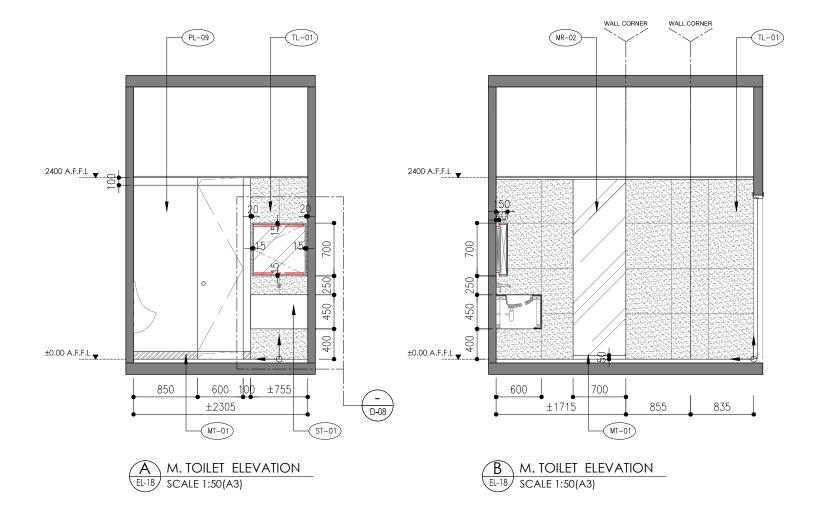

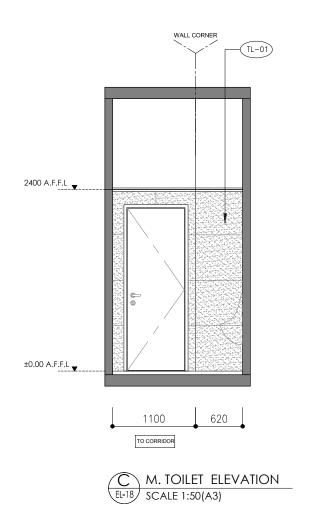

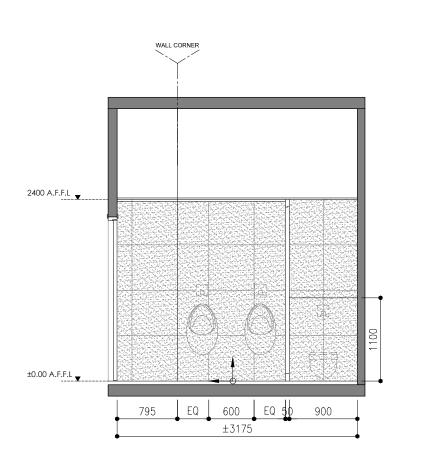

M. TOILET ELEVATION
EL-18 SCALE 1:50(A3)



REVISI	ON		
REV.	DESCRIPTION	D	Α
$\overline{\bigcirc}$			
$\overline{\bigcirc}$			
Ŏ			
$\overline{\bigcirc}$			
\bigcirc			_
			_
NOTES			
SITE B SHALL DISCRE AL DES WILL NO SHOUL THIS PI RESPO	EASUREMENT I EFORE CONST NOTIFY THE I EPANCY BEFOR IGN & ASSOCIA OT RESPONSIB D THE CONTRA ROCEDURE. TH	LE FOR ANY ERRORS ACTOR FAIL TO OBSERVE HE CONTRACTOR SHALL BE INY ERRORS RESULTINGS	
CLIENT			_
CIC	Innovation	Center (IC)	
PROJEC			
	44 Tai Yip oon Bay, I	Street Hong Kong	
DRAWIN	IG TITLE		
ELE\	/ATION OILET		
ELE\ -M. T	/ATION OILET	DATE	_
ELE\ -M. T	/ATION	DATE 26 . 04 . 2017	_
ELE\ -M. T	ATION OILET SHOWN		

APPROVED BY

PROJECT NO

APQ-17-0117

CAD FILE REF

TENDER DRAWING


DWG NO

Elevation (current)-toilet+meeting room.dwg


EL-18


* ALL THE SIZE NEED TO VERIFY ON SITE

AB-145

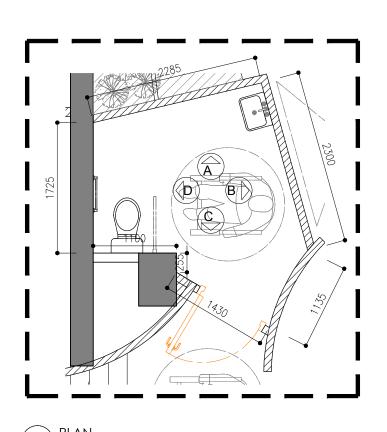

SCALE 1:50(A3)

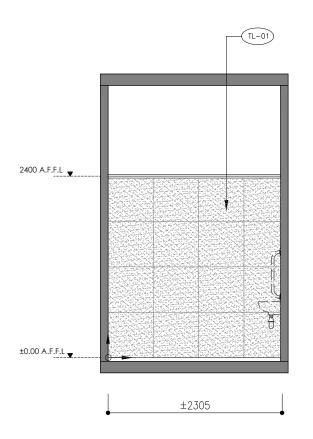


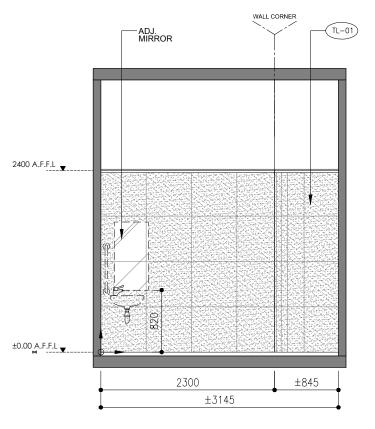

D. TOILET ELEVATION


SCALE 1:50(A3)

B D. TOILET ELEVATION
EL-19 SCALE 1:50(A3)

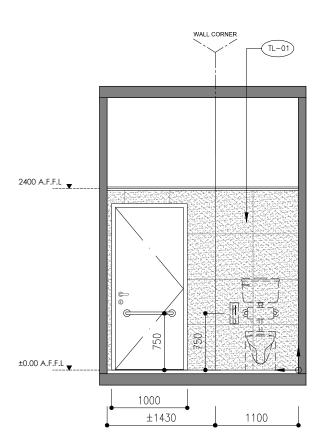

D. TOILET ELEVATION

EL-19 SCALE 1:50(A3)

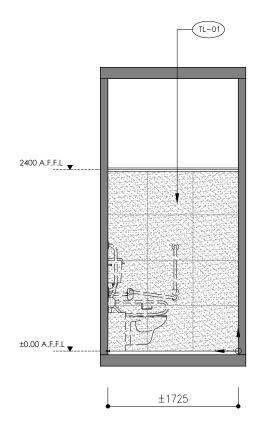

D. TOILET ELEVATION

SCALE 1:50(A3)



AL	Design
REVISION	
REV. DESCRIPTION	DATE
\bigcirc	
$\overline{\bigcirc}$	
$\tilde{\bigcirc}$	
$\overline{\bigcirc}$	
$\overline{\bigcirc}$	
$\tilde{\bigcirc}$	
$\overline{\bigcirc}$	
$\tilde{\bigcirc}$	
Ŏ	
$\overline{\bigcirc}$	
NOTES	
ALL DESIGN ARE THE P AL DESIGN & ASSOCIATES AND CANNOT BE USED W PERMISSION.	S LTD.
ALL MEASUREMENT MUSITE BEFORE CONSTRUSHALL NOTIFY THE DES DISCREPANCY BEFORE AL DESIGN & ASSOCIATE WILL NOT RESPONSIBLE SHOULD THE CONTRACT THIS PROCEDURE. THE CRESPONSIBLE FOR ANY FROM FAILURE TO DO STATE	CTION. CONTRACTOR IGNER OF ANY STARTING WORK. S LTD. FOR ANY ERRORS FOR FAIL TO OBSERVE ZONTRACTOR SHALL BE ERRORS RESULTINGS
CLIENT	
CIC Innovation C	enter (IC)
PROJECT	
G/F, 44 Tai Yip S Kowloon Bay, Ho	
DRAWING TITLE	
ELEVATION -DISABLE TOILE	Т
SCALE	DATE
AS SHOWN	26 . 04 . 2017
DRAWN BY	DESIGNED BY
IP/ SC	AY

* ALL THE SIZE NEED TO VERIFY ON SITE AB-146

CAD FILE REF
Elevation (current)-toilet+meeting room.dwg


PROJECT NO

APQ-17-0117


TENDER DRAWING


EL-19


APPROVED BY

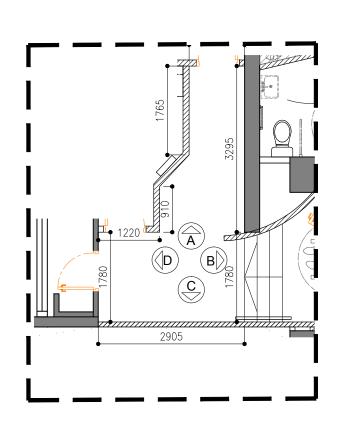

SCALE 1:75(A3)

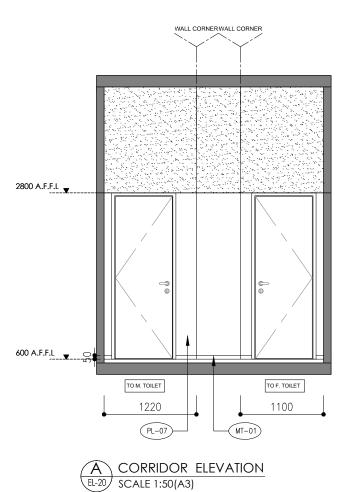

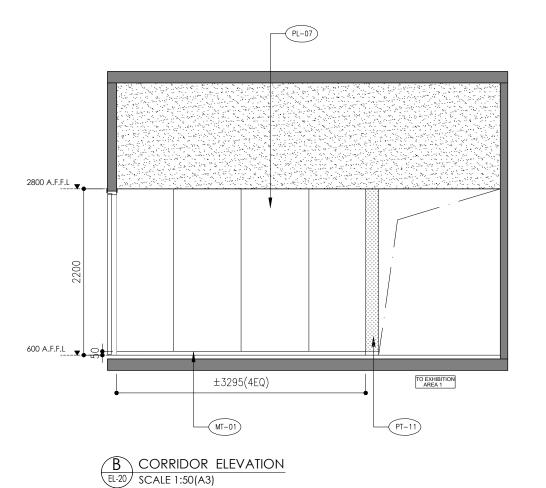

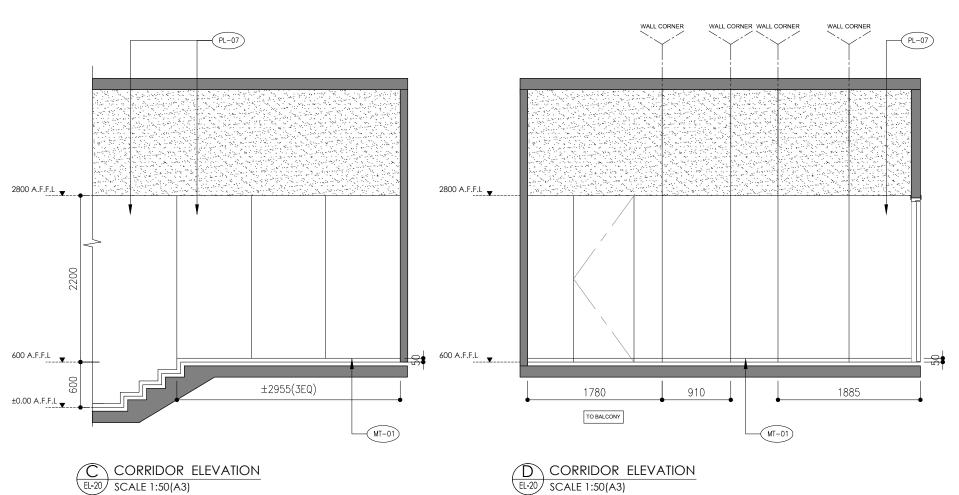

AL Design

REV. DESCRIPTION	DATE
\bigcirc	
\bigcirc	
\bigcirc	
\bigcirc	
NOTES	

ALL DESIGN ARE THE PROPERTY OF AL DESIGN & ASSOCIATES LTD. AND CANNOT BE USED WITHOUT THEIR WRITTEN PERMISSION.

ALL MEASUREMENT MUST BE VERIFIED ON SITE BEFORE CONSTRUCTION. CONTRACTOR SHALL NOTIFY THE DESIGNER OF ANY DISCREPANCY BEFORE STARTING WORK. AL DESIGN & ASSOCIATES LTD.
WILL NOT RESPONSIBLE FOR ANY ERRORS SHOULD THE CONTRACTOR FAIL TO OBSERVE THIS PROCEDURE. THE CONTRACTOR SHALL BE RESPONSIBLE FOR ANY ERRORS RESULTINGS FROM FAILURE TO DO SO.

CLIENT

CIC Innovation Center (IC)

PROJECT

G/F, 44 Tai Yip Street Kowloon Bay, Hong Kong

DRAWING TITLE

ELEVATION - CORRIDOR


SCALE	DATE
AS SHOWN	26 . 04 . 2017
DRAWN BY	DESIGNED BY
IP/ SC	AY

APPROVED


PROJECT NO DWG NO
APQ-17-0117 EL-20

CAD FILE REF

Elevation (current)-toilet+meeting room.dwg

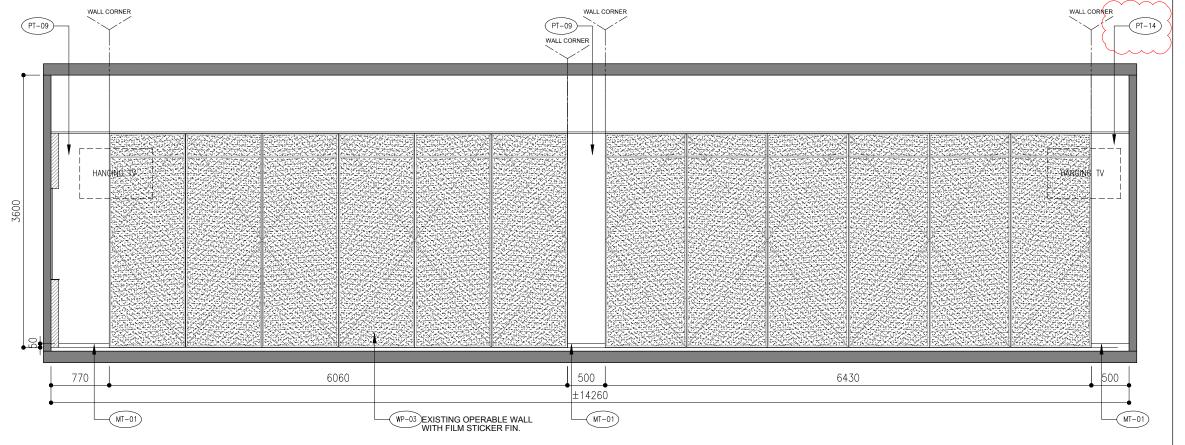

A FOCUS GROUP MEETING RM1 ELEVATION SCALE 1:50(A3)

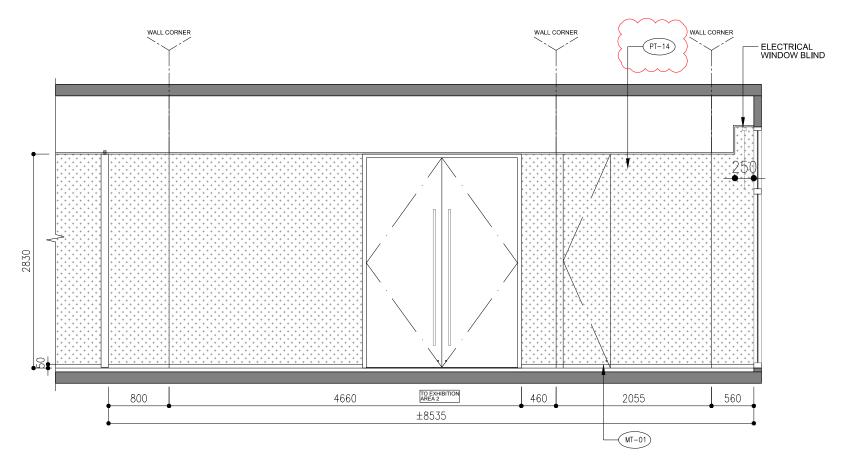

B FOCUS GROUP MEETING RM1 ELEVATION SCALE 1:50(A3)



REV.	DESCRIPTION	DATE
1	CLIENT COMMENT	11-05-2017
\bigcirc		
$\overline{\bigcirc}$		
NOTES		

ALL DESIGN ARE THE PROPERTY OF AL DESIGN & ASSOCIATES LTD. AND CANNOT BE USED WITHOUT THEIR WRITTEN PERMISSION.

ALL MEASUREMENT MUST BE VERIFIED ON SITE BEFORE CONSTRUCTION. CONTRACTOR SHALL NOTIFY THE DESIGNER OF ANY DISCREPANCY BEFORE STARTING WORK. AL DESIGN & ASSOCIATES LTD.
WILL NOT RESPONSIBLE FOR ANY ERRORS SHOULD THE CONTRACTOR FAIL TO OBSERVE THIS PROCEDURE. THE CONTRACTOR SHALL BE RESPONSIBLE FOR ANY ERRORS RESULTINGS FROM FAILURE TO DO SO.

CLIENT

CIC Innovation Center (IC)

PROJECT

G/F, 44 Tai Yip Street Kowloon Bay, Hong Kong

DRAWING TITLE


ELEVATION -FOCUS GROUP MEETING RM. 1


SCALE DATE AS SHOWN 26.04.2017 DESIGNED BY IP/ SC ΑY APPROVED BY

PROJECT NO EL-21 APQ-17-0117

CAD FILE REF

Elevation (current)-toilet+meeting room.dwg

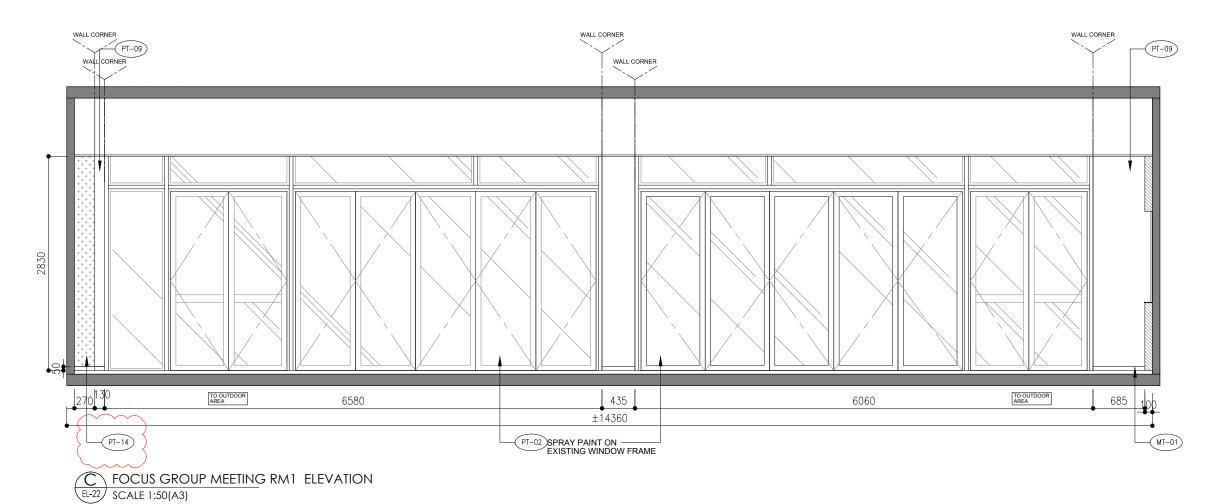

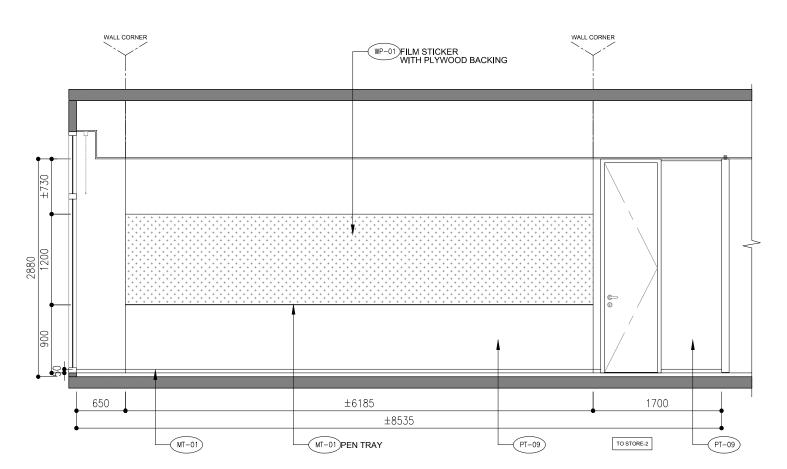

D FOCUS GROUP MEETING RM1 ELEVATION SCALE 1:50(A3)



REV.	DESCRIPTION	DATE
1	CLIENT COMMENT	11-05-201
$\overline{\bigcirc}$		
$\overline{\bigcirc}$		
$\overline{\bigcirc}$		
\bigcirc		
\bigcirc		
$\overline{\bigcirc}$		
$\overline{\bigcirc}$		
$\overline{\bigcirc}$		
$\widetilde{\bigcirc}$		
NOTES		

ALL DESIGN ARE THE PROPERTY OF AL DESIGN & ASSOCIATES LTD. AND CANNOT BE USED WITHOUT THEIR WRITTEN PERMISSION.

ALL MEASUREMENT MUST BE VERIFIED ON SITE BEFORE CONSTRUCTION. CONTRACTOR SHALL NOTIFY THE DESIGNER OF ANY DISCREPANCY BEFORE STARTING WORK.
AL DESIGN & ASSOCIATES LTD.
WILL NOT RESPONSIBLE FOR ANY ERRORS SHOULD THE CONTRACTOR FAIL TO OBSERVE THIS PROCEDURE. THE CONTRACTOR SHALL BE RESPONSIBLE FOR ANY ERRORS SHALL BE RESPONSIBLE FOR ANY ERRORS RESULTINGS FROM FAILURE TO DO SO.

CLIENT

CIC Innovation Center (IC)

PROJECT

G/F, 44 Tai Yip Street Kowloon Bay, Hong Kong

DRAWING TITLE

ELEVATION -FOCUS GROUP MEETING RM. 1

 SCALE
 DATE

 AS SHOWN
 26 . 04 . 2017

 DRAWN BY
 DESIGNED BY

 IP/ SC
 AY

APPROVED BY


7.1.110125

PROJECT NO DWG NO


APQ-17-0117 EL-22

CAD FILE REF

Elevation (current)-toilet+meeting room.dwg

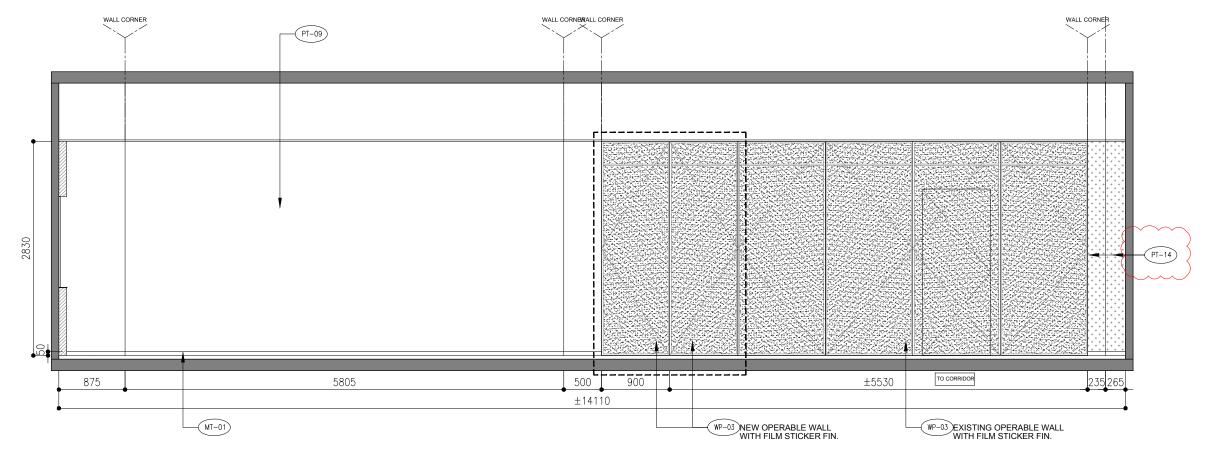

A FOCUS GROUP MEETING RM2 ELEVATION SCALE 1:50(A3)

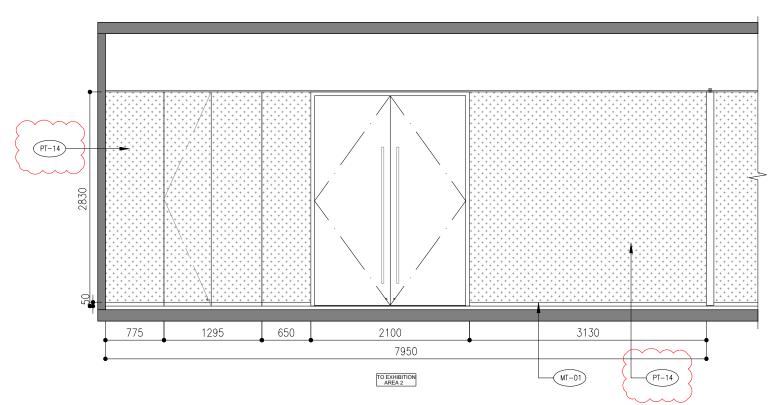

B FOCUS GROUP MEETING RM2 ELEVATION SCALE 1:50(A3)



REV.	DESCRIPTION	DATE
1	CLIENT COMMENT	11-05-20
$\overline{\bigcirc}$		
$\overline{\bigcirc}$		
\bigcirc		
\bigcirc		
\bigcirc		
$\overline{\bigcirc}$		
NOTES		

ALL DESIGN ARE THE PROPERTY OF AL DESIGN & ASSOCIATES LTD. AND CANNOT BE USED WITHOUT THEIR WRITTEN PERMISSION.

ALL MEASUREMENT MUST BE VERIFIED ON SITE BEFORE CONSTRUCTION. CONTRACTOR SHALL NOTIFY THE DESIGNER OF ANY DISCREPANCY BEFORE STARTING WORK. AL DESIGN & ASSOCIATES LTD.
WILL NOT RESPONSIBLE FOR ANY ERRORS SHOULD THE CONTRACTOR FAIL TO OBSERVE THIS PROCEDURE. THE CONTRACTOR SHALL BE RESPONSIBLE FOR ANY ERRORS SHALL BE RESPONSIBLE FOR ANY ERRORS RESULTINGS FROM FAILURE TO DO SO.

CLIENT

CIC Innovation Center (IC)

PROJECT

G/F, 44 Tai Yip Street Kowloon Bay, Hong Kong

DRAWING TITLE

ELEVATION -FOCUS GROUP MEETING RM 2

 SCALE
 DATE

 AS SHOWN
 26 . 04 . 2017

 DRAWN BY
 DESIGNED BY

 IP/ SC
 AY


APPROVED BY

PROJECT NO DWG NO


APQ-17-0117 EL-23

CAD FILE REF

Elevation (current)-toilet+meeting room.dwg

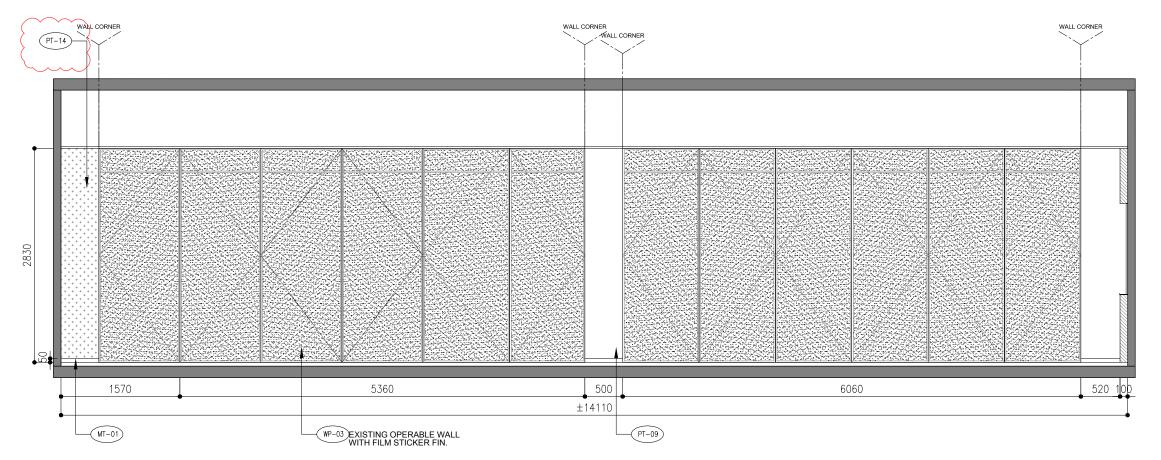


C FOCUS GROUP MEETING RM2 ELEVATION SCALE 1:50(A3)

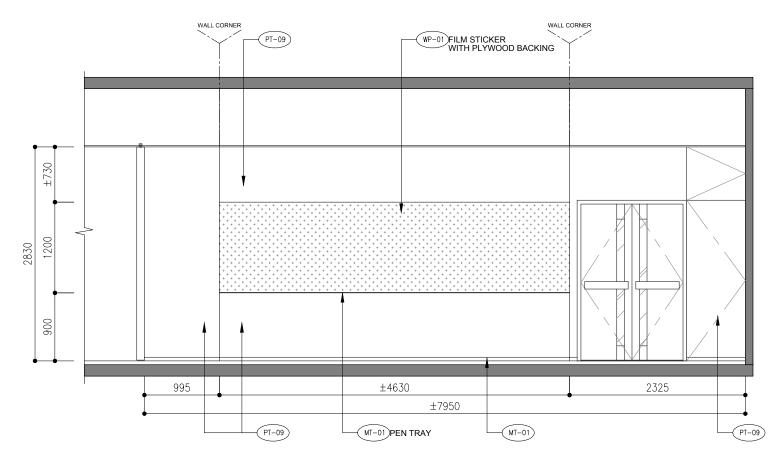



FOCUS GROUP MEETING RM2 ELEVATION SCALE 1:50(A3)




	AL	Desig	
REV.	DESCRIPTION		DATE
<u>(1)</u>	CLIENT COMME	NT	11-05-20
$\widetilde{\cap}$			
$\stackrel{\smile}{\sim}$			
$\stackrel{\smile}{\sim}$			
\bigcirc			
\bigcirc			
\bigcirc			
$\overline{\bigcirc}$			
$\check{\cap}$			
$\widetilde{\wedge}$			
\approx			
\bigcup			
NOTES			
WILL NO SHOULI THIS PE RESPOI	IGN & ASSOCIATE OT RESPONSIBLE D THE CONTRACE ROCEDURE. THE NSIBLE FOR ANY FAILURE TO DO	FOR ANY EFTOR FAIL TO CONTRACTOR FERRORS RE	OBSERVE SHALL BE
CLC	Innovation (Contor (IC	`
CICI	nnovation (Jenler (IC)
PROJEC	Т		
	44 Tai Yip S oon Bay, Ho		
DRAWIN	G TITLE		
ELEV FOC	/ATION SUS GROU	P MEETIN	IG RM 2
SCALE AS S	HOWN	DATE 26.0	4 . 2017
DRAWN	BY	DESIGNE	D BY
IP/ S		AY	
APPROV	/ED BY		
DATE PROJEC	T NO	DWG NO	
	-17-0117		EL-24
CAD FILE			
	tion (current)	-toilet: most	ting room dus

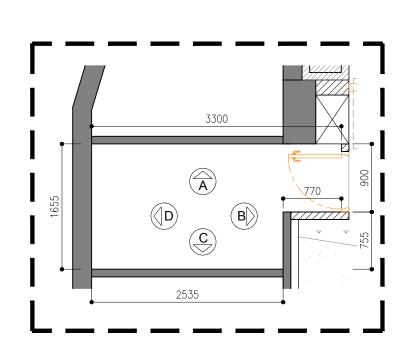

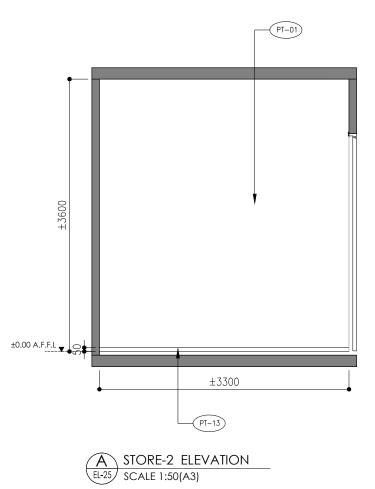


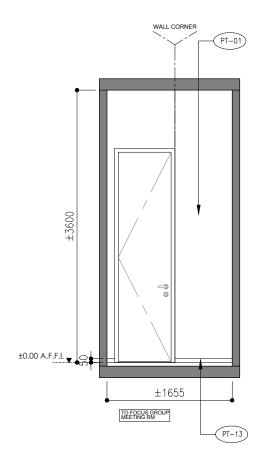

B STORE-2 ELEVATION SCALE 1:50(A3)

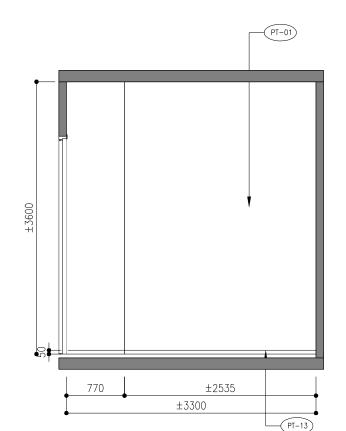

STORE-2 ELEVATION
EL-25 SCALE 1:50(A3)

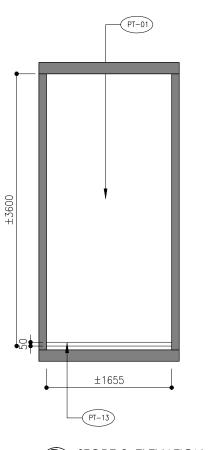

D STORE-2 ELEVATION EL-25 SCALE 1:50(A3)



REVISIO		
REV.	DESCRIPTION	DATE
\bigcirc		
\bigcirc		
$\overline{\bigcirc}$		
$\check{\cap}$		
$\widetilde{\frown}$		
$\stackrel{\smile}{\sim}$		
$\stackrel{\smile}{\sim}$		
\subseteq		
<u> </u>		
\bigcirc		
\bigcirc		
NOTES		
	SIGN ARE THE PROPERTY	OF
	GN & ASSOCIATES LTD. NNOT BE USED WITHOUT T SION.	THEIR WRITTEN
	ASUREMENT MUST BE VE	
SHALL	FORE CONSTRUCTION. C NOTIFY THE DESIGNER O	F ANY
	PANCY BEFORE STARTING GN & ASSOCIATES LTD.	WORK.
WILL NO	OT RESPONSIBLE FOR ANY	
	OCEDURE. THE CONTRAC	

RESPONSIBLE FOR ANY ERRORS RESULTINGS FROM FAILURE TO DO SO.

CLIENT

CIC Innovation Center (IC)

PROJECT

G/F, 44 Tai Yip Street Kowloon Bay, Hong Kong

DRAWING TITLE

ELEVATION - STORE-2

SCALE	DATE
AS SHOWN	26 . 04 . 2017
DRAWN BY	DESIGNED BY
IP/ SC	AY


APPROVED BY

PROJECT NO EL-25 APQ-17-0117 CAD FILE REF


Elevation (current)-toilet+meeting room.dwg

TENDER DRAWING

PLAN SCALE 1:50(A3)

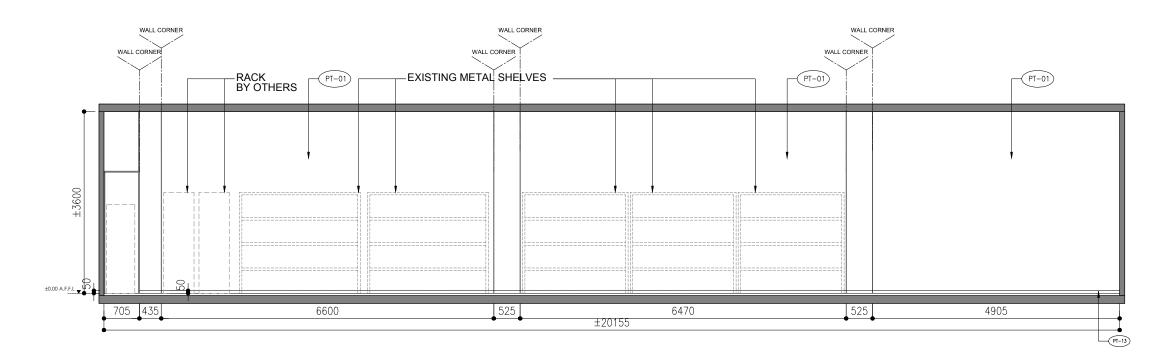



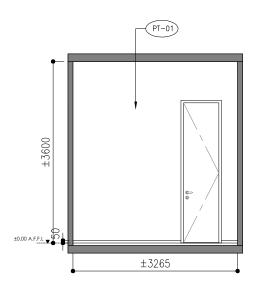




REVISION		
REV. DESCRIPTION		DATE
\supset		
$\overline{)}$		
\leq		
\leq		
		
<u> </u>		
\supset		
$\overline{)}$		
5		
<u> </u>		
OTES		
DESIGN & ASSOCIA ILL NOT RESPONSIB HOULD THE CONTR. IIS PROCEDURE. TH	LE FOR ANY ERRO ACTOR FAIL TO OU HE CONTRACTOR S NNY ERRORS RESU	ORS BSERVE HALL BE
LIENT		
IC Innovation	Center (IC)	
ROJECT		
/F, 44 Tai Yip owloon Bay, I		
NAWING TITLE		
RAWING TITLE LEVATION BOH		
LEVATION	DATE	
LEVATION BOH	DATE 26 . 04	. 2017
LEVATION BOH FALE AS SHOWN		
LEVATION BOH TALE AS SHOWN	26 . 04	
LEVATION BOH CALE AS SHOWN TAWM BY P/ SC	26 . 04	
LEVATION BOH	26 . 04	
LEVATION BOH VALE AS SHOWN VALE VALE	26 . 04	
LEVATION BOH AS SHOWN NAWN BY P/ SC PPROVED BY	26 . 04 DESIGNED B AY	
LEVATION BOH CALE AS SHOWN TAWM BY P/ SC	26 . 04 DESIGNED B AY	


CAD FILE REF

TENDER DRAWING

Elevation (current)-toilet+meeting room.dwg

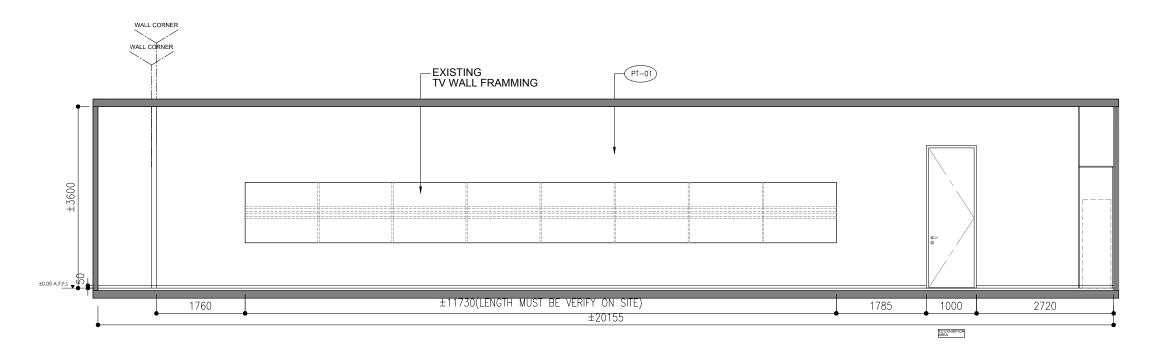



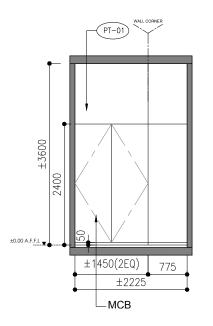


BOH ELEVATION

EL-27 SCALE 1:75(A3)

AL Design

LL DESIGN ARE THE PROPERTY OF L DESIGN ASSOCIATES LTD. ND CANNOT BE USED WITHOUT THEIR WRITTEN ERMISSION. LLI MEASUREMENT MUST BE VERIFIED ON ITE BEFORE CONSTRUCTION, CONTRACTOR HALL NOTIFY THE DESIGNER OF ANY ISCREPANCY BEFORE STARTING WORK. L DESIGN & ASSOCIATES LTD. VILL NOT RESPONSIBLE FOR ANY ERRORS HOULD THE CONTRACTOR FAIL TO OBSERVE HIS PROCEDURE. THE CONTRACTOR SHALL BE ESPONSIBLE FOR ANY ERRORS RESULTINGS ROM FAILURE TO DO SO. LIENT CIC Innovation Center (IC) ROJECT 6/F, 44 Tai Yip Street Cowloon Bay, Hong Kong RAWING TITLE ELEVATION BOH CALE DATE AS SHOWN 26.04.2017 RAWN BY DESIGNED BY IP/ SC AY PPROVED BY	REV. DESCRIPTION	DATE
LL DESIGN ARE THE PROPERTY OF L DESIGN & ASSOCIATES LTD. ND CANNOT BE USED WITHOUT THEIR WRITTEN ERMISSION. LL MEASUREMENT MUST BE VERIFIED ON ITTE BEFORE CONSTRUCTION, CONTRACTOR HALL NOTIFY THE DESIGNER OF ANY ISCREPANCY BEFORE STARTING WORK. L DESIGN & ASSOCIATES LTD. VILL NOT RESPONSIBLE FOR ANY ERRORS HOULD THE CONTRACTOR FAIL TO OBSERVE HIS PROCEDURE. THE CONTRACTOR SHALL BE ESPONSIBLE FOR ANY ERRORS RESULTINGS ROM FAILURE TO DO SO. LIENT CIC Innovation Center (IC) ROJECT 6/F, 44 Tai Yip Street COWIOON Bay, Hong Kong RAWING TITLE ELEVATION BOH CALE AS SHOWN DESIGNED BY IP/ SC AY PPROVED BY ATE ROJECT OD DWG NO APQ-17-0117 EL-27	$\overline{}$	
LL DESIGN ARE THE PROPERTY OF L DESIGN & ASSOCIATES LTD. ND CANNOT BE USED WITHOUT THEIR WRITTEN ERMISSION. LL MEASUREMENT MUST BE VERIFIED ON ITTE BEFORE CONSTRUCTION, CONTRACTOR HALL NOTIFY THE DESIGNER OF ANY ISCREPANCY BEFORE STARTING WORK. L DESIGN & ASSOCIATES LTD. VILL NOT RESPONSIBLE FOR ANY ERRORS HOULD THE CONTRACTOR FAIL TO OBSERVE HIS PROCEDURE. THE CONTRACTOR SHALL BE ESPONSIBLE FOR ANY ERRORS RESULTINGS ROM FAILURE TO DO SO. LIENT CIC Innovation Center (IC) ROJECT 6/F, 44 Tai Yip Street COWIOON Bay, Hong Kong RAWING TITLE ELEVATION BOH CALE AS SHOWN DESIGNED BY IP/ SC AY PPROVED BY ATE ROJECT OD DWG NO APQ-17-0117 EL-27	\preceq	
LL DESIGN ARE THE PROPERTY OF L DESIGN & ASSOCIATES LTD. ND CANNOT BE USED WITHOUT THEIR WRITTEN ERMISSION. LL MEASUREMENT MUST BE VERIFIED ON ITE BEFORE CONSTRUCTION, CONTRACTOR HALL NOTIFY THE DESIGNER OF ANY ISCREPANCY BEFORE STARTING WORK. L DESIGN & ASSOCIATES LTD. NILL NOT RESPONSIBLE FOR ANY ERRORS HOULD THE CONTRACTOR FAIL TO OBSERVE HIS PROCEDURE. THE CONTRACTOR SHALL BE ESPONSIBLE FOR ANY ERRORS RESULTINGS ROM FAILURE TO DO SO. LIENT CIC Innovation Center (IC) ROJECT SIF, 44 Tai Yip Street COWIOON Bay, Hong Kong RAWING TITLE SLEVATION BOH CALE DATE AS SHOWN 26.04.2017 RAWN BY DESIGNED BY IP/ SC AY PPROVED BY ATE ROJECT OD DWG NO APQ-17-0117 EL-27	\supseteq	
LL DESIGN ARE THE PROPERTY OF L DESIGN & ASSOCIATES LTD. ND CANNOT BE USED WITHOUT THEIR WRITTEN ERMISSION. LL MEASUREMENT MUST BE VERIFIED ON ITTE BEFORE CONSTRUCTION, CONTRACTOR HALL NOTIFY THE DESIGNER OF ANY ISCREPANCY BEFORE STARTING WORK. L DESIGN & ASSOCIATES LTD. VILL NOT RESPONSIBLE FOR ANY ERRORS HOULD THE CONTRACTOR FAIL TO OBSERVE HIS PROCEDURE. THE CONTRACTOR SHALL BE ESPONSIBLE FOR ANY ERRORS RESULTINGS ROM FAILURE TO DO SO. LIENT CIC Innovation Center (IC) ROJECT 6/F, 44 Tai Yip Street COWIOON Bay, Hong Kong RAWING TITLE ELEVATION BOH CALE AS SHOWN DESIGNED BY IP/ SC AY PPROVED BY ATE ROJECT OD DWG NO APQ-17-0117 EL-27	\bigcirc	
LL DESIGN ARE THE PROPERTY OF L DESIGN & ASSOCIATES LTD. ND CANNOT BE USED WITHOUT THEIR WRITTEN ERMISSION. LL MEASUREMENT MUST BE VERIFIED ON ITTE BEFORE CONSTRUCTION, CONTRACTOR HALL NOTIFY THE DESIGNER OF ANY ISCREPANCY BEFORE STARTING WORK. L DESIGN & ASSOCIATES LTD. VILL NOT RESPONSIBLE FOR ANY ERRORS HOULD THE CONTRACTOR FAIL TO OBSERVE HIS PROCEDURE. THE CONTRACTOR SHALL BE ESPONSIBLE FOR ANY ERRORS RESULTINGS ROM FAILURE TO DO SO. LIENT CIC Innovation Center (IC) ROJECT 6/F, 44 Tai Yip Street COWIOON Bay, Hong Kong RAWING TITLE ELEVATION BOH CALE AS SHOWN DESIGNED BY IP/ SC AY PPROVED BY ATE ROJECT OD DWG NO APQ-17-0117 EL-27	\bigcirc	
LL DESIGN ARE THE PROPERTY OF L DESIGN & ASSOCIATES LTD. ND CANNOT BE USED WITHOUT THEIR WRITTEN ERMISSION. LL MEASUREMENT MUST BE VERIFIED ON ITTE BEFORE CONSTRUCTION, CONTRACTOR HALL NOTIFY THE DESIGNER OF ANY ISCREPANCY BEFORE STARTING WORK. L DESIGN & ASSOCIATES LTD. VILL NOT RESPONSIBLE FOR ANY ERRORS HOULD THE CONTRACTOR FAIL TO OBSERVE HIS PROCEDURE. THE CONTRACTOR SHALL BE ESPONSIBLE FOR ANY ERRORS RESULTINGS ROM FAILURE TO DO SO. LIENT CIC Innovation Center (IC) ROJECT 6/F, 44 Tai Yip Street COWIOON Bay, Hong Kong RAWING TITLE ELEVATION BOH CALE AS SHOWN DESIGNED BY IP/ SC AY PPROVED BY ATE ROJECT OD DWG NO APQ-17-0117 EL-27		
LL DESIGN ARE THE PROPERTY OF L DESIGN & ASSOCIATES LTD. ND CANNOT BE USED WITHOUT THEIR WRITTEN ERMISSION. LL MEASUREMENT MUST BE VERIFIED ON ITTE BEFORE CONSTRUCTION, CONTRACTOR HALL NOTIFY THE DESIGNER OF ANY ISCREPANCY BEFORE STARTING WORK. L DESIGN & ASSOCIATES LTD. VILL NOT RESPONSIBLE FOR ANY ERRORS HOULD THE CONTRACTOR FAIL TO OBSERVE HIS PROCEDURE. THE CONTRACTOR SHALL BE ESPONSIBLE FOR ANY ERRORS RESULTINGS ROM FAILURE TO DO SO. LIENT CIC Innovation Center (IC) ROJECT 6/F, 44 Tai Yip Street COWIOON Bay, Hong Kong RAWING TITLE ELEVATION BOH CALE AS SHOWN DESIGNED BY IP/ SC AY PPROVED BY ATE ROJECT OD DWG NO APQ-17-0117 EL-27		
LL DESIGN ARE THE PROPERTY OF L DESIGN & ASSOCIATES LTD. ND CANNOT BE USED WITHOUT THEIR WRITTEN ERMISSION. LL MEASUREMENT MUST BE VERIFIED ON ITTE BEFORE CONSTRUCTION, CONTRACTOR HALL NOTIFY THE DESIGNER OF ANY ISCREPANCY BEFORE STARTING WORK. L DESIGN & ASSOCIATES LTD. VILL NOT RESPONSIBLE FOR ANY ERRORS HOULD THE CONTRACTOR FAIL TO OBSERVE HIS PROCEDURE. THE CONTRACTOR SHALL BE ESPONSIBLE FOR ANY ERRORS RESULTINGS ROM FAILURE TO DO SO. LIENT CIC Innovation Center (IC) ROJECT 6/F, 44 Tai Yip Street COWIOON Bay, Hong Kong RAWING TITLE ELEVATION BOH CALE AS SHOWN DESIGNED BY IP/ SC AY PPROVED BY ATE ROJECT OD DWG NO APQ-17-0117 EL-27	\preceq	
LL DESIGN ARE THE PROPERTY OF L DESIGN & ASSOCIATES LTD. ND CANNOT BE USED WITHOUT THEIR WRITTEN ERMISSION. LL MEASUREMENT MUST BE VERIFIED ON ITTE BEFORE CONSTRUCTION, CONTRACTOR HALL NOTIFY THE DESIGNER OF ANY ISCREPANCY BEFORE STARTING WORK. L DESIGN & ASSOCIATES LTD. VILL NOT RESPONSIBLE FOR ANY ERRORS HOULD THE CONTRACTOR FAIL TO OBSERVE HIS PROCEDURE. THE CONTRACTOR SHALL BE ESPONSIBLE FOR ANY ERRORS RESULTINGS ROM FAILURE TO DO SO. LIENT CIC Innovation Center (IC) ROJECT 6/F, 44 Tai Yip Street COWIOON Bay, Hong Kong RAWING TITLE ELEVATION BOH CALE AS SHOWN DESIGNED BY IP/ SC AY PPROVED BY ATE ROJECT OD DWG NO APQ-17-0117 EL-27	\preceq	
LL DESIGN ARE THE PROPERTY OF L DESIGN & ASSOCIATES LTD. ND CANNOT BE USED WITHOUT THEIR WRITTEN ERMISSION. LL MEASUREMENT MUST BE VERIFIED ON ITTE BEFORE CONSTRUCTION, CONTRACTOR HALL NOTIFY THE DESIGNER OF ANY ISCREPANCY BEFORE STARTING WORK. L DESIGN & ASSOCIATES LTD. VILL NOT RESPONSIBLE FOR ANY ERRORS HOULD THE CONTRACTOR FAIL TO OBSERVE HIS PROCEDURE. THE CONTRACTOR SHALL BE ESPONSIBLE FOR ANY ERRORS RESULTINGS ROM FAILURE TO DO SO. LIENT CIC Innovation Center (IC) ROJECT 6/F, 44 Tai Yip Street COWIOON Bay, Hong Kong RAWING TITLE ELEVATION BOH CALE AS SHOWN DESIGNED BY IP/ SC AY PPROVED BY ATE ROJECT OD DWG NO APQ-17-0117 EL-27	\supseteq	
LL DESIGN ARE THE PROPERTY OF L DESIGN & ASSOCIATES LTD. ND CANNOT BE USED WITHOUT THEIR WRITTEN ERMISSION. LL MEASUREMENT MUST BE VERIFIED ON ITTE BEFORE CONSTRUCTION, CONTRACTOR HALL NOTIFY THE DESIGNER OF ANY ISCREPANCY BEFORE STARTING WORK. L DESIGN & ASSOCIATES LTD. VILL NOT RESPONSIBLE FOR ANY ERRORS HOULD THE CONTRACTOR FAIL TO OBSERVE HIS PROCEDURE. THE CONTRACTOR SHALL BE ESPONSIBLE FOR ANY ERRORS RESULTINGS ROM FAILURE TO DO SO. LIENT CIC Innovation Center (IC) ROJECT 6/F, 44 Tai Yip Street COWIOON Bay, Hong Kong RAWING TITLE ELEVATION BOH CALE AS SHOWN DESIGNED BY IP/ SC AY PPROVED BY ATE ROJECT OD DWG NO APQ-17-0117 EL-27	\bigcirc	
LL DESIGN ARE THE PROPERTY OF L DESIGN & ASSOCIATES LTD. ND CANNOT BE USED WITHOUT THEIR WRITTEN ERMISSION. LL MEASUREMENT MUST BE VERIFIED ON ITTE BEFORE CONSTRUCTION, CONTRACTOR HALL NOTIFY THE DESIGNER OF ANY ISCREPANCY BEFORE STARTING WORK. L DESIGN & ASSOCIATES LTD. VILL NOT RESPONSIBLE FOR ANY ERRORS HOULD THE CONTRACTOR FAIL TO OBSERVE HIS PROCEDURE. THE CONTRACTOR SHALL BE ESPONSIBLE FOR ANY ERRORS RESULTINGS ROM FAILURE TO DO SO. LIENT CIC Innovation Center (IC) ROJECT 6/F, 44 Tai Yip Street COWIOON Bay, Hong Kong RAWING TITLE ELEVATION BOH CALE AS SHOWN DESIGNED BY IP/ SC AY PPROVED BY ATE ROJECT OD DWG NO APQ-17-0117 EL-27	\bigcirc	
LL DESIGN ARE THE PROPERTY OF L DESIGN & ASSOCIATES LTD. ND CANNOT BE USED WITHOUT THEIR WRITTEN ERMISSION. LL MEASUREMENT MUST BE VERIFIED ON ITE BEFORE CONSTRUCTION, CONTRACTOR HALL NOTIFY THE DESIGNER OF ANY ISCREPANCY BEFORE STARTING WORK. L DESIGN & ASSOCIATES LTD. NILL NOT RESPONSIBLE FOR ANY ERRORS HOULD THE CONTRACTOR FAIL TO OBSERVE HIS PROCEDURE. THE CONTRACTOR SHALL BE ESPONSIBLE FOR ANY ERRORS RESULTINGS ROM FAILURE TO DO SO. LIENT CIC Innovation Center (IC) ROJECT SIF, 44 Tai Yip Street COWIOON Bay, Hong Kong RAWING TITLE SLEVATION BOH CALE DATE AS SHOWN 26.04.2017 RAWN BY DESIGNED BY IP/ SC AY PPROVED BY ATE ROJECT OD DWG NO APQ-17-0117 EL-27	OTES	
L DESIGN & ASSOCIATES LTD. ND CANNOT BE USED WITHOUT THEIR WRITTEN ERMISSION. LL MEASUREMENT MUST BE VERIFIED ON ITE BEFORE CONSTRUCTION. CONTRACTOR HALL NOTIFY THE DESIGNER OF ANY ISCREPANCY BEFORE STARTING WORK. L DESIGN & ASSOCIATES LTD. VILL NOT RESPONSIBLE FOR ANY ERRORS HOULD THE CONTRACTOR FAIL TO OBSERVE HIS PROCEDURE. THE CONTRACTOR SHALL BE ESPONSIBLE FOR ANY ERRORS RESULTINGS ROM FAILURE TO DO SO. LIENT CIC Innovation Center (IC) ROJECT G/F, 44 Tai Yip Street Cowloon Bay, Hong Kong RAWING TITLE ELEVATION BOH CALE AS SHOWN 26.04.2017 RAWN BY DESIGNED BY IP/SC AY PPROVED BY ATE ROJECT NO DWG NO APQ-17-0117 EL-27		
L DESIGN & ASSOCIATES LTD. ND CANNOT BE USED WITHOUT THEIR WRITTEN ERMISSION. LL MEASUREMENT MUST BE VERIFIED ON ITE BEFORE CONSTRUCTION. CONTRACTOR HALL NOTIFY THE DESIGNER OF ANY ISCREPANCY BEFORE STARTING WORK. L DESIGN & ASSOCIATES LTD. VILL NOT RESPONSIBLE FOR ANY ERRORS HOULD THE CONTRACTOR FAIL TO OBSERVE HIS PROCEDURE. THE CONTRACTOR SHALL BE ESPONSIBLE FOR ANY ERRORS RESULTINGS ROM FAILURE TO DO SO. LIENT CIC Innovation Center (IC) ROJECT G/F, 44 Tai Yip Street Cowloon Bay, Hong Kong RAWING TITLE ELEVATION BOH CALE AS SHOWN 26.04.2017 RAWN BY DESIGNED BY IP/SC AY PPROVED BY ATE ROJECT NO DWG NO APQ-17-0117 EL-27		
L DESIGN & ASSOCIATES LTD. ND CANNOT BE USED WITHOUT THEIR WRITTEN ERMISSION. LL MEASUREMENT MUST BE VERIFIED ON ITE BEFORE CONSTRUCTION. CONTRACTOR HALL NOTIFY THE DESIGNER OF ANY ISCREPANCY BEFORE STARTING WORK. L DESIGN & ASSOCIATES LTD. VILL NOT RESPONSIBLE FOR ANY ERRORS HOULD THE CONTRACTOR FAIL TO OBSERVE HIS PROCEDURE. THE CONTRACTOR SHALL BE ESPONSIBLE FOR ANY ERRORS RESULTINGS ROM FAILURE TO DO SO. LIENT CIC Innovation Center (IC) ROJECT G/F, 44 Tai Yip Street Cowloon Bay, Hong Kong RAWING TITLE ELEVATION BOH CALE AS SHOWN 26.04.2017 RAWN BY DESIGNED BY IP/SC AY PPROVED BY ATE ROJECT NO DWG NO APQ-17-0117 EL-27		
L DESIGN & ASSOCIATES LTD. ND CANNOT BE USED WITHOUT THEIR WRITTEN ERMISSION. LL MEASUREMENT MUST BE VERIFIED ON ITE BEFORE CONSTRUCTION. CONTRACTOR HALL NOTIFY THE DESIGNER OF ANY ISCREPANCY BEFORE STARTING WORK. L DESIGN & ASSOCIATES LTD. VILL NOT RESPONSIBLE FOR ANY ERRORS HOULD THE CONTRACTOR FAIL TO OBSERVE HIS PROCEDURE. THE CONTRACTOR SHALL BE ESPONSIBLE FOR ANY ERRORS RESULTINGS ROM FAILURE TO DO SO. LIENT CIC Innovation Center (IC) ROJECT G/F, 44 Tai Yip Street Cowloon Bay, Hong Kong RAWING TITLE ELEVATION BOH CALE AS SHOWN 26.04.2017 RAWN BY DESIGNED BY IP/SC AY PPROVED BY ATE ROJECT NO DWG NO APQ-17-0117 EL-27		
L DESIGN & ASSOCIATES LTD. ND CANNOT BE USED WITHOUT THEIR WRITTEN ERMISSION. LL MEASUREMENT MUST BE VERIFIED ON ITE BEFORE CONSTRUCTION. CONTRACTOR HALL NOTIFY THE DESIGNER OF ANY ISCREPANCY BEFORE STARTING WORK. L DESIGN & ASSOCIATES LTD. VILL NOT RESPONSIBLE FOR ANY ERRORS HOULD THE CONTRACTOR FAIL TO OBSERVE HIS PROCEDURE. THE CONTRACTOR SHALL BE ESPONSIBLE FOR ANY ERRORS RESULTINGS ROM FAILURE TO DO SO. LIENT CIC Innovation Center (IC) ROJECT G/F, 44 Tai Yip Street Cowloon Bay, Hong Kong RAWING TITLE ELEVATION BOH CALE AS SHOWN 26.04.2017 RAWN BY DESIGNED BY IP/SC AY PPROVED BY ATE ROJECT NO DWG NO APQ-17-0117 EL-27		
L DESIGN & ASSOCIATES LTD. ND CANNOT BE USED WITHOUT THEIR WRITTEN ERMISSION. LL MEASUREMENT MUST BE VERIFIED ON ITE BEFORE CONSTRUCTION. CONTRACTOR HALL NOTIFY THE DESIGNER OF ANY ISCREPANCY BEFORE STARTING WORK. L DESIGN & ASSOCIATES LTD. VILL NOT RESPONSIBLE FOR ANY ERRORS HOULD THE CONTRACTOR FAIL TO OBSERVE HIS PROCEDURE. THE CONTRACTOR SHALL BE ESPONSIBLE FOR ANY ERRORS RESULTINGS ROM FAILURE TO DO SO. LIENT CIC Innovation Center (IC) ROJECT G/F, 44 Tai Yip Street Cowloon Bay, Hong Kong RAWING TITLE ELEVATION BOH CALE AS SHOWN 26.04.2017 RAWN BY DESIGNED BY IP/SC AY PPROVED BY ATE ROJECT NO DWG NO APQ-17-0117 EL-27		
CIC Innovation Center (IC) ROJECT 6/F, 44 Tai Yip Street Cowloon Bay, Hong Kong RAWING TITLE ELEVATION BOH CALE DATE AS SHOWN 26.04.2017 RAWN BY DESIGNED BY IP/ SC AY PPROVED BY ATE ROJECT NO DWG NO APQ-17-0117 EL-27	HALL NOTIFY THE D	DESIGNER OF ANY
ROJECT 6/F, 44 Tai Yip Street Cowloon Bay, Hong Kong RAWING TITLE ELEVATION BOH CALE DATE AS SHOWN 26 . 04 . 2017 RAWN BY DESIGNED BY IP/ SC AY PPROVED BY ATE ROJECT NO DWG NO APQ-17-0117 EL-27	SHALL NOTIFY THE DISCREPANCY BEFOR AL DESIGN & ASSOCIA WILL NOT RESPONSIB SHOULD THE CONTRA THIS PROCEDURE. TH RESPONSIBLE FOR A	DESIGNER OF ANY RE STARTING WORK. ITES LTD. LE FOR ANY ERRORS ACTOR FAIL TO OBSERVE HE CONTRACTOR SHALL BE LINY ERRORS RESULTINGS
S/F, 44 Tai Yip Street Cowloon Bay, Hong Kong RAWING TITLE SLEVATION BOH CALE DATE AS SHOWN 26 . 04 . 2017 RAWN BY DESIGNED BY IP/ SC AY PPROVED BY ATE ROJECT NO DWG NO APQ-17-0117 EL-27	SHALL NOTIFY THE LE DISCREPANCY BEFORE AL DESIGN & ASSOCIA WILL NOT RESPONSIB SHOULD THE CONTR. THIS PROCEDURE. THE SPONSIBLE FOR A FROM FAILURE TO D	DESIGNER OF ANY RE STARTING WORK. ITES LTD. LE FOR ANY ERRORS ACTOR FAIL TO OBSERVE HE CONTRACTOR SHALL BE INY ERRORS RESULTINGS TO SO.
Cowloon Bay, Hong Kong RAWING TITLE ELEVATION BOH GALE DATE AS SHOWN 26 . 04 . 2017 RAWN BY DESIGNED BY IP/ SC AY PPROVED BY ATE ROJECT NO DWG NO APQ-17-0117 EL-27	SHALL NOTIFY THE LE PISCREPANCY BEFORE LE DESIGN & ASSOCIA WILL NOT RESPONSIB SHOULD THE CONTR. HIS PROCEDURE. THE SESPONSIBLE FOR A ROM FAILURE TO D	DESIGNER OF ANY RE STARTING WORK. ITES LTD. LE FOR ANY ERRORS ACTOR FAIL TO OBSERVE HE CONTRACTOR SHALL BE INY ERRORS RESULTINGS TO SO.
ELEVATION BOH CALE DATE AS SHOWN 26 . 04 . 2017 RAWN BY DESIGNED BY IP/ SC AY IPPROVED BY ATE ROJECT NO DWG NO APQ-17-0117 EL-27	SHALL NOTIFY THE LE PISCREPANCY BEFORE VISIONE PANCY BEFORE VILL POST RESPONSIB SHOULD THE CONTRACTIFIS PROCEDURE. THE SEPONSIBLE FOR A FROM FAILURE TO DELIENT	DESIGNER OF ANY RE STARTING WORK. ITES LTD. LE FOR ANY ERRORS ACTOR FAIL TO OBSERVE HE CONTRACTOR SHALL BE INY ERRORS RESULTINGS TO SO.
BOH CALE DATE AS SHOWN 26 . 04 . 2017 RAWN BY DESIGNED BY IP/ SC AY IP/ SC AY IP/PROVED BY DATE ROJECT NO DWG NO APQ-17-0117 EL-27	SHALL NOTIFY THE E DISCREPANCY BEFOR ALL DESIGN & ASSOCIA WILL NOT RESPONSIB SHOULD THE CONTRA THIS PROCEDURE. THE RESPONSIBLE FOR A RESPONSIBLE FOR D CLIENT CIC Innovation PROJECT G/F, 44 Tai Yip	DESIGNER OF ANY RE STARTING WORK. IXTES LTD. LE FOR ANY ERRORS ACTOR FAIL TO OBSERVE HE CONTRACTOR SHALL BE INY ERRORS RESULTINGS TO SO. I Center (IC)
AS SHOWN 26 . 04 . 2017 RAWN BY DESIGNED BY IP/ SC AY IPPROVED BY ATE ROJECT NO DWG NO APQ-17-0117 EL-27	SHALL NOTIFY THE E JISCREPANCY BEFOR JISCREPANCY BEFOR JISCREPANCY BEFOR JISCREPANCY BEFOR JISCREPANCY	DESIGNER OF ANY RE STARTING WORK. IXTES LTD. LE FOR ANY ERRORS ACTOR FAIL TO OBSERVE HE CONTRACTOR SHALL BE INY ERRORS RESULTINGS TO SO. I Center (IC)
RAWN BY DESIGNED BY IP/ SC AY PPROVED BY IATE ROJECT NO DWG NO APQ-17-0117 EL-27	SHALL NOTIFY THE E DISCREPANCY BEFORE USER PANCY BEFORE WILL NOT RESPONSIB SHOULD THE CONTRA HIS PROCEDURE. TH RESPONSIBLE FOR A FROM FAILURE TO D CLIENT CIC Innovation PROJECT G/F, 44 Tai Yip Kowloon Bay, H DRAWING TITLE ELEVATION	DESIGNER OF ANY RE STARTING WORK. IXTES LTD. LE FOR ANY ERRORS ACTOR FAIL TO OBSERVE HE CONTRACTOR SHALL BE INY ERRORS RESULTINGS TO SO. I Center (IC)
IP/ SC AY IPPROVED BY IATE ROJECT NO DWG NO APQ-17-0117 EL-27	HALL NOTIFY THE E ISCREPANCY BEFORE VILL NOT RESPONSIB VILL NOT RESPONSIB SHOULD THE CONTRA ROM FAILURE TO D LIENT CIC Innovation PROJECT G/F, 44 Tai Yip Cowloon Bay, F PRAWING TITLE ELEVATION BOH	DESIGNER OF ANY RE STARTING WORK. ITTES LTD. LE FOR ANY ERRORS ACTOR FAIL TO OBSERVE HE CONTRACTOR SHALL BE INY ERRORS RESULTINGS TO SO. I Center (IC) O Street Hong Kong
ATE ROJECT NO DWG NO APQ-17-0117 EL-27	HALL NOTIFY THE E ISCREPANCY BEFORE ISCREPANCY BEFORE ISCREPANCY BEFORE INITIAL NOT RESPONSIB INITIAL NOT RESPONSIB INITIAL PROCEDURE. THE ESPONSIBLE FOR A ROM FAILURE TO D LIENT CIC Innovation ROJECT S/F, 44 Tai Yip COWIOON Bay, H RAWING TITLE ELEVATION BOH CALE	DESIGNER OF ANY RE STARTING WORK. ITTES LTD. LE FOR ANY ERRORS ACTOR FAIL TO OBSERVE HE CONTRACTOR SHALL BE INY ERRORS RESULTINGS TO SO. Description of the control of the
NATE ROJECT NO DWG NO APQ-17-0117 EL-27	HALL NOTIFY THE LEISCREPANCY BEFORE ISCREPANCY BEFORE INCLUDING & ASSOCIA IILL NOT RESPONSIB IHOULD THE CONTR. HILLS POR A ROM FAILURE TO D LIENT CIC Innovation ROJECT G/F, 44 Tai Yip COWIOON Bay, H RAWING TITLE ELEVATION BOH CALE AS SHOWN	DESIGNER OF ANY RE STARTING WORK. ITTES LTD. LE FOR ANY ERRORS ACTOR FAIL TO OBSERVE HE CONTRACTOR SHALL BE HINY ERRORS RESULTINGS TO SO. Designed of the contraction of the contractio
ROJECT NO DWG NO APQ-17-0117 EL-27	HALL NOTIFY THE E ISCREPANCY BEFOR ISCREPANCY BEFOR IJL NOT RESPONSIB IJL NOT RESPONSIB IHOULD THE CONTR. HILS PROCEDURE. THE ESPONSIBLE FOR A ROM FAILURE TO D LIENT CIC Innovation ROJECT G/F, 44 Tai Yip COWLOON Bay, H RAWING TITLE ELEVATION BOH CALE AS SHOWN RAWN BY	DESIGNER OF ANY RE STARTING WORK. ITTES LTD. LE FOR ANY ERRORS ACTOR FAIL TO OBSERVE HE CONTRACTOR SHALL BE HINY ERRORS RESULTINGS TO SO. I Center (IC) DATE 26 . 04 . 2017 DESIGNED BY
ROJECT NO DWG NO APQ-17-0117 EL-27	SHALL NOTIFY THE LE DISCREPANCY BEFORE ASSOCIA MILL NOT RESPONSIB SHOULD THE CONTRUTIES PROCEDURE. THE RESPONSIBLE FOR A STOCE OF THE PROCEDURE TO DESCRIPTION OF THE PROPERTY	DESIGNER OF ANY RE STARTING WORK. ITTES LTD. LE FOR ANY ERRORS ACTOR FAIL TO OBSERVE HE CONTRACTOR SHALL BE HINY ERRORS RESULTINGS TO SO. I Center (IC) DATE 26 . 04 . 2017 DESIGNED BY
APQ-17-0117 EL-27	SHALL NOTIFY THE LOSISCREPANCY BEFORE VISIONER PANCY BEFORE VISIONER & ASSOCIA VILL NOT RESPONSIBLE FOR A SEROM FAILURE TO DECLIENT CITY OF THE SEROM FAILURE TO DECLIENT CONTRACTOR OF THE SEROM FAILURE TO DECLIENT COMPANY OF THE SEROM OF THE SE	DESIGNER OF ANY RE STARTING WORK. ITTES LTD. LE FOR ANY ERRORS ACTOR FAIL TO OBSERVE HE CONTRACTOR SHALL BE HINY ERRORS RESULTINGS TO SO. I Center (IC) DATE 26 . 04 . 2017 DESIGNED BY
	SHALL NOTIFY THE LOSISCREPANCY BEFORE SISCREPANCY BEFORE SISCREPANCY BEFORE SHOULD THE CONTRACTION FROM FAILURE TO DECLIENT CITY OF THE SPONSIBLE FOR A STROM FAILURE TO DECLIENT CITY OF THE SPONSIBLE FOR A STROM FAILURE TO DECLIENT CITY OF THE SPONSIBLE FOR A STROM FAILURE TO DECLIENT CITY OF THE SPONSIBLE FOR A STROM FAILURE TO DECLIENT CITY OF THE SPONSIBLE FOR A STROM FAILURE TO DECLIENT CITY OF THE STROM	DESIGNER OF ANY RE STARTING WORK. ITTES LTD. LE FOR ANY ERRORS ACTOR FAIL TO OBSERVE HE CONTRACTOR SHALL BE HINY ERRORS RESULTINGS TO SO. I Center (IC) DATE 26 . 04 . 2017 DESIGNED BY
AD FILE REF	SHALL NOTIFY THE LOSISCREPANCY BEFORE VISIONER PANCY BEFORE VISIONER & ASSOCIA VILL NOT RESPONSIBLE FOR A SEROM FAILURE TO DECLIENT CITY OF THE SEROM FAILURE TO DECLIENT CONTRACTOR OF THE SEROM FAILURE TO DECLIENT COMPANY OF THE SEROM OF THE SE	DESIGNER OF ANY HE STARTING WORK. ITTES LTD. LLE FOR ANY ERRORS ACTOR FAIL TO OBSERVE HE CONTRACTOR SHALL BE HINY ERRORS RESULTINGS TO SO. DESIGNED HE CONTRACTOR SHALL BE HINY ERRORS RESULTINGS TO SO. DESIGNED BY AY DWG NO
	SHALL NOTIFY THE LE DISCREPANCY BEFORE DISCREPANCY	DESIGNER OF ANY HE STARTING WORK. ITTES LTD. LLE FOR ANY ERRORS ACTOR FAIL TO OBSERVE HE CONTRACTOR SHALL BE HINY ERRORS RESULTINGS TO SO. DESIGNED HE DATE 26 . 04 . 2017 DESIGNED BY AY DWG NO

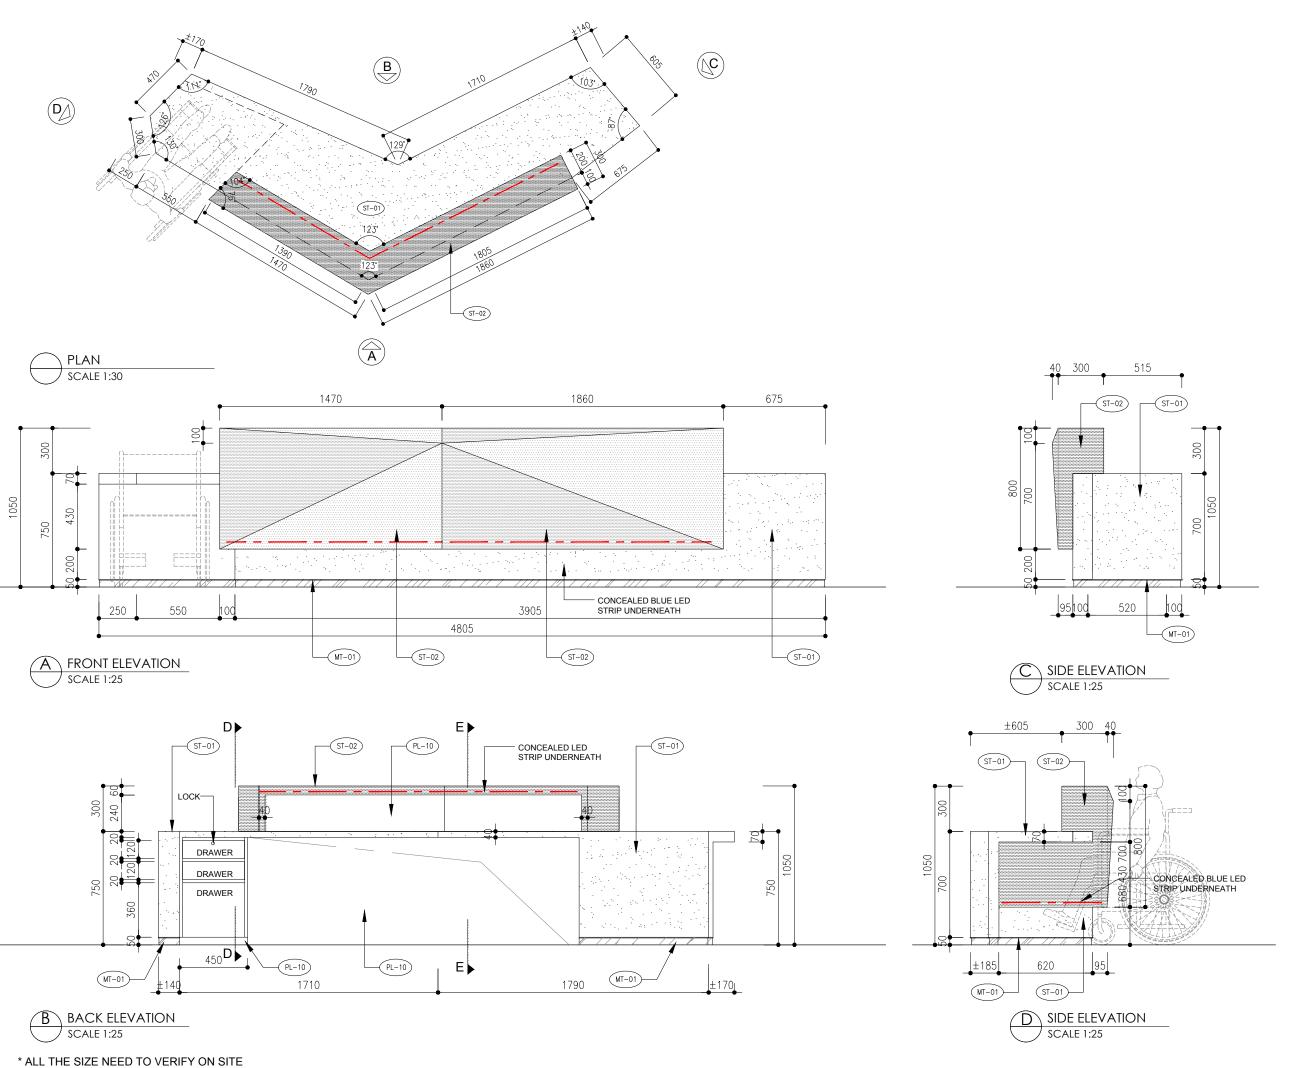



REV.	DESCRIPTION	DATE
1	GENERAL REVISION	11-05-2017
$\overline{\bigcirc}$		
$\overline{\bigcirc}$		
\bigcirc		
NOTES		

PERMISSION.

ALL MEASUREMENT MUST BE VERIFIED ON SITE BEFORE CONSTRUCTION. CONTRACTOR SHALL NOTIFY THE DESIGNER OF ANY DISCREPANCY BEFORE STARTING WORK. AL DESIGN & ASSOCIATES LTD.
WILL NOT RESPONSIBLE FOR ANY ERRORS SHOULD THE CONTRACTOR FAIL TO OBSERVE THIS PROCEDURE. THE CONTRACTOR SHALL BE RESPONSIBLE FOR ANY ERRORS RESULTINGS FROM FAILURE TO DO SO.

CLIENT

CIC Innovation Center (IC)

PROJECT

G/F, 44 Tai Yip Street Kowloon Bay, Hong Kong

DRAWING TITLE


DETAILS -RECEPTION COUNTER

SCALE	DATE
AS SHOWN	02 . 05 . 2017
DRAWN BY	DESIGNED BY
JH/ SC	AY

APPROVED BY

PROJECT NO D-01A APQ-17-0117 CAD FILE REF

Details (current).dwg

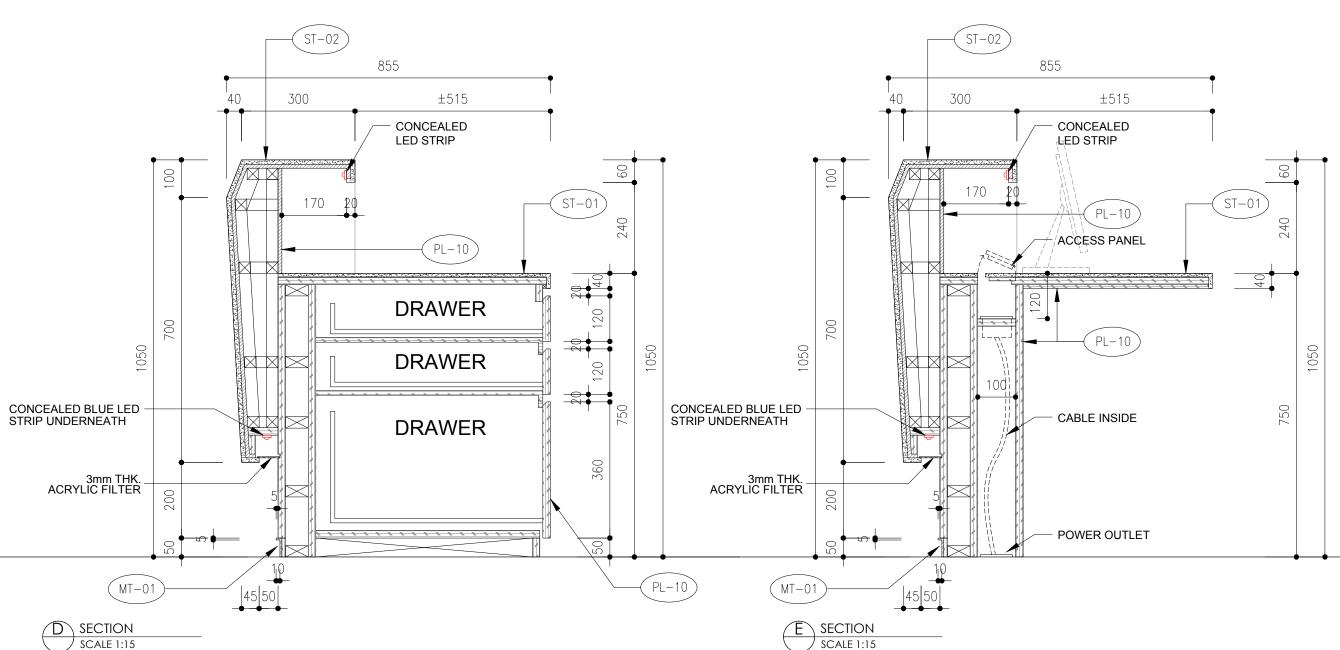



REVISION	ON	
REV.	DESCRIPTION	DATE
1	GENERAL REVISION	11-05-2017
$\overline{\bigcirc}$		
\bigcirc		
NOTES		

ALL DESIGN ARE THE PROPERTY OF AL DESIGN & ASSOCIATES LTD. AND CANNOT BE USED WITHOUT THEIR WRITTEN PERMISSION.

ALL MEASUREMENT MUST BE VERIFIED ON SITE BEFORE CONSTRUCTION. CONTRACTOR SHALL NOTIFY THE DESIGNER OF ANY DISCREPANCY BEFORE STARTING WORK.
AL DESIGN & ASSOCIATES LTD.
WILL NOT RESPONSIBLE FOR ANY ERRORS SHOULD THE CONTRACTOR FAIL TO OBSERVE THIS PROCEDURE. THE CONTRACTOR SHALL BE RESPONSIBLE FOR ANY ERRORS RESULTINGS FROM FAILURE TO DO SO.

CLIENT

CIC Innovation Center (IC)

PROJECT

G/F, 44 Tai Yip Street Kowloon Bay, Hong Kong

DRAWING TITLE

DETAILS -RECEPTION COUNTER

SCALE	DATE
AS SHOWN	02 . 05 . 2017
DRAWN BY	DESIGNED BY
JH/ SC	AY


APPROVED BY


DATE
PROJECT NO DWG NO

APQ-17-0117 D-01B

CAD FILE REF
Details (current).dwg

TENDER DRAWING

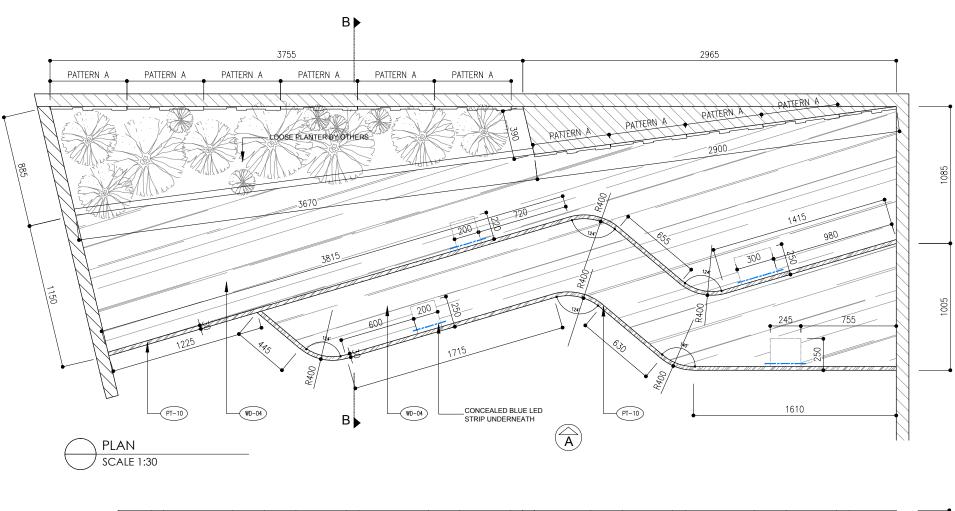

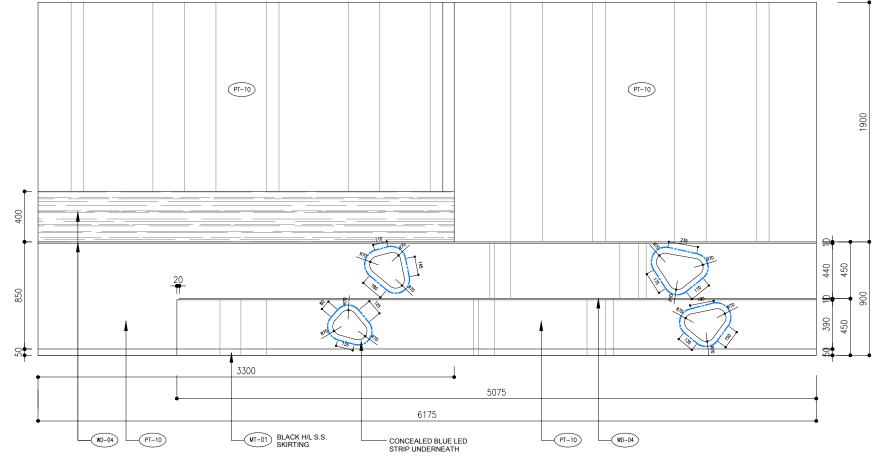

FRONT ELEVATION
SCALE 1:30

REVISION	
REV. DESCRIPTION	DATE
$\widetilde{\bigcirc}$	
$\widetilde{\bigcirc}$	
$\widetilde{\cap}$	
$\overline{\bigcirc}$	
\bigcap	
\bigcap	
\bigcirc	
\bigcirc	
\bigcup	
\bigcup	
NOTES	
ALL DESIGN ARE THE	PROPERTY OF
AL DESIGN & ASSOCIA	TES LTD. D WITHOUT THEIR WRITTEN
PERMISSION.	J WITHOUT THEIR WRITTEN
ALL MEASUREMENT N	MUST BE VERIFIED ON
	RUCTION. CONTRACTOR
SHALL NOTIFY THE D	
DISCREPANCY BEFOR AL DESIGN & ASSOCIA	
	E FOR ANY ERRORS
	CTOR FAIL TO OBSERVE
	E CONTRACTOR SHALL BE NY ERRORS RESULTINGS
FROM FAILURE TO DO	
CLIENT	
CIC Innovation	Center (IC)
PROJECT	_
G/F, 44 Tai Yip	
	iong Kong
Kowloon Bay, F	
Kowloon Bay, F	
Cowloon Bay, F	
Cowloon Bay, F DRAWING TITLE DETAILS - PLATFORM SCALE	DATE
Cowloon Bay, F DRAWING TITLE DETAILS PLATFORM	DATE 02 . 05 . 2017
Cowloon Bay, FORWING TITLE DETAILS PLATFORM GRALE AS SHOWN	
COWIOON Bay, FORWING TITLE DETAILS PLATFORM SCALE	02 . 05 . 2017


APPROVED BY

PROJECT NO

D-02A APQ-17-0117

CAD FILE REF

Details (current).dwg

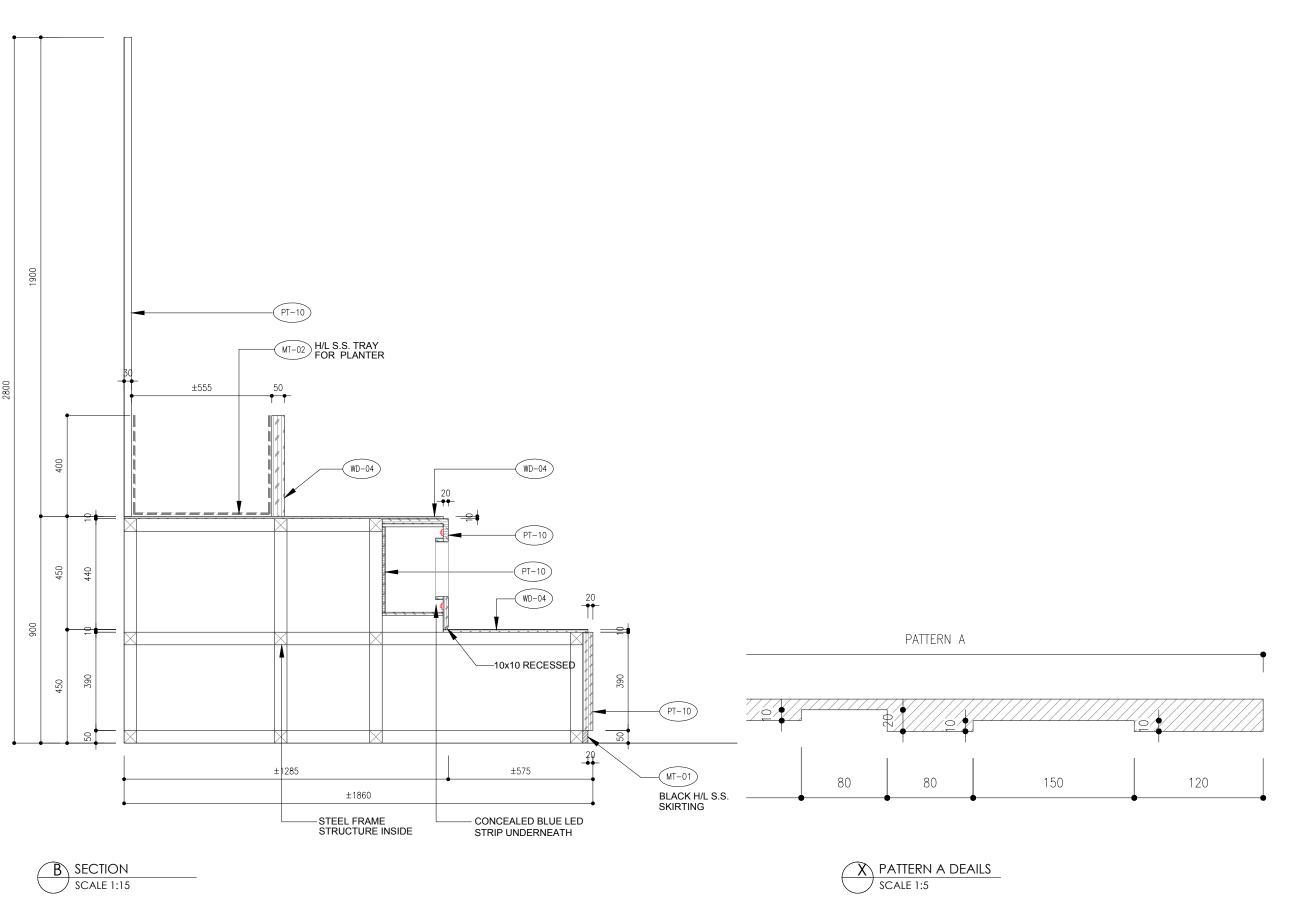






REVISION		
REV. DESCRI	PTION	DATE
$\overline{\bigcirc}$		
$\overline{\bigcirc}$		
$\tilde{\bigcirc}$		
$\widetilde{\bigcirc}$		
$\widetilde{\cap}$		
$\widetilde{}$		
$\widetilde{-}$		
$\frac{\mathcal{O}}{\mathcal{O}}$		
\supseteq		
\bigcup		
NOTES		
10120		
UL DEGIGN AD	E THE PROPERTY	05
AL DESIGN & AS	E THE PROPERTY SOCIATES LTD. E USED WITHOUT TH	
	ENT MUST BE VER	
SHALL NOTIFY	ONSTRUCTION, CO THE DESIGNER OF	ANY
DISCREPANCY E AL DESIGN & AS	SEFORE STARTING SOCIATES LTD.	WORK.
	ONSIBLE FOR ANY ONTRACTOR FAIL T	
THIS PROCEDUR	RE. THE CONTRACTO	OR SHALL BE
ROM FAILURE		NESCETINGS
CLIENT		
CIC Innova	ition Center (I	C)
PROJECT		
G/F. 44 Tai	Yip Street	
	ay, Hong Kon	9
DRAWING TITLE		
DETAILS	DN 4	
PLATFOR	NVI IVI	
SCALE	DATE	
AS SHOWN	I 02.	05 . 2017
DRAWN BY	DESIG	NED BY
JH/ SC	AY	

APPROVED BY

DATE PROJECT NO D-02B APQ-17-0117 CAD FILE REF Details (current).dwg TENDER DRAWING

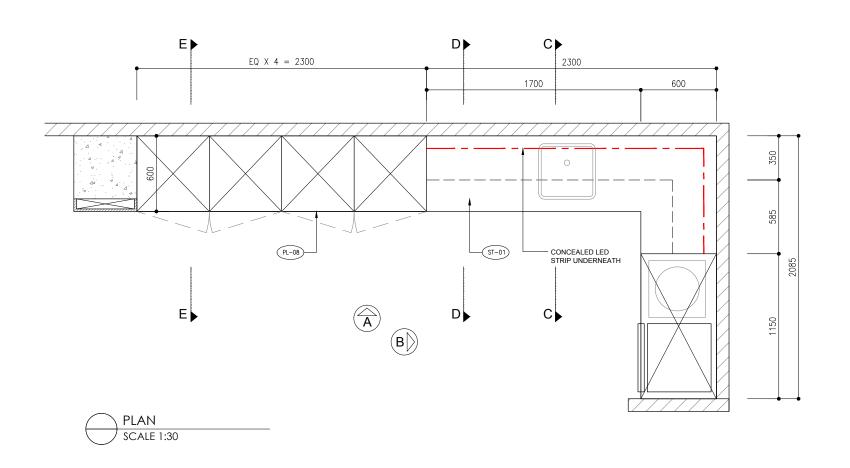

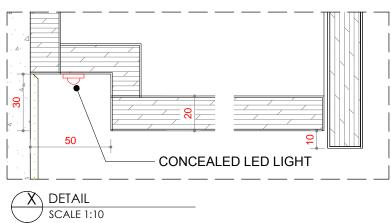


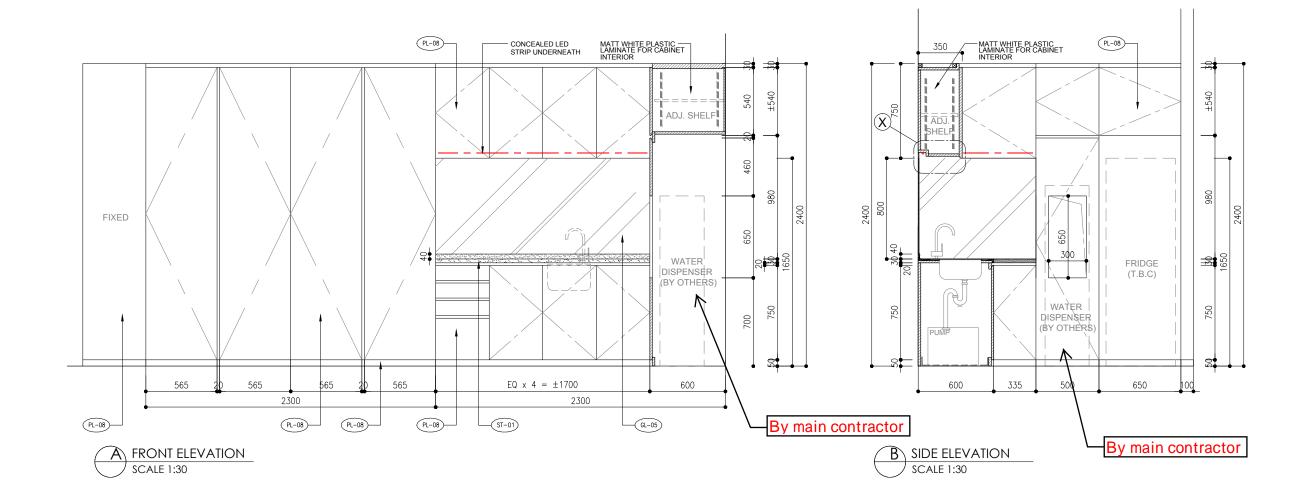




LL DESIGN ARE THE PROPERTY OF L DESIGN & ASSOCIATES LTD. NOTES LOESIGN & ASSOCIATES LTD. VILL NOTIFY THE DESIGNER OF ANY SISCREPANCY BEFORE STARTING WORK. L. DESIGN & ASSOCIATES LTD. VILL NOT RESPONSIBLE FOR ANY ERRORS SHOULD THE CONTRACTOR FAIL TO OBSERVE THIS PROCEDURE. THE CONTRACTOR SHALL BE RESPONSIBLE FOR ANY ERRORS RESULTINGS ROM FAILURE TO DO SO. CLIENT CIC Innovation Center (IC) PROJECT G/F, 44 Tai Yip Street KOWIOON Bay, Hong Kong PRAWING TITLE DETAILS PANTRY CALE DATE AS SHOWN 02.05.2017		AL	Desig	n
ALL DESIGN ARE THE PROPERTY OF INDUSTRIAL DESIGN & ASSOCIATES LTD. NOTES ALL DESIGN & ASSOCIATES LTD. NID CANNOT BE USED WITHOUT THEIR WRITTEN PERMISSION. ALL MEASUREMENT MUST BE VERIFIED ON SITE BEFORE CONSTRUCTION, CONTRACTOR SHALL NOTIFY THE DESIGNER OF ANY DISCREPANCY BEFORE STARTING WORK. ALL DESIGN & ASSOCIATES LTD. WILL MEASUREMENT MUST BE VERIFIED ON SITE BEFORE CONSTRUCTION, CONTRACTOR SHALL BE RESPONSIBLE FOR ANY ERRORS SHOULD THE CONTRACTOR FAIL TO OBSERVE THIS PROCEDURE. THE CONTRACTOR SHALL BE RESPONSIBLE FOR ANY ERRORS RESULTINGS FROM FAILURE TO DO SO. CLIENT CIC Innovation Center (IC) PROJECT SIFF, 44 Tai Yip Street KOWIOON Bay, Hong Kong DETAILS PANTRY SCALE DATE AS SHOWN 02.05.2017	REVISIO	N .		
ALL DESIGN ARE THE PROPERTY OF AL DESIGN & ASSOCIATES LTD. AND CANNOT BE USED WITHOUT THEIR WRITTEN PERMISSION. ALL MEASUREMENT MUST BE VERIFIED ON SITE BEFORE CONSTRUCTION. CONTRACTOR SHALL NOTIFY THE DESIGNER OF ANY DISCREPANCY BEFORE STARTING WORK. ALL DESIGN & ASSOCIATES LTD. WILL NOT RESPONSIBLE FOR ANY ERRORS SHOULD THE CONTRACTOR FAIL TO OBSERVE THIS PROCEDURE. THE CONTRACTOR SHALL BE RESPONSIBLE FOR ANY ERRORS RESULTINGS FROM FAILURE TO DO SO. CLIENT CIC Innovation Center (IC) PROJECT G/F, 44 Tai Yip Street Kowloon Bay, Hong Kong DRAWING TITLE DETAILS PANTRY SCALE DATE AS SHOWN DESIGNED BY DESIGNED BY	REV.	DESCRIPTION		DATE
ALL DESIGN ARE THE PROPERTY OF AL DESIGN & ASSOCIATES LTD. AND CANNOT BE USED WITHOUT THEIR WRITTEN PERMISSION. ALL MEASUREMENT MUST BE VERIFIED ON SITE BEFORE CONSTRUCTION. CONTRACTOR SHALL NOTIFY THE DESIGNER OF ANY DISCREPANCY BEFORE STARTING WORK. ALL DESIGN & ASSOCIATES LTD. WILL NOT RESPONSIBLE FOR ANY ERRORS SHOULD THE CONTRACTOR FAIL TO OBSERVE THIS PROCEDURE. THE CONTRACTOR SHALL BE RESPONSIBLE FOR ANY ERRORS RESULTINGS FROM FAILURE TO DO SO. CLIENT CIC Innovation Center (IC) PROJECT G/F, 44 Tai Yip Street Kowloon Bay, Hong Kong DRAWING TITLE DETAILS PANTRY SCALE DATE AS SHOWN DESIGNED BY DESIGNED BY	$\overline{\bigcirc}$			
ALL DESIGN ARE THE PROPERTY OF AL DESIGN & ASSOCIATES LTD. AND CANNOT BE USED WITHOUT THEIR WRITTEN PERMISSION. ALL MEASUREMENT MUST BE VERIFIED ON SITE BEFORE CONSTRUCTION. CONTRACTOR SHALL NOTIFY THE DESIGNER OF ANY DISCREPANCY BEFORE STARTING WORK. AL DESIGN & ASSOCIATES LTD. WILL NOT RESPONSIBLE FOR ANY ERRORS SHOULD THE CONTRACTOR FAIL TO OBSERVE THIS PROCEDURE. THE CONTRACTOR SHALL BE RESPONSIBLE FOR ANY ERRORS RESULTINGS FROM FAILURE TO DO SO. CLIENT CIC Innovation Center (IC) PROJECT G/F, 44 Tai Yip Street Kowloon Bay, Hong Kong DRAWING TITLE DETAILS PANTRY SCALE DATE AS SHOWN 02.05.2017	$\overline{\bigcirc}$			
ALL DESIGN ARE THE PROPERTY OF AL DESIGN & ASSOCIATES LTD. AND CANNOT BE USED WITHOUT THEIR WRITTEN PERMISSION. ALL MEASUREMENT MUST BE VERIFIED ON SITE BEFORE CONSTRUCTION. CONTRACTOR SHALL NOTIFY THE DESIGNER OF ANY DISCREPANCY BEFORE STARTING WORK. AL DESIGN & ASSOCIATES LTD. WILL NOT RESPONSIBLE FOR ANY ERRORS SHOULD THE CONTRACTOR FAIL TO OBSERVE THIS PROCEDURE. THE CONTRACTOR SHALL BE RESPONSIBLE FOR ANY ERRORS RESULTINGS FROM FAILURE TO DO SO. CLIENT CIC Innovation Center (IC) PROJECT G/F, 44 Tai Yip Street Kowloon Bay, Hong Kong DRAWING TITLE DETAILS PANTRY SCALE DATE AS SHOWN 02.05.2017	$\overline{\bigcirc}$			
ALL DESIGN ARE THE PROPERTY OF AL DESIGN & ASSOCIATES LTD. AND CANNOT BE USED WITHOUT THEIR WRITTEN PERMISSION. ALL MEASUREMENT MUST BE VERIFIED ON SITE BEFORE CONSTRUCTION. CONTRACTOR SHALL NOTIFY THE DESIGNER OF ANY DISCREPANCY BEFORE STARTING WORK. AL DESIGN & ASSOCIATES LTD. WILL NOT RESPONSIBLE FOR ANY ERRORS SHOULD THE CONTRACTOR FAIL TO OBSERVE THIS PROCEDURE. THE CONTRACTOR SHALL BE RESPONSIBLE FOR ANY ERRORS RESULTINGS FROM FAILURE TO DO SO. CLIENT CIC Innovation Center (IC) PROJECT G/F, 44 Tai Yip Street Kowloon Bay, Hong Kong DRAWING TITLE DETAILS PANTRY SCALE DATE AS SHOWN 02.05.2017	Ŏ			
ALL DESIGN ARE THE PROPERTY OF AL DESIGN & ASSOCIATES LTD. AND CANNOT BE USED WITHOUT THEIR WRITTEN PERMISSION. ALL MEASUREMENT MUST BE VERIFIED ON SITE BEFORE CONSTRUCTION. CONTRACTOR SHALL NOTIFY THE DESIGNER OF ANY DISCREPANCY BEFORE STARTING WORK. ALL DESIGN & ASSOCIATES LTD. WILL NOT RESPONSIBLE FOR ANY ERRORS SHOULD THE CONTRACTOR FAIL TO OBSERVE THIS PROCEDURE. THE CONTRACTOR SHALL BE RESPONSIBLE FOR ANY ERRORS RESULTINGS FROM FAILURE TO DO SO. CLIENT CIC Innovation Center (IC) PROJECT G/F, 44 Tai Yip Street Kowloon Bay, Hong Kong DRAWING TITLE DETAILS PANTRY SCALE DATE AS SHOWN DESIGNED BY DESIGNED BY	Ŏ			
ALL DESIGN ARE THE PROPERTY OF AL DESIGN & ASSOCIATES LTD. AND CANNOT BE USED WITHOUT THEIR WRITTEN PERMISSION. ALL MEASUREMENT MUST BE VERIFIED ON SITE BEFORE CONSTRUCTION. CONTRACTOR SHALL NOTIFY THE DESIGNER OF ANY DISCREPANCY BEFORE STARTING WORK. AL DESIGN & ASSOCIATES LTD. WILL NOT RESPONSIBLE FOR ANY ERRORS SHOULD THE CONTRACTOR FAIL TO OBSERVE THIS PROCEDURE. THE CONTRACTOR SHALL BE RESPONSIBLE FOR ANY ERRORS RESULTINGS FROM FAILURE TO DO SO. CLIENT CIC Innovation Center (IC) PROJECT G/F, 44 Tai Yip Street Kowloon Bay, Hong Kong DRAWING TITLE DETAILS PANTRY SCALE DATE AS SHOWN 02.05.2017	Ŏ			
ALL DESIGN ARE THE PROPERTY OF AL DESIGN & ASSOCIATES LTD. AND CANNOT BE USED WITHOUT THEIR WRITTEN PERMISSION. ALL MEASUREMENT MUST BE VERIFIED ON SITE BEFORE CONSTRUCTION. CONTRACTOR SHALL NOTIFY THE DESIGNER OF ANY DISCREPANCY BEFORE STARTING WORK. AL DESIGN & ASSOCIATES LTD. WILL NOT RESPONSIBLE FOR ANY ERRORS SHOULD THE CONTRACTOR FAIL TO OBSERVE THIS PROCEDURE. THE CONTRACTOR SHALL BE RESPONSIBLE FOR ANY ERRORS RESULTINGS FROM FAILURE TO DO SO. CLIENT CIC Innovation Center (IC) PROJECT G/F, 44 Tai Yip Street Kowloon Bay, Hong Kong DRAWING TITLE DETAILS - PANTRY SCALE DATE AS SHOWN DESIGNED BY DESIGNED BY	Ŏ			
ALL DESIGN ARE THE PROPERTY OF AL DESIGN & ASSOCIATES LTD. AND CANNOT BE USED WITHOUT THEIR WRITTEN PERMISSION. ALL MEASUREMENT MUST BE VERIFIED ON SITE BEFORE CONSTRUCTION. CONTRACTOR SHALL NOTIFY THE DESIGNER OF ANY DISCREPANCY BEFORE STARTING WORK. AL DESIGN & ASSOCIATES LTD. WILL NOT RESPONSIBLE FOR ANY ERRORS SHOULD THE CONTRACTOR FAIL TO OBSERVE THIS PROCEDURE. THE CONTRACTOR SHALL BE RESPONSIBLE FOR ANY ERRORS RESULTINGS FROM FAILURE TO DO SO. CLIENT CIC Innovation Center (IC) PROJECT G/F, 44 Tai Yip Street Kowloon Bay, Hong Kong DRAWING TITLE DETAILS PANTRY SCALE DATE AS SHOWN 02.05.2017	$\overline{\bigcirc}$			
ALL DESIGN ARE THE PROPERTY OF AL DESIGN & ASSOCIATES LTD. AND CANNOT BE USED WITHOUT THEIR WRITTEN PERMISSION. ALL MEASUREMENT MUST BE VERIFIED ON SITE BEFORE CONSTRUCTION. CONTRACTOR SHALL NOTIFY THE DESIGNER OF ANY DISCREPANCY BEFORE STARTING WORK. AL DESIGN & ASSOCIATES LTD. WILL NOT RESPONSIBLE FOR ANY ERRORS SHOULD THE CONTRACTOR FAIL TO OBSERVE THIS PROCEDURE. THE CONTRACTOR SHALL BE RESPONSIBLE FOR ANY ERRORS RESULTINGS FROM FAILURE TO DO SO. CLIENT CIC Innovation Center (IC) PROJECT G/F, 44 Tai Yip Street Kowloon Bay, Hong Kong DRAWING TITLE DETAILS - PANTRY SCALE DATE AS SHOWN DESIGNED BY DESIGNED BY	$\check{\bigcirc}$			
AL DESIGN & ASSOCIATES LTD. AND CANNOT BE USED WITHOUT THEIR WRITTEN PERMISSION. ALL MEASUREMENT MUST BE VERIFIED ON SITE BEFORE CONSTRUCTION. CONTRACTOR SHALL NOTIFY THE DESIGNER OF ANY DISCREPANCY BEFORE STARTING WORK. AL DESIGN & ASSOCIATES LTD. WILL NOT RESPONSIBLE FOR ANY ERRORS SHOULD THE CONTRACTOR FAIL TO OBSERVE THIS PROCEDURE. THE CONTRACTOR SHALL BE RESPONSIBLE FOR ANY ERRORS RESULTINGS FROM FAILURE TO DO SO. CLIENT CIC Innovation Center (IC) PROJECT G/F, 44 Tai Yip Street Kowloon Bay, Hong Kong DRAWING TITLE DETAILS - PANTRY SCALE DATE AS SHOWN DESIGNED BY DESIGNED BY DESIGNED BY	$\check{\bigcirc}$			
ALL DESIGN ARE THE PROPERTY OF AL DESIGN & ASSOCIATES LTD. AND CANNOT BE USED WITHOUT THEIR WRITTEN PERMISSION. ALL MEASUREMENT MUST BE VERIFIED ON SITE BEFORE CONSTRUCTION. CONTRACTOR SHALL NOTIFY THE DESIGNER OF ANY DISCREPANCY BEFORE STARTING WORK. AL DESIGN & ASSOCIATES LTD. WILL NOT RESPONSIBLE FOR ANY ERRORS SHOULD THE CONTRACTOR FAIL TO OBSERVE THIS PROCEDURE. THE CONTRACTOR SHALL BE RESPONSIBLE FOR ANY ERRORS RESULTINGS FROM FAILURE TO DO SO. CLIENT CIC Innovation Center (IC) PROJECT G/F, 44 Tai Yip Street Kowloon Bay, Hong Kong DRAWING TITLE DETAILS PANTRY SCALE DATE AS SHOWN 02.05.2017				
AL DESIGN & ASSOCIATES LTD. AND CANNOT BE USED WITHOUT THEIR WRITTEN PERMISSION. ALL MEASUREMENT MUST BE VERIFIED ON SITE BEFORE CONSTRUCTION. CONTRACTOR SHALL NOTIFY THE DESIGNER OF ANY DISCREPANCY BEFORE STARTING WORK. AL DESIGN & ASSOCIATES LTD. WILL NOT RESPONSIBLE FOR ANY ERRORS SHOULD THE CONTRACTOR FAIL TO OBSERVE THIS PROCEDURE. THE CONTRACTOR SHALL BE RESPONSIBLE FOR ANY ERRORS RESULTINGS FROM FAILURE TO DO SO. CLIENT CIC Innovation Center (IC) PROJECT G/F, 44 Tai Yip Street KOWIOON Bay, Hong Kong DRAWING TITLE DETAILS PANTRY SCALE DATE AS SHOWN DESIGNED BY DESIGNED BY DESIGNED BY	NOTES			
AL DESIGN & ASSOCIATES LTD. AND CANNOT BE USED WITHOUT THEIR WRITTEN PERMISSION. ALL MEASUREMENT MUST BE VERIFIED ON SITE BEFORE CONSTRUCTION. CONTRACTOR SHALL NOTIFY THE DESIGNER OF ANY DISCREPANCY BEFORE STARTING WORK. AL DESIGN & ASSOCIATES LTD. WILL NOT RESPONSIBLE FOR ANY ERRORS SHOULD THE CONTRACTOR FAIL TO OBSERVE THIS PROCEDURE. THE CONTRACTOR SHALL BE RESPONSIBLE FOR ANY ERRORS RESULTINGS FROM FAILURE TO DO SO. CLIENT CIC Innovation Center (IC) PROJECT G/F, 44 Tai Yip Street Kowloon Bay, Hong Kong DRAWING TITLE DETAILS - PANTRY SCALE DATE AS SHOWN DESIGNED BY DESIGNED BY DESIGNED BY				
CIC Innovation Center (IC) PROJECT G/F, 44 Tai Yip Street Kowloon Bay, Hong Kong DRAWING TITLE DETAILS - PANTRY SCALE AS SHOWN DRAWN BY DESIGNED BY				
AL DESIGN & ASSOCIATES LTD. AND CANNOT BE USED WITHOUT THEIR WRITTEN PERMISSION. ALL MEASUREMENT MUST BE VERIFIED ON SITE BEFORE CONSTRUCTION. CONTRACTOR SHALL NOTIFY THE DESIGNER OF ANY DISCREPANCY BEFORE STARTING WORK. AL DESIGN & ASSOCIATES LTD. WILL NOT RESPONSIBLE FOR ANY ERRORS SHOULD THE CONTRACTOR FAIL TO OBSERVE THIS PROCEDURE. THE CONTRACTOR SHALL BE RESPONSIBLE FOR ANY ERRORS RESULTINGS FROM FAILURE TO DO SO. CLIENT CIC Innovation Center (IC) PROJECT G/F, 44 Tai Yip Street Kowloon Bay, Hong Kong DRAWING TITLE DETAILS - PANTRY SCALE DATE AS SHOWN DESIGNED BY DESIGNED BY				
CIC Innovation Center (IC) PROJECT G/F, 44 Tai Yip Street Kowloon Bay, Hong Kong DRAWING TITLE DETAILS PANTRY SCALE AS SHOWN DESIGNED BY DESIGNED BY	PERMIS: ALL ME. SITE BE SHALL I DISCREI AL DESI WILL NO SHOULD THIS PR RESPON	SION. ASUREMENT MEFORE CONSTENDIFY THE DEPONSE OF RESPONSIBLE ONTRA OCEDURE. THIS ISSUE OF AN ISSUE	MUST BE VERIFICATION. CONTESIGNER OF AN ESTARTING WITES LTD. LE FOR ANY ER COTOR FAIL TO ECONTRACTOR NY ERRORS RE	ED ON RACTOR IY ORK. RORS OBSERVE SHALL BE
AS SHOWN 02 . 05 . 2017 DRAWN BY DESIGNED BY	CLIENT			
G/F, 44 Tai Yip Street Kowloon Bay, Hong Kong DRAWING TITLE DETAILS - PANTRY SCALE AS SHOWN DESIGNED BY DESIGNED BY	CIC I	nnovation	Center (IC)
Kowloon Bay, Hong Kong DRAWING TITLE DETAILS - PANTRY SCALE AS SHOWN DESIGNED BY DESIGNED BY				
DETAILS PANTRY SCALE DATE AS SHOWN 02 . 05 . 2017 DRAWN BY DESIGNED BY	PROJECT	Г		
PANTRY SCALE DATE AS SHOWN 02 . 05 . 2017 DRAWN BY DESIGNED BY	G/F, 4	14 Tai Yip		
AS SHOWN 02 . 05 . 2017 DRAWN BY DESIGNED BY	G/F, 4 Kowlo	14 Tai Yip oon Bay, F		
DRAWN BY DESIGNED BY	G/F, 4 Kowlo DRAWING	14 Tai Yip oon Bay, F		
	G/F, 4 Kowlo DRAWING DETA - PAN	14 Tai Yip oon Bay, F GITTLE NILS ITRY	dong Kong	
JH/ SC AY	G/F, 4 COWIC	14 Tai Yip oon Bay, F GITTLE NILS ITRY	dong Kong	5 . 2017
	G/F, 4 COWIC	14 Tai Yip oon Bay, F GITTLE NILS ITRY	dong Kong	5. 2017


PROJECT NO D-03A APQ-17-0117 CAD FILE REF Details (current).dwg TENDER DRAWING

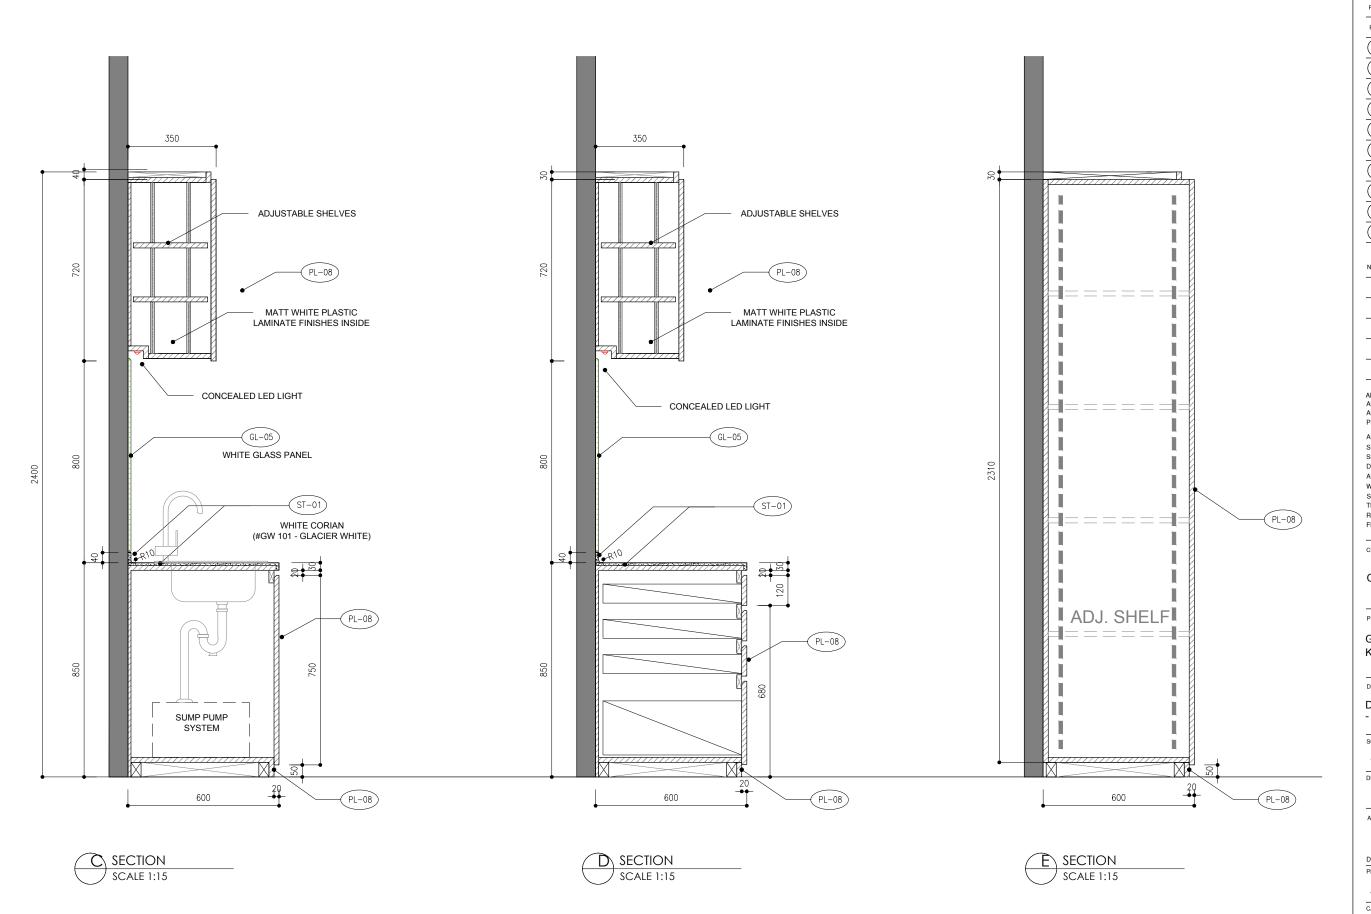



AL L	esign
REVISION	
REV. DESCRIPTION	DATE
\bigcirc	
\bigcirc	
\bigcirc	
<u> </u>	
\bigcirc	
\bigcirc	
\bigcirc	
\bigcirc	
$\widetilde{\bigcirc}$	
<u> </u>	
NOTES	
DISCREPANCY BEFORE ST AL DESIGN & ASSOCIATES I WILL NOT RESPONSIBLE FC SHOULD THE CONTRACTO THIS PROCEDURE. THE CO RESPONSIBLE FOR ANY E FROM FAILURE TO DO SC	LTD. OR ANY ERRORS R FAIL TO OBSERVE INTRACTOR SHALL BE ERRORS RESULTINGS
CLIENT	
CIC Innovation Ce	enter (IC)
PROJECT	
G/F, 44 Tai Yip Str Kowloon Bay, Hon	
DRAWING TITLE	
DETAILS - PANTRY	
SCALE	DATE
AS SHOWN	02 . 05 . 2017
DRAWN BY	DESIGNED BY
JH/ SC	AY
APPROVED BY	
DATE	
PROJECT NO	DWG NO
APQ-17-0117	D-03B
CAD FILE DES	
UAU FILE HEF	
cad file REF Details (current).dwg	

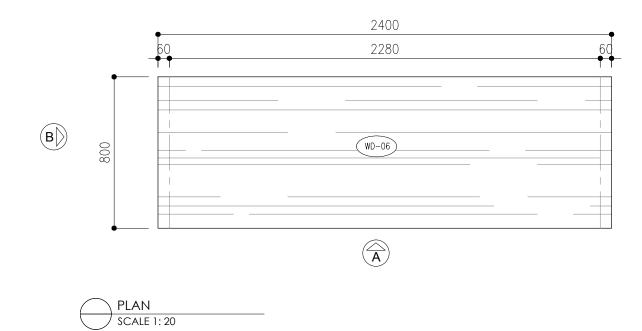

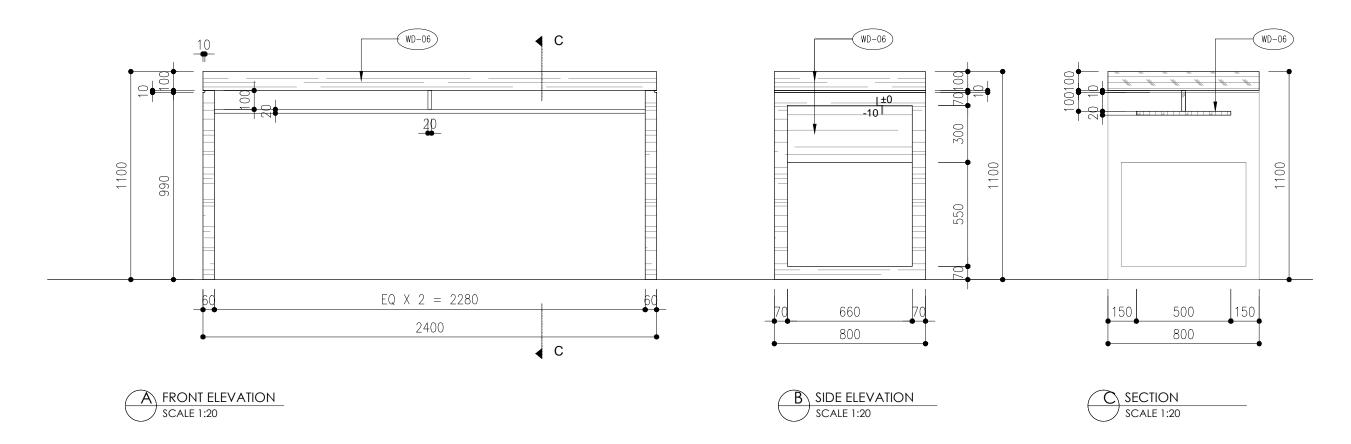



REVISION	I		
	DESCRIPTION		DATE
\bigcap			
$\tilde{\bigcirc}$			
Ŏ			
Ŏ			
\bigcirc			
<u> </u>			
<u>Q</u>			
\bigcirc			
\bigcirc			
\bigcirc			
NOTES			
	GN ARE THE F N & ASSOCIATE		
AL DESIG AND CAN PERMISS ALL MEA SITE BEF SHALL NO DISCREP. AL DESIG WILL NOT SHOULD THIS PRO RESPONS FROM FA	N & ASSOCIATE NOT BE USED \	IS LTD. WITHOUT THEI ST BE VERIFI JICTION. CONT SIGNER OF AN STARTING WE IS LTD. FOR ANY ER TOR FAIL TO CONTRACTOR FERRORS RE	R WRITTEN ED ON RACTOR Y DRK. RORS OBSERVE SHALL BE
AL DESIG AND CAN PERMISS ALL MEA BITE BEF BHALL N DISCREP, AL DESIG WILL NOT SHOULD THIS PRO RESPONS FROM FA	IN & ASSOCIATE NOT BE USED VION. SUREMENT MU FORE CONSTRUCTIFY THE DES ANCY BEFORE N & ASSOCIATE RESPONSIBLE THE CONTRAC! CICCUME. THE	IS LTD. WITHOUT THEI ST BE VERIFI ICTION. CONT SIGNER OF AN STARTING WI SE LTD. FOR ANY ER TOR FAIL TO CONTRACTOR Y ERRORS RE SO.	R WRITTEN ED ON RACTOR Y DRK. RORS OBSERVE SHALL BE SULTINGS
AL DESIGNAD CAN PERMISS ALL MEA ALL MEA BITE BEF SHALL NO DISCREP, AL DESIGN WILL NOT SHOULD THIS PRO RESPONS FROM FA CLIENT CIC In	N & ASSOCIATE NO ASSOCIATE NO ASSOCIATE NO ASSOCIATE NO ASSOCIATE NO ASSOCIATE NO ASSOCIATE RESPONSIBLE THE CONTRACT OCCUPIENT ASSOCIATE ASSOCIATE THE ASSOCIATE THE ASSOCIATE A	IS LTD. WITHOUT THEI ST BE VERIFI ICTION. CONT SIGNER OF AN STARTING WI SE LTD. FOR ANY ER TOR FAIL TO CONTRACTOR Y ERRORS RE SO.	R WRITTEN ED ON RACTOR Y DRK. RORS OBSERVE SHALL BE SULTINGS
AL DESIGNATION OF THE PROPERTY	N & ASSOCIATE NO ASSOCIATE NO ASSOCIATE NO ASSOCIATE NO ASSOCIATE NO ASSOCIATE NO ASSOCIATE RESPONSIBLE THE CONTRACT OCCUPIENT ASSOCIATE ASSOCIATE THE ASSOCIATE THE ASSOCIATE A	IS LTD. WITHOUT THEI IST BE VERIFI JOCTION. CONT SIGNER OF AN STARTING WE SS LTD. FOR ANY ER TOR FAIL TO CONTRACTOR Y ERRORS RE SO. Center (IC	R WRITTEN ED ON RACTOR Y DRK. RORS OBSERVE SHALL BE SULTINGS
AL DESIGNAD AND CAN AND AND AND AND AND AND AND AND AND A	N & ASSOCIATE NOT BE USED NOT	IS LTD. WITHOUT THEI IST BE VERIFI JOCTION. CONT SIGNER OF AN STARTING WE SS LTD. FOR ANY ER TOR FAIL TO CONTRACTOR Y ERRORS RE SO. Center (IC	R WRITTEN ED ON RACTOR Y DRK. RORS OBSERVE SHALL BE SULTINGS
AL DESIGNAD AND CAN AND CAN AND CAN ALL MEACA ALL MEACA BITE BEF SHALL N COSC COS	N & ASSOCIATE NOT BE USED NOT	IS LTD. WITHOUT THEI IST BE VERIFI JOCTION. CONT SIGNER OF AN STARTING WE SS LTD. FOR ANY ER TOR FAIL TO CONTRACTOR Y ERRORS RE SO. Center (IC	R WRITTEN ED ON RACTOR Y DRK. RORS OBSERVE SHALL BE SULTINGS
AL DESIGNAD AND CAN AND AND AND AND AND AND AND AND AND A	N & ASSOCIATE NOT BE USED NOT	IS LTD. WITHOUT THEI IST BE VERIFI JOCTION. CONT SIGNER OF AN STARTING WE SS LTD. FOR ANY ER TOR FAIL TO CONTRACTOR Y ERRORS RE SO. Center (IC	R WRITTEN ED ON RACTOR Y DRK. RORS OBSERVE SHALL BE SULTINGS
AL DESIGNA AND CAN AND AND AND AND AND AND AND AND AND A	N & ASSOCIATE NOT BE USED NOT	IS LTD. WITHOUT THEI ST BE VERIFI UCTION. CONT BIGNER OF AN STARTING WE SELTD. FOR ANY ER TOR FAIL TO CONTRACTOR FERRORS RE SO. Center (IC. Street Ong Kong DATE	R WRITTEN ED ON RACTOR Y DRK. RORS OBSERVE SHALL BE SULTINGS

DATE PROJECT NO


DWG NO


APQ-17-0117

D-04

CAD FILE REF

Details (current).dwg

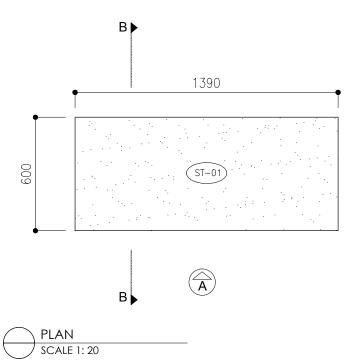

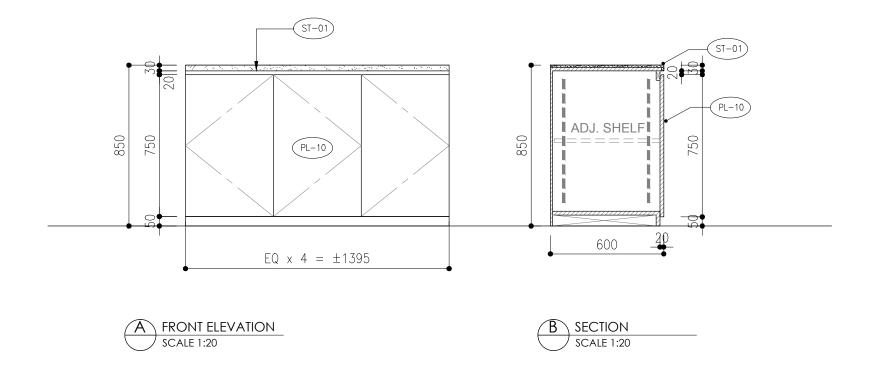



REVISIO	N		
REV.	DESCRIPTION		DATE
$\overline{\bigcirc}$			
Ŏ			
Ō			
Ō			
Ō			
$\overline{\bigcirc}$			
\bigcirc			
IOTES			
NOTES			
AL DESI	SIGN ARE THE GN & ASSOCIATI NNOT BE USED SION.	ES LTD.	
AL DESIMAND CAI PERMISS ALL MEA SHALL I DISCREI AL DESIM MILL NO SHOULE THIS PR RESPON	GN & ASSOCIATI NNOT BE USED	ES LTD. WITHOUT THE UST BE VERIF UCTION. CONT SIGNER OF AY STARTING W ES LTD. FOR ANY EF STOR FAIL TO CONTRACTOR Y ERRORS RE	IR WRITTEN IED ON TRACTOR NY ORK. RRORS OBSERVE S SHALL BE
AL DESIMAND CAI PERMISM ALL ME. BITE BE SHALL I DISCREI AL DESIM WILL NO SHOULD THIS PR RESPON FROM F	GN & ASSOCIATI VNOT BE USED SION. ASUREMENT MI FORE CONSTRI VOTIFY THE DE PANCY BEFORE GN & ASSOCIATI IT RESPONSIBLE D THE CONTRAC OCEDURE. THE ISIBLE FOR AN	ES LTD. WITHOUT THE UST BE VERIF UCTION. CONT SIGNER OF AY STARTING W ES LTD. FOR ANY EF STOR FAIL TO CONTRACTOR Y ERRORS RE	IR WRITTEN IED ON TRACTOR NY ORK. RRORS OBSERVE S SHALL BE
AL DESIGNAND CAI PERMISS ALL ME. BITE BE SHALL I DISCREI AL DESIGNAL NO SHOULE THIS PR RESPON FROM F	GN & ASSOCIATI VNOT BE USED SION. ASUREMENT MI FORE CONSTRI VOTIFY THE DE PANCY BEFORE GN & ASSOCIATI IT RESPONSIBLE D THE CONTRAC OCEDURE. THE ISIBLE FOR AN	ES LTD. WITHOUT THE UST BE VERIF UCTION. CONT SIGNER OF AN ES LTD. FOR ANY EF STOR FAIL TO CONTRACTOF Y ERRORS RE SO.	IR WRITTEN IED ON TRACTOR IY ORK. RRORS OBSERVE R SHALL BE SSULTINGS
AL DESIMAND CAIA MALL ME. MALL	GN & ASSOCIATI NOT BE USED SION. ASSUREMENT MI FFORE CONSTRI NOTIFY THE DE PANCY BEFORE GN & ASSOCIATI NT RESPONSIBLE THE CONTRAC OCEDURE. THE ISIBLE FOR AN ACILURE TO DO	ES LTD. WITHOUT THE UST BE VERIF UCTION. CONT SIGNER OF AN ES LTD. FOR ANY EF STOR FAIL TO CONTRACTOF Y ERRORS RE SO.	IR WRITTEN IED ON TRACTOR IY ORK. RRORS OBSERVE R SHALL BE SSULTINGS
AL DESIMAL AL DESIMAL AL DESIMAL ME, ALL ME, A	GN & ASSOCIATI NOT BE USED SION. ASSUREMENT MI FFORE CONSTRI NOTIFY THE DE PANCY BEFORE GN & ASSOCIATI NT RESPONSIBLE THE CONTRAC OCEDURE. THE ISIBLE FOR AN ACILURE TO DO	ES LTD. WITHOUT THE UST BE VERIF UCTION. CONT SIGNER OF AY E STARTING W ES LTD. FOR ANY EF STOR FAIL TO CONTRACTOR Y ERRORS RE SO. Center (IC	IR WRITTEN IED ON TRACTOR IY ORK. RRORS OBSERVE R SHALL BE SSULTINGS
AL DESIGNAL	GN & ASSOCIATION OF ASSOCIATION OF BUSED SION. ASSUREMENT MITTER OF ASSOCIATION	ES LTD. WITHOUT THE UST BE VERIF UCTION. CONT SIGNER OF AY E STARTING W ES LTD. FOR ANY EF STOR FAIL TO CONTRACTOR Y ERRORS RE SO. Center (IC	IR WRITTEN IED ON TRACTOR IY ORK. RRORS OBSERVE R SHALL BE SSULTINGS
AL DESINAL ALE MANAGEMENT AND CALL MELAND	GN & ASSOCIATI NOT BE USED SION. ASUREMENT MI FORE CONSTR OTHEY THE DE PANCY BEFORE GN & ASSOCIATI OTHEY THE DE SIDE OTHER OT	ES LTD. WITHOUT THE JIST BE VERIF LUCTION. CONT SIGNER OF AN E STARTING W ES LTD. E FOR ANY EF LTOR FAIL TO CONTRACTOF Y ERRORS RE SO. Center (IC	IR WRITTEN IED ON TRACTOR IY IORK. RRORS OBSERVE R SHALL BE SSULTINGS
AL DESINAL PERMISSION OF A MINISTER PROJECT IN THE	GN & ASSOCIATION OF ASSOCIATION OF BUSED SION. ASSUREMENT MITTER OF ASSOCIATION	ES LTD. WITHOUT THE JIST BE VERIF LUCTION. CONT SIGNER OF AN E STARTING W ES LTD. E FOR ANY EF LTOR FAIL TO CONTRACTOF Y ERRORS RE SO. Center (IC	IR WRITTEN IED ON TRACTOR IY IORK. RRORS OBSERVE R SHALL BE SSULTINGS
AL DESIMAND CAIA AND CAIA AND CAIA AND CAIA AND CAIA AND CAIA ALL ME.	GN & ASSOCIATION OF ASSOCIATION OF BUSED SION. ASSUREMENT MITTER OF ASSOCIATION	ES LTD. WITHOUT THE UST BE VERIF UCTION. CONT SIGNER OF AN E STARTING W ES LTD. FOR ANY EF STOR FAIL TO CONTRACTOF Y ERRORS RE SO. Center (IC) Street ong Kong EA CABIN DATE	IR WRITTEN IED ON TRACTOR IY IORK. RRORS OBSERVE R SHALL BE SSULTINGS

DATE PROJECT NO

APQ-17-0117


CAD FILE REF

Details (current).dwg

TENDER DRAWING

D-05

AB-162*

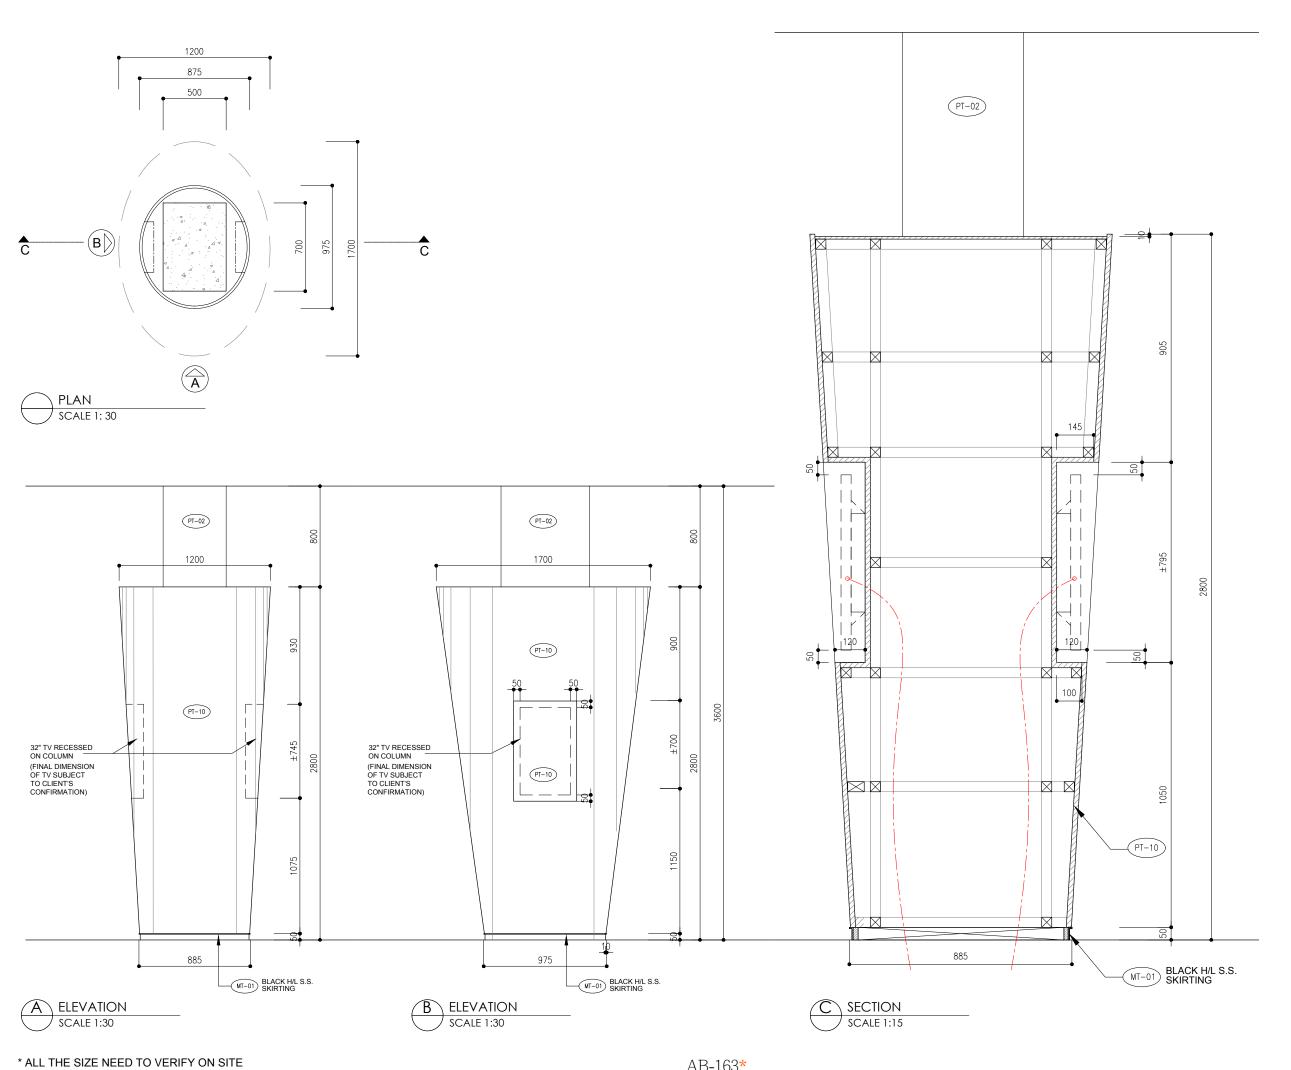


REVISIO			
REV.	DESCRIPTION		DATE
\bigcirc			
$\overline{\bigcirc}$			
Ó			
NOTES			
55	NON ARE THE	DDODEDTY OF	
AL DESI	GN & ASSOCIAT		MDITTEN.
AND CA PERMIS		WITHOUT THEIF	VAULUEN
		UST BE VERIFIE	
		RUCTION. CONTE ESIGNER OF AN'	
DISCRE	PANCY BEFOR	E STARTING WO	
	GN & ASSOCIAT OT RESPONSIBL	ies lid. .e for any eri	RORS
		CTOR FAIL TO	
RESPON	NSIBLE FOR AN	E CONTRACTOR NY ERRORS RES	
FROM F	AILURE TO DO	O SO.	
CLIENT			
010 ·	nnovette.	Contac (IC)	
	rinovation	Center (IC)	
CICI			
PROJECT	⊤ 44 Tai Yip	Street	
PROJEC	т	Street	
PROJECT G/F, 4 Kowlo	⊤ 44 Tai Yip oon Bay, H	Street	
PROJECT G/F, 4 COWIO	T 44 Tai Yip Don Bay, H	Street	
PROJECT G/F, 4 COWIG DRAWING	T 44 Tai Yip Don Bay, H	Street long Kong	
PROJECT G/F, 4 Cowld DRAWIN DETA	T 44 Tai Yip Don Bay, H	Street long Kong	
PROJECT G/F, 4 Kowlo DRAWING DETA CUF	T 44 Tai Yip oon Bay, H G TITLE AILS RVED COL	Street dong Kong LUMN	2017
PROJECTA COMIC CONTRACTOR CUF CAS S	THAT TAI YIP DON BAY, HOLLS RVED COL	Street long Kong LUMN	i . 2017
PROJECT G/F, 4 Kowlo DRAWING DETA CUF	THAT TAI YIP DOON BAY, HATTLE AILS RVED COL	Street dong Kong LUMN	

APPROVED BY

PROJECT NO DWG NO D-06 APQ-17-0117

CAD FILE REF

Details (current).dwg

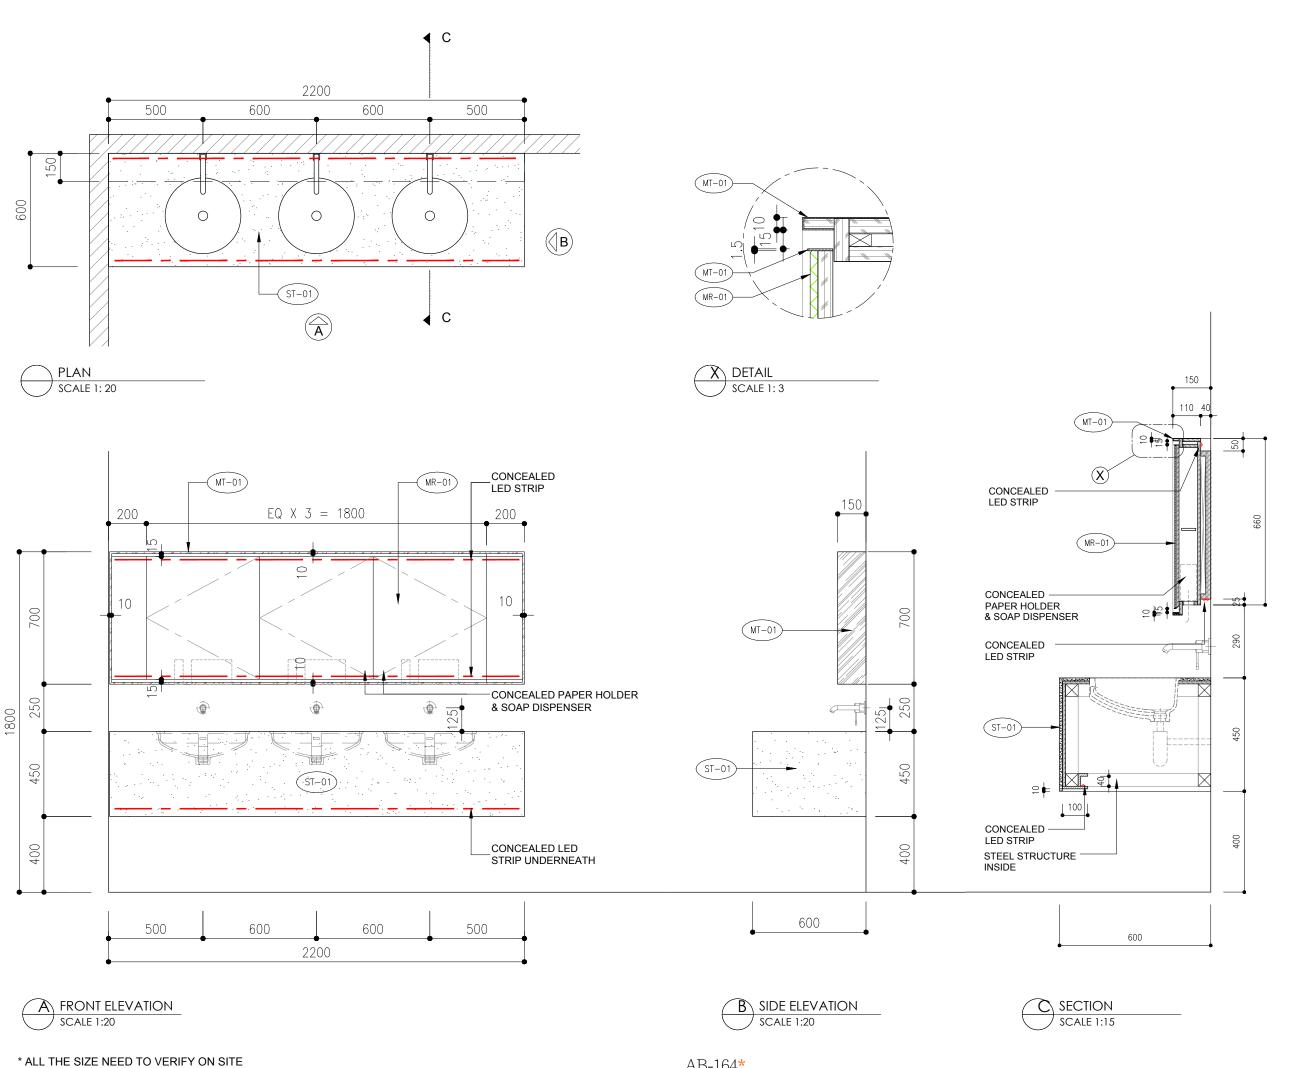



REVISIO	DN	
REV.	DESCRIPTION	DATE
$\overline{\bigcirc}$		
$\overline{\bigcirc}$		
\bigcirc		
\bigcirc		
NOTES		
-		

ALL DESIGN ARE THE PROPERTY OF AL DESIGN & ASSOCIATES LTD. AND CANNOT BE USED WITHOUT THEIR WRITTEN PERMISSION.

ALL MEASUREMENT MUST BE VERIFIED ON SITE BEFORE CONSTRUCTION. CONTRACTOR SHALL NOTIFY THE DESIGNER OF ANY DISCREPANCY BEFORE STARTING WORK. AL DESIGN & ASSOCIATES LTD.
WILL NOT RESPONSIBLE FOR ANY ERRORS SHOULD THE CONTRACTOR FAIL TO OBSERVE THIS PROCEDURE. THE CONTRACTOR SHALL BE RESPONSIBLE FOR ANY ERRORS RESULTINGS FROM FAILURE TO DO SO.

CLIENT

CIC Innovation Center (IC)

PROJECT

G/F, 44 Tai Yip Street Kowloon Bay, Hong Kong

DRAWING TITLE


DETAILS - FEMALE TOILET BASIN CABINET

SCALE DATE AS SHOWN 02 . 05 . 2017 DESIGNED BY JH/ SC ΑY APPROVED BY

PROJECT NO D-07 APQ-17-0117 CAD FILE REF Details (current).dwg

TENDER DRAWING

AB-164*

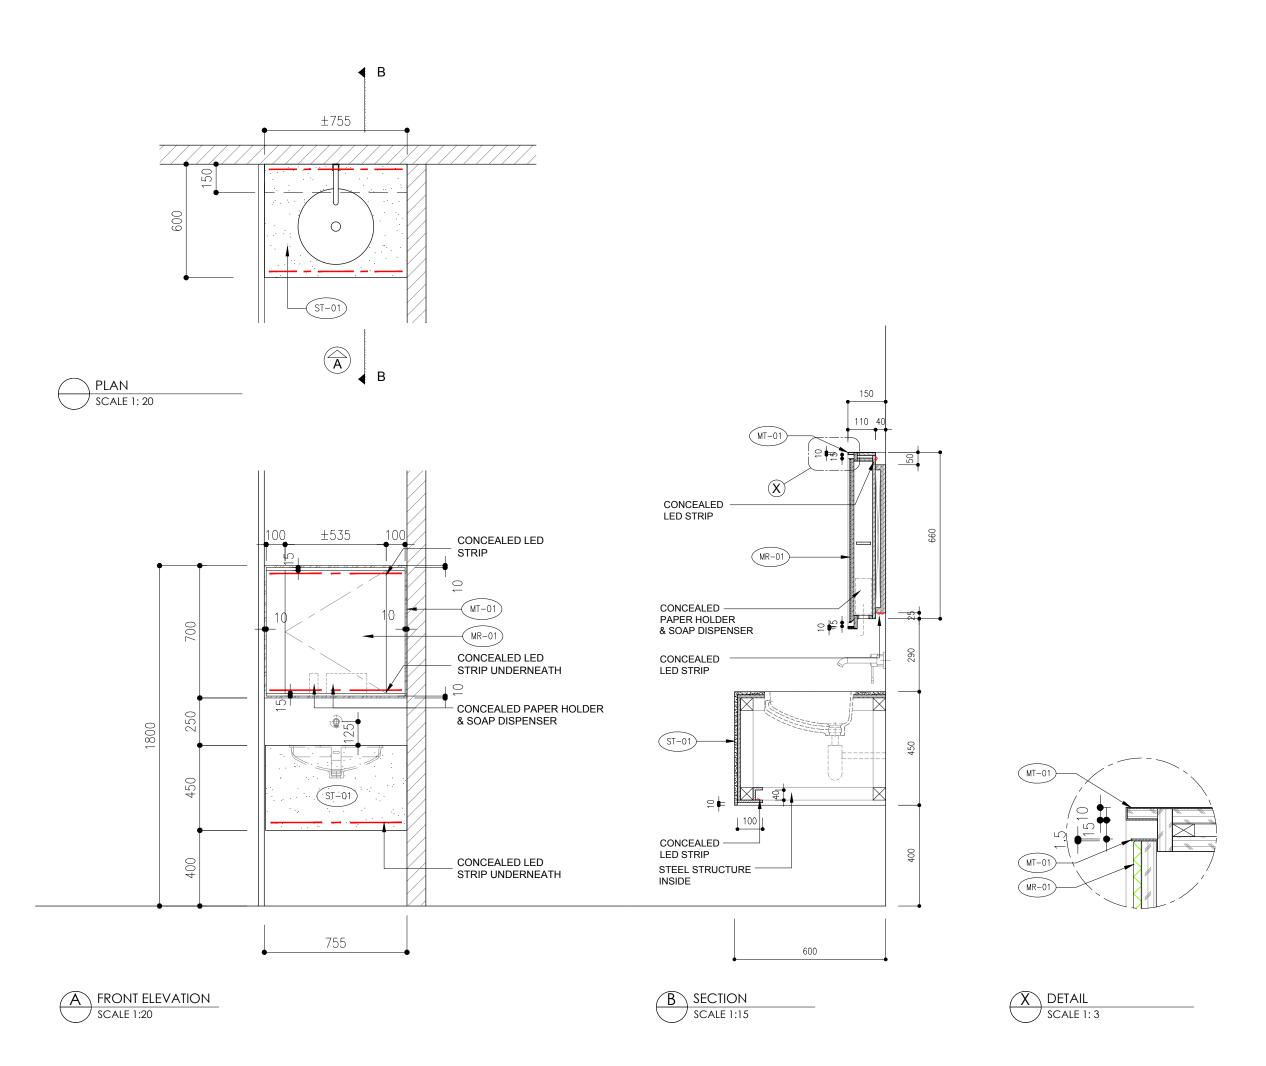



REV.	DESCRIPTION	DATE
$\overline{\bigcirc}$		
\supset		
$\widetilde{\gamma}$		
\preceq		
\preceq		
\prec		
\prec		
\preceq		
\supseteq		
\supseteq		
\bigcirc		
IOTES		

ALL DESIGN ARE THE PROPERTY OF AL DESIGN & ASSOCIATES LTD. AND CANNOT BE USED WITHOUT THEIR WRITTEN PERMISSION.

ALL MEASUREMENT MUST BE VERIFIED ON SITE BEFORE CONSTRUCTION. CONTRACTOR SHALL NOTIFY THE DESIGNER OF ANY DISCREPANCY BEFORE STARTING WORK. AL DESIGN & ASSOCIATES LTD.

WILL NOT RESPONSIBLE FOR ANY ERRORS SHOULD THE CONTRACTOR FAIL TO OBSERVE THIS PROCEDURE. THE CONTRACTOR SHALL BE RESPONSIBLE FOR ANY ERRORS RESULTINGS FROM FAILURE TO DO SO.

CLIENT

CIC Innovation Center (IC)

PROJECT

G/F, 44 Tai Yip Street Kowloon Bay, Hong Kong


DRAWING TITLE

DETAILS - MALE TOILET BASIN CABINET

SCALE	DATE
AS SHOWN	02 . 05 . 2017
DRAWN BY	DESIGNED BY
JH/ SC	AY


APPROVED BY


DATE		
PROJECT NO	DWG NO	
APQ-17-0117		D-08
CAD FILE REF		
Details (current).dwg		
TENDER DRAWING		

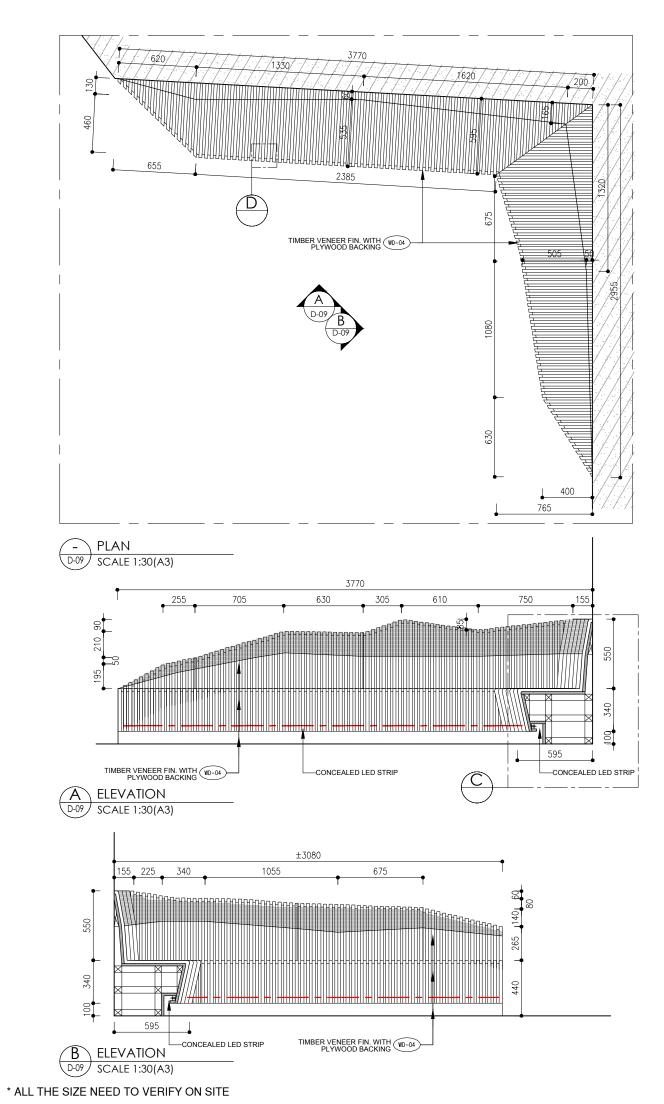



REFERENCE IMAGE

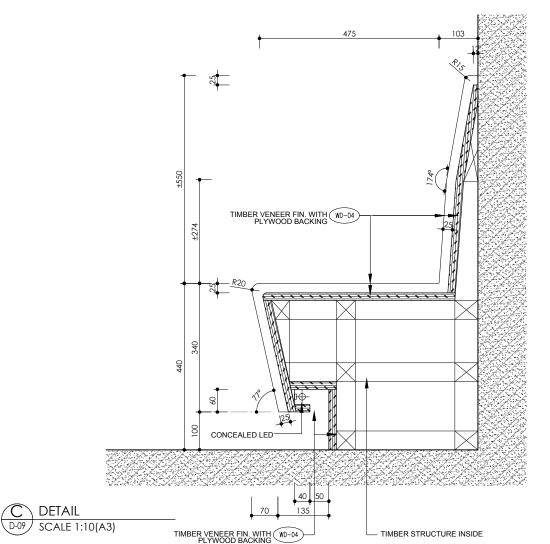

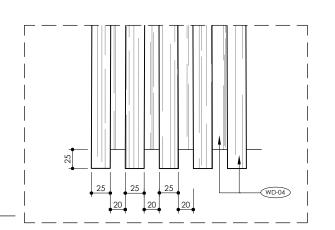

D-09 DETAIL

D-09 SCALE 1:5(A3)

AB-166*



REV.	DESCRIPTION	DATE
<u> </u>	Second How	DATE
$\not \simeq$		
\cong		
\bigcirc		
\bigcirc		
\bigcirc		
$\overline{\bigcirc}$		
$\overline{\bigcirc}$		
$\check{\frown}$		
top		
top		
\bigcup		
NOTES		
NOTES		
SITE B	EFORE CONSTR NOTIFY THE D	MUST BE VERIFIED ON RUCTION. CONTRACTOR ESIGNER OF ANY E STARTING WORK.
SITE B SHALL DISCRE AL DES WILL N SHOUL THIS PI RESPO	EFORE CONSTE NOTIFY THE DI EPANCY BEFOR SIGN & ASSOCIAT OT RESPONSIBL D THE CONTRA ROCEDURE. THI NSIBLE FOR AN	RUCTION. CONTRACTOR ESIGNER OF ANY E STARTING WORK. TES LTD. E FOR ANY ERRORS CTOR FAIL TO OBSERVE E CONTRACTOR SHALL BE NY ERRORS RESULTINGS
SITE B SHALL DISCRE AL DES WILL N SHOUL THIS PI RESPO FROM	EFORE CONSTE NOTIFY THE DI EPANCY BEFORE IGN & ASSOCIAT OT RESPONSIBL D THE CONTRA ROCEDURE. THE	RUCTION. CONTRACTOR ESIGNER OF ANY E STARTING WORK. TES LTD. E FOR ANY ERRORS CTOR FAIL TO OBSERVE E CONTRACTOR SHALL BE NY ERRORS RESULTINGS
SITE B SHALL DISCRE AL DES WILL N SHOUL THIS PI RESPO FROM	EFORE CONSTE NOTIFY THE DI EPANCY BEFOR SIGN & ASSOCIAT OT RESPONSIBL D THE CONTRA ROCEDURE. THI NSIBLE FOR AN	RUCTION. CONTRACTOR ESIGNER OF ANY E STARTING WORK. TES LTD. E FOR ANY ERRORS CTOR FAIL TO OBSERVE E CONTRACTOR SHALL BE NY ERRORS RESULTINGS
SITE B SHALL DISCRE AL DES WILL N SHOUL THIS PI RESPO FROM	EFORE CONSTR NOTIFY THE D EPANCY BEFOR IGN & ASSOCIAT OT RESPONSIBL D THE CONTRA ROCEDURE. THI NSIBLE FOR AN FAILURE TO DO	RUCTION. CONTRACTOR ESIGNER OF ANY E STARTING WORK. TES LTD. E FOR ANY ERRORS CTOR FAIL TO OBSERVE E CONTRACTOR SHALL BE NY ERRORS RESULTINGS
SITE B SHALL DISCRE AL DES WILL N SHOUL THIS PI RESPO FROM CLIENT	EFORE CONSTR NOTIFY THE D EPPANCY BEFOR IGN & ASSOCIAT OT RESPONSIBL D THE CONTRA ROCEDURE. THI NSIBLE FOR AN FAILURE TO DO	RUCTION. CONTRACTOR ESIGNER OF ANY E STARTING WORK. TES LTD. E FOR ANY ERRORS CTOR FAIL TO OBSERVE E CONTRACTOR SHALL BE MY ERRORS RESULTINGS O SO.
SITE B SHALL DISCRE AL DES WILL N SHOUL THIS PI RESPO FROM CLIENT CIC	EFORE CONSTR NOTIFY THE D EPPANCY BEFOR IGN & ASSOCIAT OT RESPONSIBL D THE CONTRA ROCEDURE. THI NSIBLE FOR AN FAILURE TO DO	RUCTION. CONTRACTOR ESIGNER OF ANY ES STARTING WORK. TES LTD. E FOR ANY ERRORS. CTOR FAIL TO OBSERVE E CONTRACTOR SHALL BE MY ERRORS RESULTINGS O SO. Center (IC)
SHALL DISCREAL DESCRIPTION SHOULL NITHIS PI RESPO FROM CIC CIC G/F,	EFORE CONSTR NOTIFY THE D PEPANCY BEFOR IGN & ASSOCIAT OT RESPONSIBL OT RESPONSIBL OT RESPONSIBL OT RESPONSIBL OT RESPONSIBL NSIBLE FOR AN FAILURE TO DO	RUCTION. CONTRACTOR ESIGNER OF ANY ES STARTING WORK. TES LTD. E FOR ANY ERRORS CTOR FAIL TO OBSERVE E CONTRACTOR SHALL BE MY ERRORS RESULTINGS O SO. Center (IC)
SHALL DISCREAL DISCRE	EFORE CONSTRUCTION THE DEPANCY BEFORE SEPONCY BEFORE SEPONCH S	RUCTION. CONTRACTOR ESIGNER OF ANY ES STARTING WORK. TES LTD. E FOR ANY ERRORS CTOR FAIL TO OBSERVE E CONTRACTOR SHALL BE MY ERRORS RESULTINGS O SO. Center (IC)
BSHALL DISCARE MULL N SHOULL THIS PI RESPO FROM CIC PROJEC G/F, KOWI DETA	EFORE CONSTRUCTIVE THE DEPANCY BEFORE GONE ASSOCIATION RESPONSIBLE DEPANCY BEFORE AND THE CONTRADICTION OF THE CON	RUCTION. CONTRACTOR ESIGNER OF ANY ES STARTING WORK. TES LTD. E FOR ANY ERRORS CTOR FAIL TO OBSERVE E CONTRACTOR SHALL BE MY ERRORS RESULTINGS O SO. Center (IC) Street long Kong
BETALLING TO THE PROJECT OF THE PROJ	EFORE CONSTRUCTIVE THE DEPANCY BEFORE SEPANCY BEFORE IGN & ASSOCIATION TRESPONSIBLE DEPANCY BEFORE AND THE CONTRAL ROCCEDURE. THINSIBLE FOR AN FAILURE TO DO THE CONTRAL THE C	RUCTION. CONTRACTOR ESIGNER OF ANY ES STARTING WORK. TES LTD. E FOR ANY ERRORS CTOR FAIL TO OBSERVE E CONTRACTOR SHALL BE MY ERRORS RESULTINGS O SO. Center (IC) Street long Kong
BISHALL DESHALL DESHAL	EFORE CONSTRUCTIVE THE DEPANCY BEFORE SEPANCY BEFORE IGN & ASSOCIATION TRESPONSIBLE DEPANCY BEFORE AND THE CONTRAL ROCCEDURE. THINSIBLE FOR AN FAILURE TO DO THE CONTRAL THE C	RUCTION. CONTRACTOR ESIGNER OF ANY ES STARTING WORK. TES LTD. E FOR ANY ERRORS CTOR FAIL TO OBSERVE E CONTRACTOR SHALL BE BY ERRORS RESULTINGS O SO. Center (IC) Street long Kong CH
DEADLE AS S	EFORE CONSTRUCTION THE DEPANCY BEFORE IGN & ASSOCIATION FROM THE CONTRAL REPORT OF THE C	RUCTION. CONTRACTOR ESIGNER OF ANY E STARTING WORK. TES LTD. LE FOR ANY ERRORS CTOR FAIL TO OBSERVE E CONTRACTOR SHALL BE BY ERRORS RESULTINGS O SO. Center (IC) Street Long Kong CH
DEADLE AS S	EFORE CONSTRUCTION THE DEPANCY BEFORE IGN & ASSOCIATION FOR THE CONTRAL REPORT OF THE CO	RUCTION. CONTRACTOR ESIGNER OF ANY E STARTING WORK. TES LTD. E FOR ANY ERRORS CONTRACTOR SHALL BE EVERORS RESULTINGS O SO. Center (IC) Street long Kong CH DATE 02.05.2017
DETU-LOU	EFORE CONSTRUCTION THE DEPANCY BEFORE GONE ASSOCIATION FOR THE SENDING ASSOCIATION FOR THE CONTRAL REPORT OF T	RUCTION. CONTRACTOR ESIGNER OF ANY E STARTING WORK. TES LTD. E FOR ANY ERRORS CTOR FAIL TO OBSERVE E CONTRACTOR SHALL BE MY ERRORS RESULTINGS O SO. Center (IC) Street long Kong CH DATE 02.05.2017 DESIGNED BY
BITTE B BITTE	EFORE CONSTRUCTION THE DEPANCY BEFORE GONE ASSOCIATION FOR THE SENDING ASSOCIATION FOR THE CONTRAL REPORT OF T	RUCTION. CONTRACTOR ESIGNER OF ANY E STARTING WORK. TES LTD. E FOR ANY ERRORS CTOR FAIL TO OBSERVE E CONTRACTOR SHALL BE MY ERRORS RESULTINGS O SO. Center (IC) Street long Kong CH DATE 02.05.2017 DESIGNED BY
SHALL DESCRIPTION OF THE PROJECT OF	EFORE CONSTRUCTION THE DEPANCY BEFORE GONE ASSOCIATION FOR THE SENDING ASSOCIATION FOR THE CONTRAL REPORT OF T	RUCTION. CONTRACTOR ESIGNER OF ANY E STARTING WORK. TES LTD. E FOR ANY ERRORS CTOR FAIL TO OBSERVE E CONTRACTOR SHALL BE MY ERRORS RESULTINGS O SO. Center (IC) Street long Kong CH DATE 02.05.2017 DESIGNED BY


APQ-17-0117

D-09

CAD FILE REF


TENDER DRAWING


D09.dwg

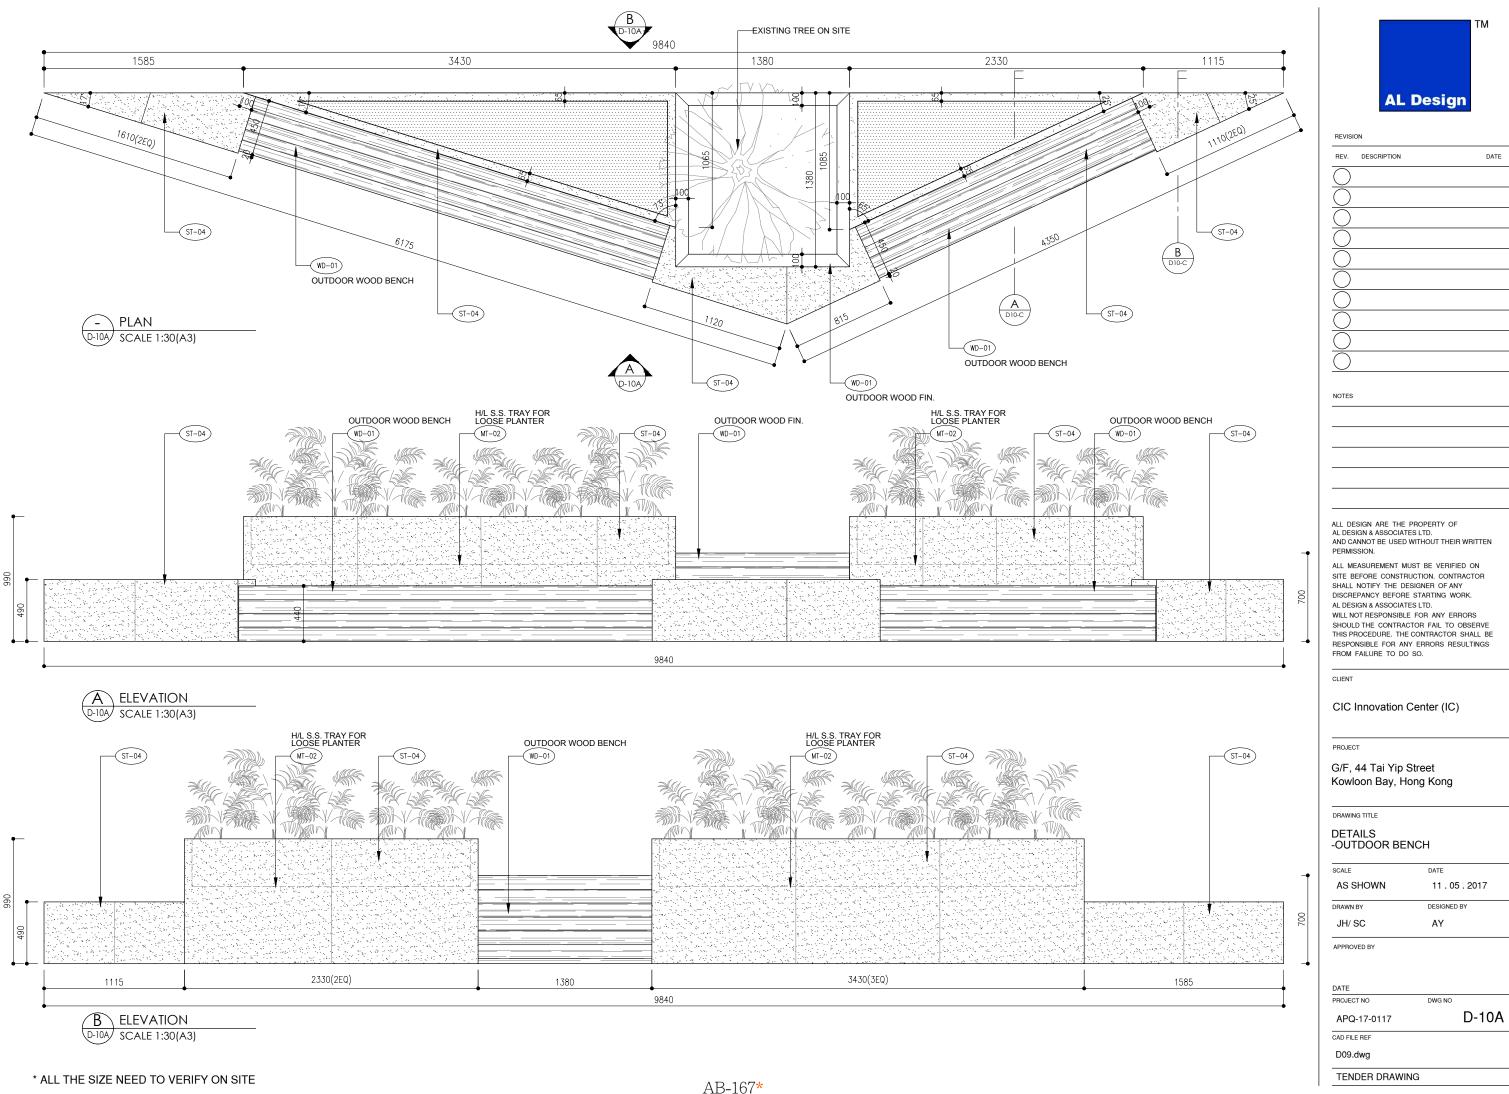

REV.	DESCRIPTION	DATE
$\overline{\bigcirc}$		
NOTES		

SCALE	DATE
AS SHOWN	11 . 05 . 2017
DRAWN BY	DESIGNED BY
JH/ SC	AY

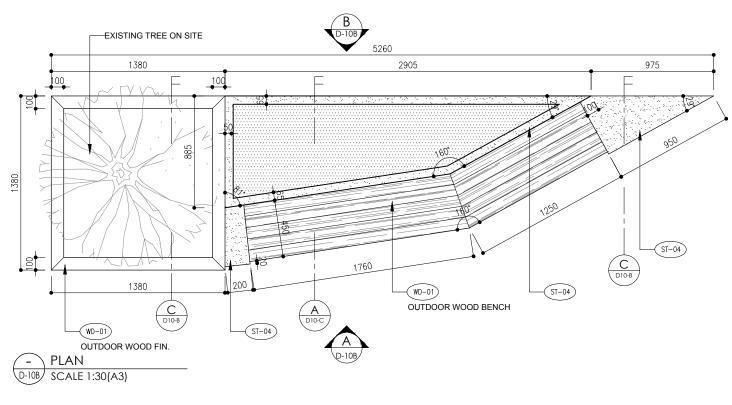

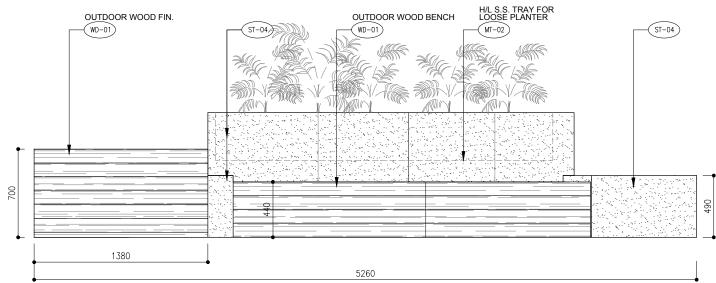

975 2905(4EQ) 1380


5260

B ELEVATION D-10B SCALE 1:30(A3)

A ELEVATION
D-10B SCALE 1:30(A3)

VARIES ON SITE



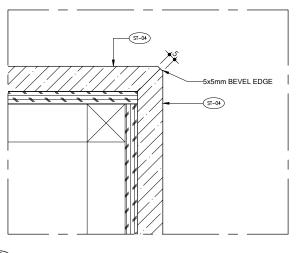

D-10B SCALE 1:3(A3)



REVISI	ON	
REV.	DESCRIPTION	DATE
$\overline{\bigcirc}$		
Ŏ		
$\overline{\bigcirc}$		
Ō		
Ō		
NOTES		

ALL DESIGN ARE THE PROPERTY OF AL DESIGN & ASSOCIATES LTD.
AND CANNOT BE USED WITHOUT THEIR WRITTEN PERMISSION.

ALL MEASUREMENT MUST BE VERIFIED ON SITE BEFORE CONSTRUCTION. CONTRACTOR SHALL NOTIFY THE DESIGNER OF ANY DISCREPANCY BEFORE STARTING WORK. AL DESIGN & ASSOCIATES LTD.
WILL NOT RESPONSIBLE FOR ANY ERRORS SHOULD THE CONTRACTOR FAIL TO OBSERVE THIS PROCEDURE. THE CONTRACTOR SHALL BE RESPONSIBLE FOR ANY ERRORS RESULTINGS FROM FAILURE TO DO SO.

CLIENT

CIC Innovation Center (IC)

PROJECT

G/F, 44 Tai Yip Street Kowloon Bay, Hong Kong

DRAWING TITLE

DETAILS -OUTDOOR BENCH

SCALE	DATE
AS SHOWN	11 . 05 . 2017
DRAWN BY	DESIGNED BY
JH/ SC	AY
APPROVED BY	

APPROVED BY

ATE		
ROJECT NO	DWG NO	
APQ-17-0117		D-10B
AD FILE REF		
D09.dwg		
TENDER DRAWING		


* ALL THE SIZE NEED TO VERIFY ON SITE

STEEL STRUCTURE INSIDE

BENCHAND PLANTER STAND
IS DEMOUNTABLE

STEEL STRUCTURE INSIDE

STEEL STRUCTURE INSIDE

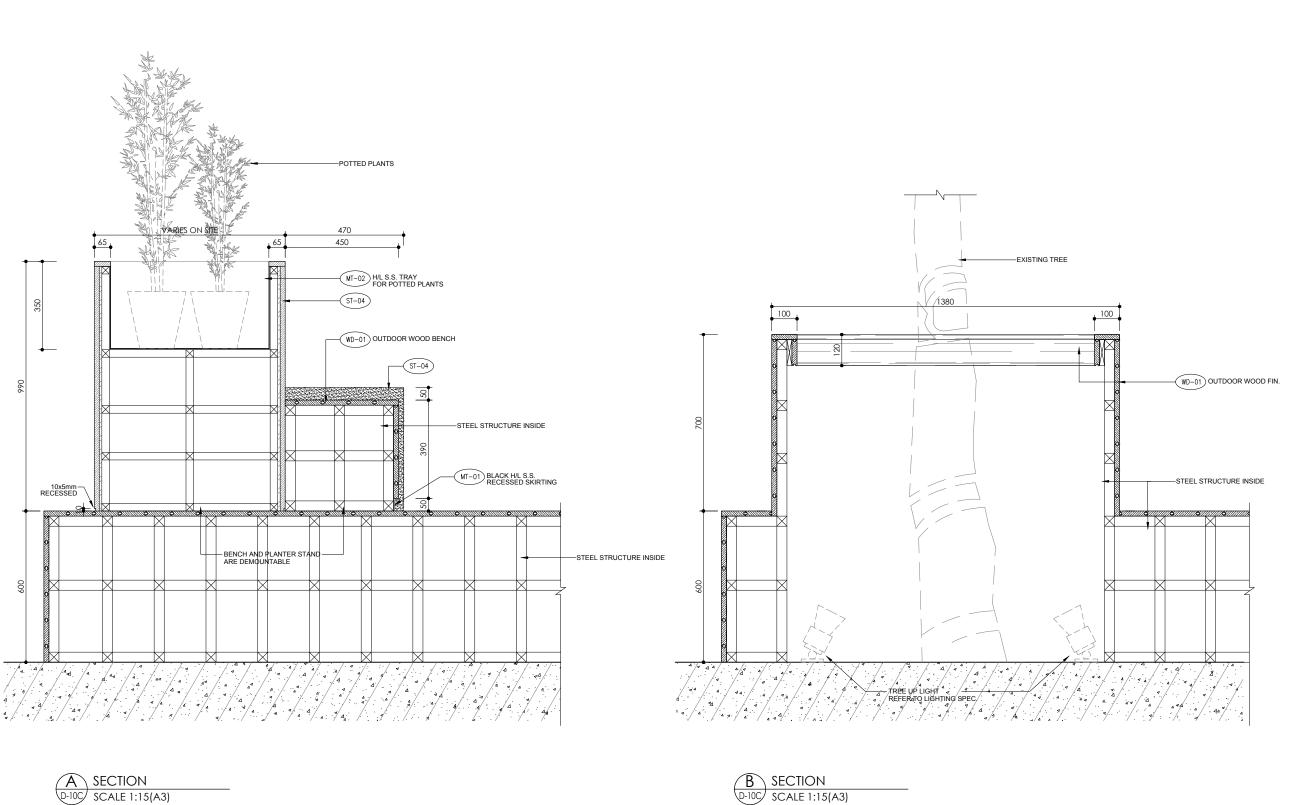



REVISION	ON	
REV.	DESCRIPTION	DATE
$\overline{\bigcirc}$		
\bigcirc		
\bigcirc		
NOTES		

ALL DESIGN ARE THE PROPERTY OF AL DESIGN & ASSOCIATES LTD. AND CANNOT BE USED WITHOUT THEIR WRITTEN PERMISSION.

ALL MEASUREMENT MUST BE VERIFIED ON SITE BEFORE CONSTRUCTION. CONTRACTOR SHALL NOTIFY THE DESIGNER OF ANY DISCREPANCY BEFORE STARTING WORK. AL DESIGN & ASSOCIATES LTD.
WILL NOT RESPONSIBLE FOR ANY ERRORS SHOULD THE CONTRACTOR FAIL TO OBSERVE THIS PROCEDURE. THE CONTRACTOR SHALL BE RESPONSIBLE FOR ANY ERRORS RESULTINGS FROM FAILURE TO DO SO.

CLIENT

CIC Innovation Center (IC)

PROJECT

G/F, 44 Tai Yip Street Kowloon Bay, Hong Kong

DRAWING TITLE


DETAILS -OUTDOOR BENCH

AS SHOWN 11 . 05 . 2017

DRAWN BY DESIGNED BY


JH/ SC AY

APPROVED BY

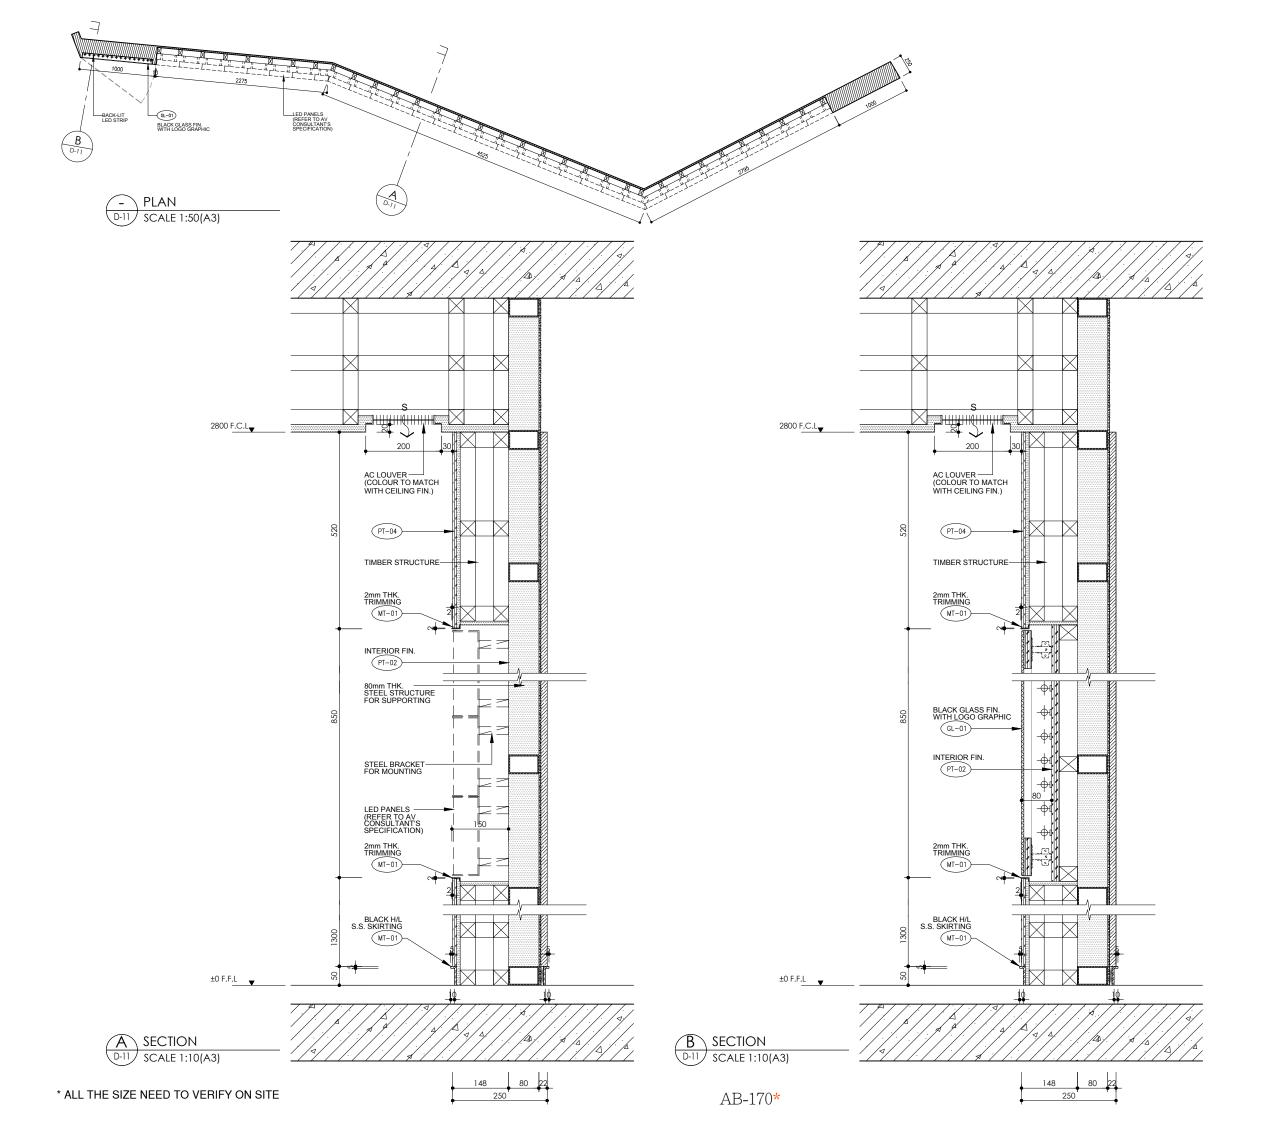



REV. DESCRIPTION	DATE
$\overline{}$	
<u> </u>	
<u>) </u>	
)	
\supset	
\supset	
$\overline{)}$	
$\overline{)}$	
<u> </u>	
OTES	
TE BEFORE CONSTE HALL NOTIFY THE D ISCREPANCY BEFOR DESIGN & ASSOCIAT ILL NOT RESPONSIBL HOULD THE CONTRA	RE STARTING WORK.
ITE BEFORE CONSTI HALL NOTIFY THE D ISCREPANCY BEFOR L DESIGN & ASSOCIA' IILL NOT RESPONSIBL HOULD THE CONTRA HIS PROCEDURE. THI	RUCTION. CONTRACTOR JUSICALER OF ANY JUS
TE BEFORE CONSTI- HALL NOTIFY THE D SCREPANCY BEFOR DESIGN & ASSOCIA' ILL NOT RESPONSIBL HOULD THE CONTRA- HIS PROCEDURE. THI SSPONSIBLE FOR AN ROM FAILURE TO DO	RUCTION. CONTRACTOR JUSICALER OF ANY JUS
TE BEFORE CONSTI- HALL NOTIFY THE D SCREPANCY BEFOR DESIGN & ASSOCIA' ILL NOT RESPONSIBL HOULD THE CONTRA- HIS PROCEDURE. THI SSPONSIBLE FOR AI ROM FAILURE TO DO JENT	RUCTION. CONTRACTOR DESIGNER OF ANY DESIGNER OF ANY DESIGNER OF ANY DESIGNER DESIGNE
ITE BEFORE CONSTR HALL NOTIFY THE D ISCREPANCY BEFOR L DESIGN & ASSOCIA' TILL NOT RESPONSIBL HOULD THE CONTRA HIS PROCEDURE. THI ESPONSIBLE FOR AN	RUCTION. CONTRACTOR DESIGNER OF ANY DESIGNER OF ANY DESIGNER OF ANY DESIGNER DESIGNE
TE BEFORE CONSTITUTED THE DESCREPANCY BEFORE DESIGN & ASSOCIA* ILL NOT RESPONSIBLE HOULD THE CONTRA HIS PROCEDURE. THE ESPONSIBLE FOR AN HOM FAILURE TO DO HENT SIC Innovation ROJECT /F, 44 Tai Yip	RUCTION. CONTRACTOR BESIGNER OF ANY BES STARTING WORK. TES LTD. LE FOR ANY ERRORS COTOR FAIL TO OBSERVE E CONTRACTOR SHALL BE NY ERRORS RESULTINGS O SO. Center (IC)
TE BEFORE CONSTI- ALL NOTIFY THE D SCREPANCY BEFOR DESIGN & ASSOCIA* ILL NOT RESPONSIBL HOUDT RESPONSIBL HOUDT HE CONTRA- HIS PROCEDURE. THI ESPONSIBLE FOR AN HOM FAILURE TO DO JENT CIC Innovation ROJECT J/F, 44 Tai Yip	RUCTION. CONTRACTOR BESIGNER OF ANY BES STARTING WORK. TES LTD. LE FOR ANY ERRORS COTOR FAIL TO OBSERVE E CONTRACTOR SHALL BE NY ERRORS RESULTINGS O SO. Center (IC)
TE BEFORE CONSTI- AALL NOTIFY THE D SCREPANCY BEFOR DESIGN & ASSOCIA* ILL NOT RESPONSIBL HOULD THE CONTRA- HIS PROCEDURE. THI ESPONSIBLE FOR AI ROM FAILURE TO DO CITY TO THE CONTRA- CITY TO THE CONTRA- CITY TO THE CONTRA- ROME TO THE CONTRA- THE CITY THE CONTRA- THE CONTRA- THE CITY THE CONTRA- THE CONTRA- THE CITY THE CONTRA- THE CITY THE CONTRA- THE CONTRA- THE CITY THE CONTRA- THE CONTR	RUCTION. CONTRACTOR BESIGNER OF ANY BES STARTING WORK. TES LTD. LE FOR ANY ERRORS COTOR FAIL TO OBSERVE E CONTRACTOR SHALL BE NY ERRORS RESULTINGS O SO. Center (IC)
TE BEFORE CONSTI- HALL NOTIFY THE D SCREPANCY BEFOR DESIGN & ASSOCIA* ILL NOT RESPONSIBL HOULD THE CONTRA- HIS PROCEDURE. THI ESPONSIBLE FOR AN ROM FAILURE TO DO JENT CIC Innovation ROJECT JENT RAWING TITLE	RUCTION. CONTRACTOR BESIGNER OF ANY BES STARTING WORK. TES LTD. LE FOR ANY ERRORS COTOR FAIL TO OBSERVE E CONTRACTOR SHALL BE NY ERRORS RESULTINGS O SO. Center (IC)
TE BEFORE CONSTI- HALL NOTIFY THE D SCREPANCY BEFOR DESIGN & ASSOCIA* ILL NOT RESPONSIBL HOULD THE CONTRA- HIS PROCEDURE. THE ESPONSIBLE FOR AN ROM FAILURE TO DO CITY OF THE CONTRA- HIS PROCEDURE. THE SPONSIBLE FOR AN ROM FAILURE TO DO CITY OF THE CONTRA- HIS PROCEDURE THE SPONSIBLE FOR AN ROM FAILURE TO DO CITY OF THE SPONSIBLE THE SPONSIBLE FOR AN ROM FAILURE TO DO CITY OF THE SPONSIBLE THE SPONSIBLE FOR AN ROM FAILURE TO DO CITY OF THE SPONSIBLE THE SPONSIBLE FOR AN ROM FAILURE TO DO ROME THE SPONSIBLE FOR AN ROM FAILURE THE SPONSIBLE THE SPONS	RUCTION. CONTRACTOR RESIGNER OF ANY RES TARRING WORK. TES LTD. LE FOR ANY ERRORS ICTOR FAIL TO OBSERVE E CONTRACTOR SHALL BE NY ERRORS RESULTINGS O SO. Center (IC) Street Hong Kong
TE BEFORE CONSTI- HALL NOTIFY THE D SCREPANCY BEFOR DESIGN & ASSOCIA* ILL NOT RESPONSIBL HOULD THE CONTRA HIS PROCEDURE. THI ESPONSIBLE FOR AN ROM FAILURE TO DO LIENT CIC Innovation ROJECT J/F, 44 Tai Yip OWIOON Bay, H RAWING TITLE ETAILS RECEPTION L	RUCTION. CONTRACTOR RESIGNER OF ANY RES STARTING WORK. TES LTD. LE FOR ANY ERRORS COTOR FAIL TO OBSERVE E CONTRACTOR SHALL BE NY ERRORS RESULTINGS O SO. Center (IC) Street Hong Kong
TE BEFORE CONSTITUTE THE DESCREPANCY BEFORE DESIGN & ASSOCIA* ILL NOT RESPONSIBLE OUTLE THE DESIGN & ASSOCIA* ILL NOT RESPONSIBLE FOR AN ARM FAILURE TO DESIGN & ASSOCIA* ILL NOT RESPONSIBLE FOR AN ARM FAILURE TO DESIGN FAILURE T	RUCTION. CONTRACTOR RESIGNER OF ANY RES STARTING WORK. TES LTD. LE FOR ANY ERRORS COTOR FAIL TO OBSERVE E CONTRACTOR SHALL BE NY ERRORS RESULTINGS O SO. Center (IC) Street Hong Kong LED WALL DATE
TE BEFORE CONSTI	RUCTION. CONTRACTOR RESIGNER OF ANY RESIGNER OF ANY RES STARTING WORK. TES LTD. LE FOR ANY ERRORS RICTOR FAIL TO OBSERVE E CONTRACTOR SHALL BE NY ERRORS RESULTINGS O SO. Center (IC) Street Hong Kong LED WALL DATE 11.05.2017
TE BEFORE CONSTRIALL NOTIFY THE DESCREPANCY BEFORE DESIGN & ASSOCIA* LL NOT RESPONSIBLE HOLD THE CONTRAL IS PROCEDURE. THIS SPONSIBLE FOR AN OM FAILURE TO DO THE CONTRAL IS PROCEDURE. THE SPONSIBLE FOR AN OM FAILURE TO DO THE CONTRAL IS PROCEDURE. THE SPONSIBLE FOR AN OM FAILURE TO DO THE CONTRAL IS PROCEDURE. THE SPONSIBLE FOR AN OWN FAILURE TO DO THE CONTRAL IS SPONSIBLE FOR AN OWN FAILURE TO DO THE CONTRAL IS SPONSIBLE FOR AN OWN FAILURE TO DO THE CONTRAL IS SPONSIBLE FOR AN OWN FAILURE FOR THE CONTRAL IS SPONSIBLE FOR AN OWN FAILURE FOR THE CONTRAL IS SPONSIBLE FOR THE CONTRAL IS SPONSIBLE FOR AN OWN FAILURE FOR THE CONTRAL IN THE CONTRAL IS SPONSIBLE FOR AN OWN FAILURE FOR THE CONTRAL IS SPONSIBLE FOR AN OWN FAILURE FOR THE CONTRAL IS SPONSIBLE FOR AN OWN FAILURE FOR THE CONTRAL IS SPONSIBLE FOR AN OWN FAILURE FOR THE CONTRAL IS SPONSIBLE FOR AN OWN FAILURE FOR THE CONTRAL IS SPONSIBLE FOR AN OWN FAILURE FOR THE CONTRAL IS SPONSIBLE FOR AN OWN FAILURE FOR AN OWN FAILURE FOR THE CONTRAL IS SPONSIBLE FOR AN OWN FAILURE FOR THE CONTRAL IS SPONSIBLE FOR AN OWN FAILURE FOR AN OWN FAILURE FOR THE CONTRAL IS SPONSIBLE FOR AN OWN FAILURE FOR THE CONTRAL IS SPONSIBLE FOR AN OWN FAILURE FOR THE CONTRAL IS SPONSIBLE FOR AN OWN FAILURE FOR THE CONTRAL IS SPONSIBLE FOR AN OWN FAILURE FOR THE CONTRAL IS SPONSIBLE FOR AN OWN FAILURE FOR THE CONTRAL IS SPONSIBLE FOR AN OWN FAILURE FOR THE CONTRAL IS SPONSIBLE FOR AN OWN FAILURE FOR THE CONTRAL IS SPONSIBLE FOR AN OWN FAILURE FOR THE CONTRAL IS SPONSIBLE FOR AN OWN FAILURE FOR THE CONTRAL IS SPONSIBLE FOR AN OWN FAILURE FOR THE CONTRAL IS SPONSIBLE FOR THE CONTRAL IS SPONSIB	RUCTION. CONTRACTOR RESIGNER OF ANY RESIGNER OF ANY RES STARTING WORK. TES LTD. LE FOR ANY ERRORS LICTOR FAIL TO OBSERVE E CONTRACTOR SHALL BE NY ERRORS RESULTINGS O SO. Center (IC) Street Hong Kong LED WALL DATE 11.05.2017
TE BEFORE CONSTITULE THE DESCREPANCY BEFORE DESIGN & ASSOCIA* LL NOT RESPONSIBLE FOR AN AIR PROCEDURE. THE SPONSIBLE FOR AN AIR PROCEDURE FOR AN AIR PROCEDURE. THE SPONSIBLE FOR AN AIR PROCEDURE. THE SPONSIBLE FOR AN AIR PROCEDURE FOR AIR PROCEDURE. THE SPONSIBLE FOR AIR PROCEDURE	RUCTION. CONTRACTOR RESIGNER OF ANY RESIGNER OF ANY RES STARTING WORK. TES LTD. LE FOR ANY ERRORS RICTOR FAIL TO OBSERVE E CONTRACTOR SHALL BE NY ERRORS RESULTINGS O SO. Center (IC) Street Hong Kong LED WALL DATE 11.05.2017
TE BEFORE CONSTI- ALL NOTIFY THE D SCREPANCY BEFOR DESIGN & ASSOCIA* ILL NOT RESPONSIBLE HOUT RESPONSIBLE HOUT RESPONSIBLE SPONSIBLE FOR AN HOM FAILURE TO DO SIENT CIC Innovation ROJECT H/F, 44 Tai Yip OWIOON Bay, H PAWING TITLE ETAILS RECEPTION L SALE AS SHOWN RAWN BY JH/ SC	RUCTION. CONTRACTOR RESIGNER OF ANY RESIGNER OF ANY RES STARTING WORK. TES LTD. LE FOR ANY ERRORS LICTOR FAIL TO OBSERVE E CONTRACTOR SHALL BE NY ERRORS RESULTINGS O SO. Center (IC) Street Hong Kong LED WALL DATE 11.05.2017
TE BEFORE CONSTI- HALL NOTIFY THE D SCREPANCY BEFOR DESIGN & ASSOCIA* ILL NOT RESPONSIBL HOULD THE CONTRA- HIS PROCEDURE. THI ESPONSIBLE FOR AN ROM FAILURE TO DO CHENT CIC Innovation ROJECT J/F, 44 Tai Yip owloon Bay, H	RUCTION. CONTRACTOR RESIGNER OF ANY RESIGNER OF ANY RES STARTING WORK. TES LTD. LE FOR ANY ERRORS LICTOR FAIL TO OBSERVE E CONTRACTOR SHALL BE NY ERRORS RESULTINGS O SO. Center (IC) Street Hong Kong LED WALL DATE 11.05.2017
TE BEFORE CONSTITULE THE DESCREPANCY BEFORE DESIGN & ASSOCIA* LL NOT RESPONSIBLE OULD THE CONTRES PROCEDURE. THE SPONSIBLE FOR AN IOM FAILURE TO DO THE CONTRES PROCEDURE. THE SPONSIBLE FOR AN IOM FAILURE TO DO THE CONTRES PROCEDURE. THE SPONSIBLE FOR AN IOM FAILURE TO DO THE SET OF THE	RUCTION. CONTRACTOR RESIGNER OF ANY ESTARTING WORK. TES LTD. LE FOR ANY ERRORS ICTOR FAIL TO OBSERVE E CONTRACTOR SHALL BE NY ERRORS RESULTINGS O SO. Center (IC) Street Hong Kong LED WALL DATE 11.05.2017 DESIGNED BY AY
TE BEFORE CONSTI- ALL NOTIFY THE D SCREPANCY BEFOR DESIGN & ASSOCIA* ILL NOT RESPONSIBLE HOULD THE CONTRI- AUSTRICATION SPONSIBLE FOR AN HOM FAILURE TO DO SOLECT IF, 44 Tai Yip OWIOON Bay, H RAWING TITLE ETAILS RECEPTION L SALE AS SHOWN MAWN BY JH/ SC	RUCTION. CONTRACTOR RESIGNER OF ANY RESIGNER OF ANY RES STARTING WORK. TES LTD. LE FOR ANY ERRORS LICTOR FAIL TO OBSERVE E CONTRACTOR SHALL BE NY ERRORS RESULTINGS O SO. Center (IC) Street Hong Kong LED WALL DATE 11.05.2017

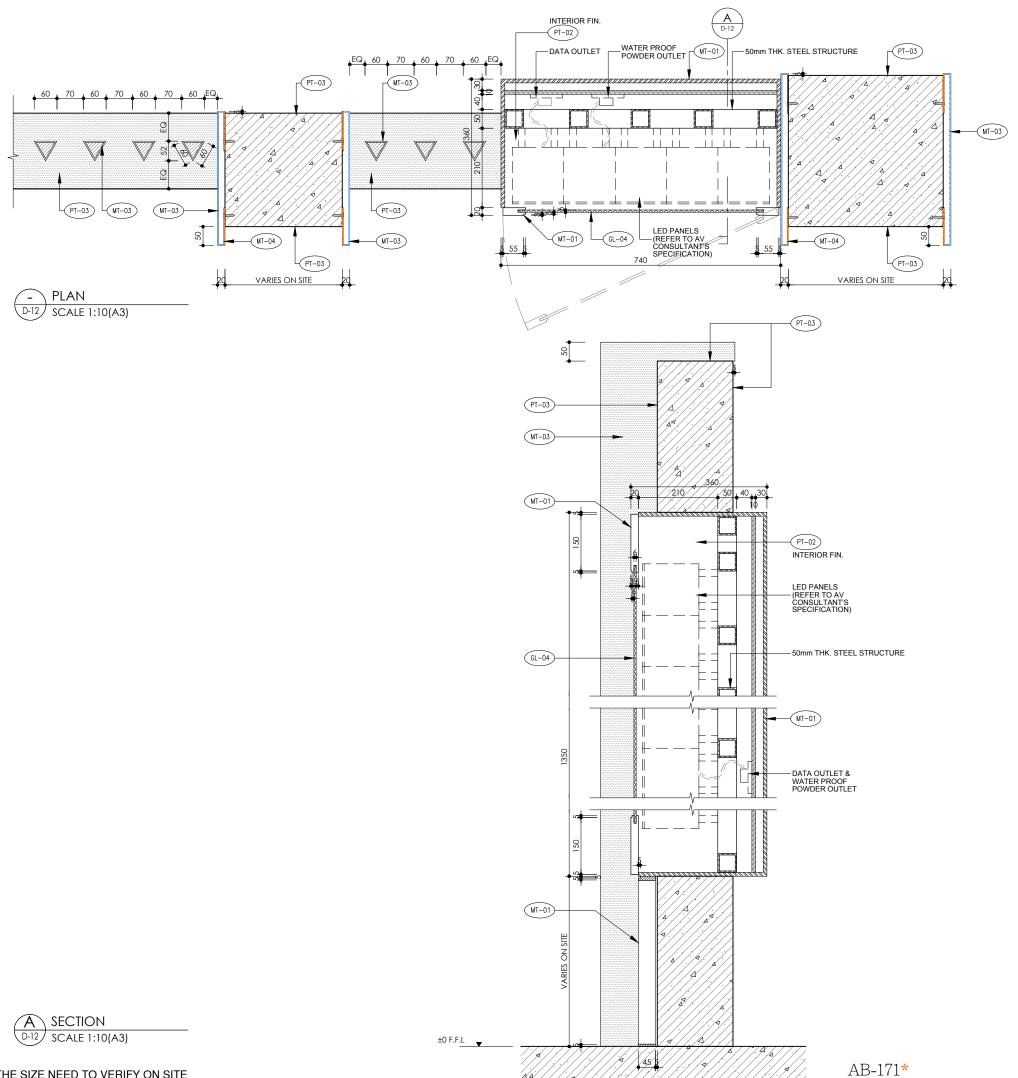



AL De	sian
REVISION	
REV. DESCRIPTION	DATE
\bigcap	
$\overline{\bigcirc}$	
$\overline{\bigcirc}$	
\bigcirc	
NOTES	
ALL DESIGN ARE THE PROPE AL DESIGN & ASSOCIATES LTD AND CANNOT BE USED WITHO PERMISSION.).
ALL MEASUREMENT MUST BI	E VERIFIED ON
SITE BEFORE CONSTRUCTION SHALL NOTIFY THE DESIGNE	
DISCREPANCY BEFORE STAF AL DESIGN & ASSOCIATES LTD	RTING WORK.
WILL NOT RESPONSIBLE FOR	ANY ERRORS
SHOULD THE CONTRACTOR I	RACTOR SHALL BE
RESPONSIBLE FOR ANY ERR FROM FAILURE TO DO SO.	ORS RESULTINGS
CLIENT	
0101 " 0 1	(10)
CIC Innovation Cent	er (IC)
PROJECT	
G/F, 44 Tai Yip Stree	et
Kowloon Bay, Hong	
DRAWING TITLE	
DETAILS -OUTDOOR LED PA	NEL
AS SHOWN	11 . 05 . 2017
_	DESIGNED BY
JH/ SC	AY
"	


APPROVED BY

PROJECT NO DWG NO

D-12 APQ-17-0117

CAD FILE REF

D09.dwg

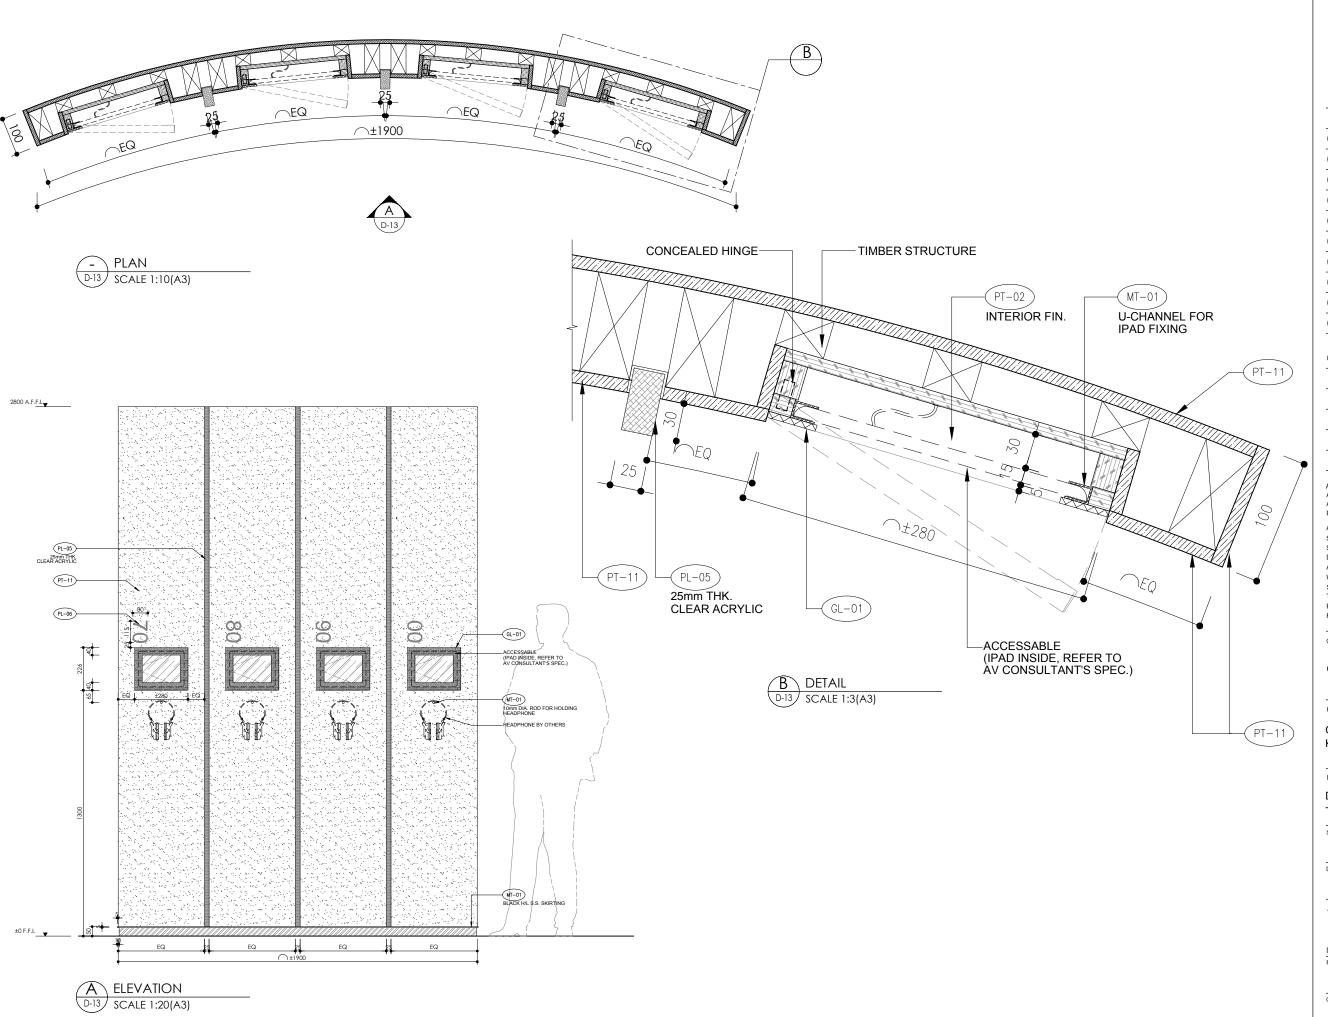



REVISION	ON	
REV.	DESCRIPTION	DATE
\bigcirc		
NOTES		

ALL DESIGN ARE THE PROPERTY OF AL DESIGN & ASSOCIATES LTD. AND CANNOT BE USED WITHOUT THEIR WRITTEN PERMISSION

ALL MEASUREMENT MUST BE VERIFIED ON SITE BEFORE CONSTRUCTION. CONTRACTOR SHALL NOTIFY THE DESIGNER OF ANY DISCREPANCY BEFORE STARTING WORK. AL DESIGN & ASSOCIATES LTD.
WILL NOT RESPONSIBLE FOR ANY ERRORS SHOULD THE CONTRACTOR FAIL TO OBSERVE THIS PROCEDURE. THE CONTRACTOR SHALL BE RESPONSIBLE FOR ANY ERRORS RESULTINGS FROM FAILURE TO DO SO.

CLIENT

CIC Innovation Center (IC)

PROJECT

G/F, 44 Tai Yip Street Kowloon Bay, Hong Kong

DRAWING TITLE

DETAILS -CURVE WALL

SCALE	DATE
AS SHOWN	11 . 05 . 2017
DRAWN BY	DESIGNED BY
JH/ SC	AY


APPROVED B


DATE
PROJECT NO DWG NO


APQ-17-0117 D-13

CAD FILE REF

D09.dwg

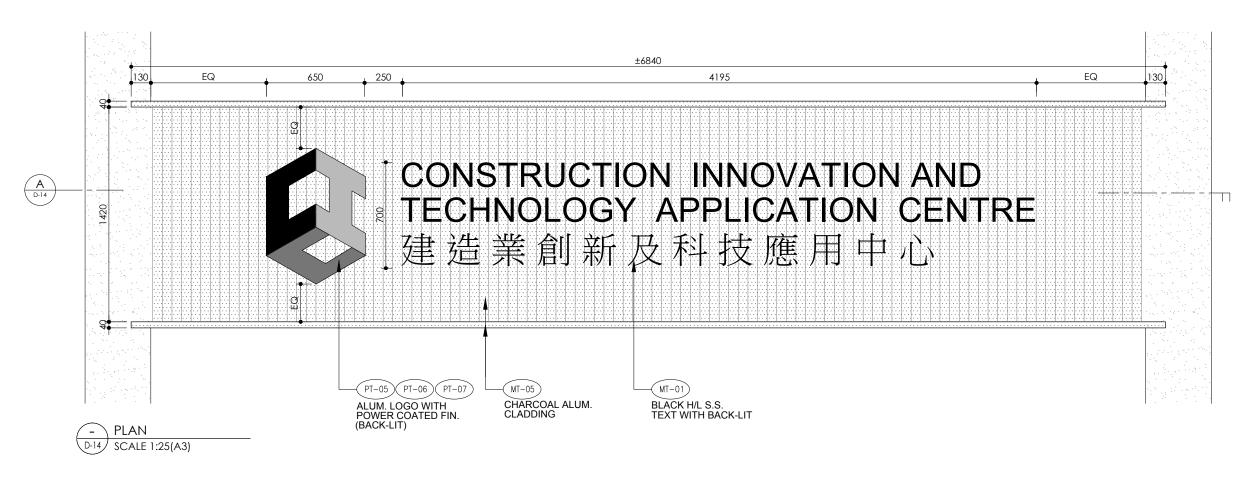

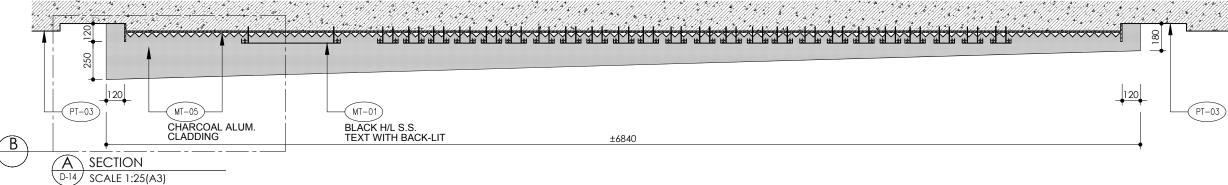

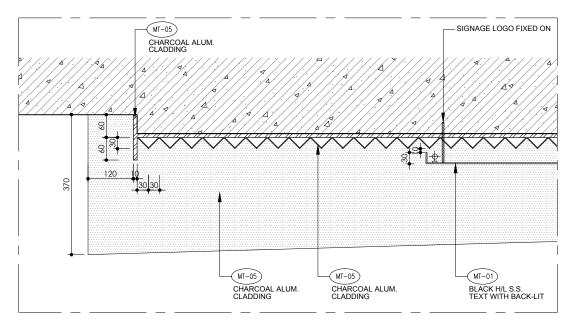






REFERENCE IMAGE

CAD FILE REF



LL DESIGN ARE THE PROPERTY OF L DESIGN & ASSOCIATES LTD. NO CANNOT BE USED WITHOUT THEIR WRITTEN ERMISSION. LL MEASUREMENT MUST BE VERIFIED ON HITE BEFORE CONSTRUCTION. CONTRACTOR HALL NOTIFY THE DESIGNER OF ANY HISCREPANCY BEFORE STARTING WORK. L DESIGN & ASSOCIATES LTD. WILL NOT RESPONSIBLE FOR ANY ERRORS HOULD THE CONTRACTOR FAIL TO OBSERVE HIS PROCEDURE. THE CONTRACTOR SHALL BE RESPONSIBLE FOR ANY ERRORS RESULTINGS ROM FAILURE TO DO SO. LIENT CIC Innovation Center (IC) ROJECT S/F, 44 Tai Yip Street Cowloon Bay, Hong Kong RAWING TITLE DETAILS SIGNBOARD CALE DATE AS SHOWN 11.05.2017	REV.	DESCRIPTION	ı		DATE
LL DESIGN ARE THE PROPERTY OF L DESIGN & ASSOCIATES LTD. ND CANNOT BE USED WITHOUT THEIR WRITTEN ERMISSION. LL MEASUREMENT MUST BE VERIFIED ON ITE BEFORE CONSTRUCTION. CONTRACTOR HALL NOTIFY THE DESIGNER OF ANY DISCREPANCY BEFORE STARTING WORK. L DESIGN & ASSOCIATES LTD. WILL NOT RESPONSIBLE FOR ANY ERRORS HOULD THE CONTRACTOR FAIL TO OBSERVE HIS PROCEDURE. THE CONTRACTOR SHALL BE DESPONSIBLE FOR ANY ERRORS RESULTINGS ROM FAILURE TO DO SO. LIENT CIC Innovation Center (IC) ROJECT G/F, 44 Tai Yip Street Cowloon Bay, Hong Kong PRAWING TITLE DETAILS SIGNBOARD CALE DATE AS SHOWN 11.05.2017		DESCRIPTION	-		DAIL
LL DESIGN ARE THE PROPERTY OF L DESIGN & ASSOCIATES LTD. ND CANNOT BE USED WITHOUT THEIR WRITTEN ERMISSION. LL MEASUREMENT MUST BE VERIFIED ON ITE BEFORE CONSTRUCTION. CONTRACTOR HALL NOTIFY THE DESIGNER OF ANY DISCREPANCY BEFORE STARTING WORK. L DESIGN & ASSOCIATES LTD. WILL NOT RESPONSIBLE FOR ANY ERRORS HOULD THE CONTRACTOR FAIL TO OBSERVE HIS PROCEDURE. THE CONTRACTOR SHALL BE DESPONSIBLE FOR ANY ERRORS RESULTINGS ROM FAILURE TO DO SO. LIENT CIC Innovation Center (IC) ROJECT G/F, 44 Tai Yip Street Cowloon Bay, Hong Kong PRAWING TITLE DETAILS SIGNBOARD CALE DATE AS SHOWN 11.05.2017	\prec				
LL DESIGN ARE THE PROPERTY OF L DESIGN & ASSOCIATES LTD. ND CANNOT BE USED WITHOUT THEIR WRITTEN ERMISSION. LL MEASUREMENT MUST BE VERIFIED ON ITE BEFORE CONSTRUCTION. CONTRACTOR HALL NOTIFY THE DESIGNER OF ANY DISCREPANCY BEFORE STARTING WORK. L DESIGN & ASSOCIATES LTD. WILL NOT RESPONSIBLE FOR ANY ERRORS HOULD THE CONTRACTOR FAIL TO OBSERVE HIS PROCEDURE. THE CONTRACTOR SHALL BE DESPONSIBLE FOR ANY ERRORS RESULTINGS ROM FAILURE TO DO SO. LIENT CIC Innovation Center (IC) ROJECT G/F, 44 Tai Yip Street Cowloon Bay, Hong Kong PRAWING TITLE DETAILS SIGNBOARD CALE DATE AS SHOWN 11.05.2017	\preceq				
LL DESIGN ARE THE PROPERTY OF L DESIGN & ASSOCIATES LTD. ND CANNOT BE USED WITHOUT THEIR WRITTEN ERMISSION. LL MEASUREMENT MUST BE VERIFIED ON ITE BEFORE CONSTRUCTION. CONTRACTOR HALL NOTIFY THE DESIGNER OF ANY DISCREPANCY BEFORE STARTING WORK. L DESIGN & ASSOCIATES LTD. WILL NOT RESPONSIBLE FOR ANY ERRORS HOULD THE CONTRACTOR FAIL TO OBSERVE HIS PROCEDURE. THE CONTRACTOR SHALL BE DESPONSIBLE FOR ANY ERRORS RESULTINGS ROM FAILURE TO DO SO. LIENT CIC Innovation Center (IC) ROJECT G/F, 44 Tai Yip Street Cowloon Bay, Hong Kong PRAWING TITLE DETAILS SIGNBOARD CALE DATE AS SHOWN 11.05.2017	\preceq				
LL DESIGN ARE THE PROPERTY OF L DESIGN & ASSOCIATES LTD. ND CANNOT BE USED WITHOUT THEIR WRITTEN ERMISSION. LL MEASUREMENT MUST BE VERIFIED ON ITE BEFORE CONSTRUCTION. CONTRACTOR HALL NOTIFY THE DESIGNER OF ANY DISCREPANCY BEFORE STARTING WORK. L DESIGN & ASSOCIATES LTD. WILL NOT RESPONSIBLE FOR ANY ERRORS HOULD THE CONTRACTOR FAIL TO OBSERVE HIS PROCEDURE. THE CONTRACTOR SHALL BE DESPONSIBLE FOR ANY ERRORS RESULTINGS ROM FAILURE TO DO SO. LIENT CIC Innovation Center (IC) ROJECT G/F, 44 Tai Yip Street Cowloon Bay, Hong Kong PRAWING TITLE DETAILS SIGNBOARD CALE DATE AS SHOWN 11.05.2017	\supseteq				
LL DESIGN ARE THE PROPERTY OF L DESIGN & ASSOCIATES LTD. ND CANNOT BE USED WITHOUT THEIR WRITTEN ERMISSION. LL MEASUREMENT MUST BE VERIFIED ON ITE BEFORE CONSTRUCTION. CONTRACTOR HALL NOTIFY THE DESIGNER OF ANY DISCREPANCY BEFORE STARTING WORK. L DESIGN & ASSOCIATES LTD. WILL NOT RESPONSIBLE FOR ANY ERRORS HOULD THE CONTRACTOR FAIL TO OBSERVE HIS PROCEDURE. THE CONTRACTOR SHALL BE DESPONSIBLE FOR ANY ERRORS RESULTINGS ROM FAILURE TO DO SO. LIENT CIC Innovation Center (IC) ROJECT G/F, 44 Tai Yip Street Cowloon Bay, Hong Kong PRAWING TITLE DETAILS SIGNBOARD CALE DATE AS SHOWN 11.05.2017	\supseteq				
LL DESIGN ARE THE PROPERTY OF L DESIGN & ASSOCIATES LTD. ND CANNOT BE USED WITHOUT THEIR WRITTEN ERMISSION. LL MEASUREMENT MUST BE VERIFIED ON ITE BEFORE CONSTRUCTION. CONTRACTOR HALL NOTIFY THE DESIGNER OF ANY DISCREPANCY BEFORE STARTING WORK. L DESIGN & ASSOCIATES LTD. WILL NOT RESPONSIBLE FOR ANY ERRORS HOULD THE CONTRACTOR FAIL TO OBSERVE HIS PROCEDURE. THE CONTRACTOR SHALL BE DESPONSIBLE FOR ANY ERRORS RESULTINGS ROM FAILURE TO DO SO. LIENT CIC Innovation Center (IC) ROJECT G/F, 44 Tai Yip Street Cowloon Bay, Hong Kong PRAWING TITLE DETAILS SIGNBOARD CALE DATE AS SHOWN 11.05.2017	\supseteq				
LL DESIGN ARE THE PROPERTY OF L DESIGN & ASSOCIATES LTD. ND CANNOT BE USED WITHOUT THEIR WRITTEN ERMISSION. LL MEASUREMENT MUST BE VERIFIED ON ITE BEFORE CONSTRUCTION. CONTRACTOR HALL NOTIFY THE DESIGNER OF ANY DISCREPANCY BEFORE STARTING WORK. L DESIGN & ASSOCIATES LTD. WILL NOT RESPONSIBLE FOR ANY ERRORS HOULD THE CONTRACTOR FAIL TO OBSERVE HIS PROCEDURE. THE CONTRACTOR SHALL BE DESPONSIBLE FOR ANY ERRORS RESULTINGS ROM FAILURE TO DO SO. LIENT CIC Innovation Center (IC) ROJECT G/F, 44 Tai Yip Street Cowloon Bay, Hong Kong PRAWING TITLE DETAILS SIGNBOARD CALE DATE AS SHOWN 11.05.2017	\bigcirc				
LL DESIGN ARE THE PROPERTY OF L DESIGN & ASSOCIATES LTD. ND CANNOT BE USED WITHOUT THEIR WRITTEN ERMISSION. LL MEASUREMENT MUST BE VERIFIED ON ITE BEFORE CONSTRUCTION. CONTRACTOR HALL NOTIFY THE DESIGNER OF ANY DISCREPANCY BEFORE STARTING WORK. L DESIGN & ASSOCIATES LTD. WILL NOT RESPONSIBLE FOR ANY ERRORS HOULD THE CONTRACTOR FAIL TO OBSERVE HIS PROCEDURE. THE CONTRACTOR SHALL BE DESPONSIBLE FOR ANY ERRORS RESULTINGS ROM FAILURE TO DO SO. LIENT CIC Innovation Center (IC) ROJECT G/F, 44 Tai Yip Street Cowloon Bay, Hong Kong PRAWING TITLE DETAILS SIGNBOARD CALE DATE AS SHOWN 11.05.2017	\bigcirc				
LL DESIGN ARE THE PROPERTY OF L DESIGN & ASSOCIATES LTD. ND CANNOT BE USED WITHOUT THEIR WRITTEN ERMISSION. LL MEASUREMENT MUST BE VERIFIED ON ITE BEFORE CONSTRUCTION. CONTRACTOR HALL NOTIFY THE DESIGNER OF ANY DISCREPANCY BEFORE STARTING WORK. L DESIGN & ASSOCIATES LTD. WILL NOT RESPONSIBLE FOR ANY ERRORS HOULD THE CONTRACTOR FAIL TO OBSERVE HIS PROCEDURE. THE CONTRACTOR SHALL BE DESPONSIBLE FOR ANY ERRORS RESULTINGS ROM FAILURE TO DO SO. LIENT CIC Innovation Center (IC) ROJECT G/F, 44 Tai Yip Street Cowloon Bay, Hong Kong PRAWING TITLE DETAILS SIGNBOARD CALE DATE AS SHOWN 11.05.2017	\bigcirc				
LL DESIGN ARE THE PROPERTY OF L DESIGN & ASSOCIATES LTD. ND CANNOT BE USED WITHOUT THEIR WRITTEN ERMISSION. LL MEASUREMENT MUST BE VERIFIED ON ITE BEFORE CONSTRUCTION. CONTRACTOR HALL NOTIFY THE DESIGNER OF ANY DISCREPANCY BEFORE STARTING WORK. L DESIGN & ASSOCIATES LTD. WILL NOT RESPONSIBLE FOR ANY ERRORS HOULD THE CONTRACTOR FAIL TO OBSERVE HIS PROCEDURE. THE CONTRACTOR SHALL BE DESPONSIBLE FOR ANY ERRORS RESULTINGS ROM FAILURE TO DO SO. LIENT CIC Innovation Center (IC) ROJECT G/F, 44 Tai Yip Street Cowloon Bay, Hong Kong PRAWING TITLE DETAILS SIGNBOARD CALE DATE AS SHOWN 11.05.2017	\bigcirc				
LL DESIGN ARE THE PROPERTY OF L DESIGN & ASSOCIATES LTD. ND CANNOT BE USED WITHOUT THEIR WRITTEN ERMISSION. LL MEASUREMENT MUST BE VERIFIED ON ITE BEFORE CONSTRUCTION. CONTRACTOR HALL NOTIFY THE DESIGNER OF ANY DISCREPANCY BEFORE STARTING WORK. L DESIGN & ASSOCIATES LTD. WILL NOT RESPONSIBLE FOR ANY ERRORS HOULD THE CONTRACTOR FAIL TO OBSERVE HIS PROCEDURE. THE CONTRACTOR SHALL BE DESPONSIBLE FOR ANY ERRORS RESULTINGS ROM FAILURE TO DO SO. LIENT CIC Innovation Center (IC) ROJECT G/F, 44 Tai Yip Street Cowloon Bay, Hong Kong PRAWING TITLE DETAILS SIGNBOARD CALE DATE AS SHOWN 11.05.2017					
L DESIGN & ASSOCIATES LTD. ND CANNOT BE USED WITHOUT THEIR WRITTEN ERMISSION. LLL MEASUREMENT MUST BE VERIFIED ON ITE BEFORE CONSTRUCTION. CONTRACTOR HALL NOTIFY THE DESIGNER OF ANY ISSCREPANCY BEFORE STARTING WORK. L DESIGN & ASSOCIATES LTD. VILL NOT RESPONSIBLE FOR ANY ERRORS SHOULD THE CONTRACTOR FAIL TO OBSERVE HIS PROCEDURE. THE CONTRACTOR SHALL BE ISSPONSIBLE FOR ANY ERRORS ROM FAILURE TO DO SO. LIENT CIC Innovation Center (IC) ROJECT 6/F, 44 Tai Yip Street COWLOON Bay, Hong Kong PRAWING TITLE DETAILS SIGNBOARD CALE DATE AS SHOWN 11.05.2017	OTES				
L DESIGN & ASSOCIATES LTD. ND CANNOT BE USED WITHOUT THEIR WRITTEN ERMISSION. LLL MEASUREMENT MUST BE VERIFIED ON ITE BEFORE CONSTRUCTION. CONTRACTOR HALL NOTIFY THE DESIGNER OF ANY ISSCREPANCY BEFORE STARTING WORK. L DESIGN & ASSOCIATES LTD. VILL NOT RESPONSIBLE FOR ANY ERRORS SHOULD THE CONTRACTOR FAIL TO OBSERVE HIS PROCEDURE. THE CONTRACTOR SHALL BE ISSPONSIBLE FOR ANY ERRORS ROM FAILURE TO DO SO. LIENT CIC Innovation Center (IC) ROJECT 6/F, 44 Tai Yip Street COWLOON Bay, Hong Kong PRAWING TITLE DETAILS SIGNBOARD CALE DATE AS SHOWN 11.05.2017					
L DESIGN & ASSOCIATES LTD. ND CANNOT BE USED WITHOUT THEIR WRITTEN ERMISSION. LLL MEASUREMENT MUST BE VERIFIED ON ITE BEFORE CONSTRUCTION. CONTRACTOR HALL NOTIFY THE DESIGNER OF ANY ISSCREPANCY BEFORE STARTING WORK. L DESIGN & ASSOCIATES LTD. VILL NOT RESPONSIBLE FOR ANY ERRORS SHOULD THE CONTRACTOR FAIL TO OBSERVE HIS PROCEDURE. THE CONTRACTOR SHALL BE ISSPONSIBLE FOR ANY ERRORS ROM FAILURE TO DO SO. LIENT CIC Innovation Center (IC) ROJECT 6/F, 44 Tai Yip Street COWLOON Bay, Hong Kong PRAWING TITLE DETAILS SIGNBOARD CALE DATE AS SHOWN 11.05.2017				<u> </u>	
L DESIGN & ASSOCIATES LTD. ND CANNOT BE USED WITHOUT THEIR WRITTEN ERMISSION. LLL MEASUREMENT MUST BE VERIFIED ON ITE BEFORE CONSTRUCTION. CONTRACTOR HALL NOTIFY THE DESIGNER OF ANY ISSCREPANCY BEFORE STARTING WORK. L DESIGN & ASSOCIATES LTD. VILL NOT RESPONSIBLE FOR ANY ERRORS SHOULD THE CONTRACTOR FAIL TO OBSERVE HIS PROCEDURE. THE CONTRACTOR SHALL BE ISSPONSIBLE FOR ANY ERRORS ROM FAILURE TO DO SO. LIENT CIC Innovation Center (IC) ROJECT 6/F, 44 Tai Yip Street COWLOON Bay, Hong Kong PRAWING TITLE DETAILS SIGNBOARD CALE DATE AS SHOWN 11.05.2017					
L DESIGN & ASSOCIATES LTD. ND CANNOT BE USED WITHOUT THEIR WRITTEN ERMISSION. LLL MEASUREMENT MUST BE VERIFIED ON ITE BEFORE CONSTRUCTION. CONTRACTOR HALL NOTIFY THE DESIGNER OF ANY ISSCREPANCY BEFORE STARTING WORK. L DESIGN & ASSOCIATES LTD. VILL NOT RESPONSIBLE FOR ANY ERRORS SHOULD THE CONTRACTOR FAIL TO OBSERVE HIS PROCEDURE. THE CONTRACTOR SHALL BE ISSPONSIBLE FOR ANY ERRORS ROM FAILURE TO DO SO. LIENT CIC Innovation Center (IC) ROJECT 6/F, 44 Tai Yip Street COWLOON Bay, Hong Kong PRAWING TITLE DETAILS SIGNBOARD CALE DATE AS SHOWN 11.05.2017					
L DESIGN & ASSOCIATES LTD. ND CANNOT BE USED WITHOUT THEIR WRITTEN ERMISSION. LLL MEASUREMENT MUST BE VERIFIED ON ITE BEFORE CONSTRUCTION. CONTRACTOR HALL NOTIFY THE DESIGNER OF ANY ISSCREPANCY BEFORE STARTING WORK. L DESIGN & ASSOCIATES LTD. VILL NOT RESPONSIBLE FOR ANY ERRORS SHOULD THE CONTRACTOR FAIL TO OBSERVE HIS PROCEDURE. THE CONTRACTOR SHALL BE ISSPONSIBLE FOR ANY ERRORS ROM FAILURE TO DO SO. LIENT CIC Innovation Center (IC) ROJECT 6/F, 44 Tai Yip Street COWLOON Bay, Hong Kong PRAWING TITLE DETAILS SIGNBOARD CALE DATE AS SHOWN 11.05.2017					
CIC Innovation Center (IC) ROJECT G/F, 44 Tai Yip Street Cowloon Bay, Hong Kong RAWING TITLE DETAILS SIGNBOARD CALE DATE AS SHOWN 11.05.2017	L DES ND CA PERMIS LL ME SITE B SHALL	IGN & ASSOCIANNOT BE USE SSION. EASUREMENT EFORE CONS' NOTIFY THE	ATES LTD. ED WITHOU MUST BE TRUCTION. DESIGNER	T THEIR WI VERIFIED CONTRAC OF ANY	ON
CIC Innovation Center (IC) ROJECT G/F, 44 Tai Yip Street Cowloon Bay, Hong Kong RAWING TITLE DETAILS SIGNBOARD CALE DATE AS SHOWN 11.05.2017	AL DES AND CAPERMIS ALL ME BITE B BHALL DISCRE AL DES WILL NO BHOUL THIS PE RESPO	IGN & ASSOCI, KNNOT BE USE SSION. EASUREMENT EFORE CONS' NOTIFY THE EPANCY BEFO IGN & ASSOCI, DT RESPONSIE D THE CONTR ROCEDURE. TI NSIBLE FOR A	MUST BE TRUCTION. DESIGNER PRE STARTI ATES LTD. BLE FOR A RACTOR FA HE CONTR/	VERIFIED CONTRACT OF ANY NG WORK NY ERROF IL TO OBS	ON CTOR (. RS SERVE IALL BE
PROJECT B/F, 44 Tai Yip Street Kowloon Bay, Hong Kong PRAWING TITLE DETAILS SIGNBOARD CALE DATE AS SHOWN 11.05.2017	AL DES AND CA PERMIS ALL ME BITE B SHALL DISCRE AL DES WILL NO SHOUL FHIS PE RESPO FROM	IGN & ASSOCI, KNNOT BE USE SSION. EASUREMENT EFORE CONS' NOTIFY THE EPANCY BEFO IGN & ASSOCI, DT RESPONSIE D THE CONTR ROCEDURE. TI NSIBLE FOR A	MUST BE TRUCTION. DESIGNER PRE STARTI ATES LTD. BLE FOR A RACTOR FA HE CONTR/	VERIFIED CONTRACT OF ANY NG WORK NY ERROF IL TO OBS	ON CTOR (. RS SERVE IALL BE
G/F, 44 Tai Yip Street Cowloon Bay, Hong Kong PRAWING TITLE DETAILS SIGNBOARD CALE DATE AS SHOWN 11.05.2017	AL DES AND CA PERMIS ALL ME BITE B SHALL DISCRE AL DES WILL NO SHOUL FHIS PE RESPO FROM	IGN & ASSOCI, KNNOT BE USE SSION. EASUREMENT EFORE CONS' NOTIFY THE EPANCY BEFO IGN & ASSOCI, DT RESPONSIE D THE CONTR ROCEDURE. TI NSIBLE FOR A	MUST BE TRUCTION. DESIGNER PRE STARTI ATES LTD. BLE FOR A RACTOR FA HE CONTR/	VERIFIED CONTRACT OF ANY NG WORK NY ERROF IL TO OBS	ON CTOR (. RS SERVE IALL BE
Cowloon Bay, Hong Kong PRAWING TITLE DETAILS SIGNBOARD CALE DATE AS SHOWN 11.05.2017	AL DES AND CA PERMIS ALL ME SITE B SHALL DISCRE AL DES WILL NO SHOUL FHIS PF RESPO FROM	IGN & ASSOCI, MNOT BE USE SSION. EASUREMENT EFORE CONS' NOTIFY THE EPANCY BEFO IGN & ASSOCI, DT RESPONSIE D THE CONTE ROCEDURE. TI NSIBLE FOR I FAILURE TO I	ATES LTD. ED WITHOU MUST BE TRUCTION. DESIGNER IRE STARTI ATES LTD. BEFOR A BLACTOR FAR HE CONTRA ANY ERRO DO SO.	THEIR W VERIFIED CONTRAC OF ANY NG WORK NY ERROI IL TO OBS ICTOR SH RS RESUL	ON CTOR (. RS SERVE IALL BE
DETAILS SIGNBOARD CALE DATE AS SHOWN 11 . 05 . 2017	AL DES ALL DES ALL ME BITE B BHALL DISCRE ALL DES MILL ME FRICAL	IGN & ASSOCI. MNOOT BE USE SSION. SASUREMENT EFORE CONS' NOTIFY THE EPANCY BEFO IGN & ASSOCI. DT RESPONSIE D THE CONTE ROCEDURE. TI NSIBLE FOR I FAILURE TO I	ATES LTD. ED WITHOU MUST BE TRUCTION. DESIGNER IRE STARTI ATES LTD. BEFOR A BLACTOR FAR HE CONTRA ANY ERRO DO SO.	THEIR W VERIFIED CONTRAC OF ANY NG WORK NY ERROI IL TO OBS ICTOR SH RS RESUL	ON CTOR (. RS SERVE IALL BE
DETAILS SIGNBOARD CALE DATE AS SHOWN 11 . 05 . 2017	AL DES ALL ME BISHALL DISCRETA ALL ME BISHALL DISCRETA AL DES WILL N BISHALL FROM CLIENT CIC PROJECT G/F,	IGN & ASSOCI. MNOT BE USE SSION. EASUREMENT EFORE CONS' NOTIFY THE EFPANCY BEFO IGN & ASSOCI. OT RESPONSIE D THE CONTR ROCEDURE. TI NSIBLE FOR A FAILURE TO I	ATES LTD. ED WITHOU MUST BE TRUCTION. DESIGNER RIPE STARTI ATES LTD. BLE FOR A LACTOR FA HE CONTRY ANY ERRO DO SO.	VERIFIED CONTRACO OF ANY NG WORK NY ERROI ILL TO BE ILL TOR SE ILL TOR SE ILL TOR SE ILL TOR SE RESUL	ON CTOR (. RS SERVE IALL BE
DETAILS SIGNBOARD CALE DATE AS SHOWN 11 . 05 . 2017	AL DES ALL ME BISHALL DISCRETA ALL ME BISHALL DISCRETA AL DES WILL N BISHALL FROM CLIENT CIC PROJECT G/F,	IGN & ASSOCI. MNOT BE USE SSION. EASUREMENT EFORE CONS' NOTIFY THE EFPANCY BEFO IGN & ASSOCI. OT RESPONSIE D THE CONTR ROCEDURE. TI NSIBLE FOR A FAILURE TO I	ATES LTD. ED WITHOU MUST BE TRUCTION. DESIGNER RIPE STARTI ATES LTD. BLE FOR A LACTOR FA HE CONTRY ANY ERRO DO SO.	VERIFIED CONTRACO OF ANY NG WORK NY ERROI ILL TO BE ILL TOR SE ILL TOR SE ILL TOR SE ILL TOR SE RESUL	ON CTOR (. RS SERVE IALL BE
CALE DATE AS SHOWN 11 . 05 . 2017	AL DES ALL ME ALL ME BITTER BI	IGN & ASSOCI. MINOT BE USE SSION. SASUREMENT EFORE CONS' NOTIFY THE EPANCY BEFO IGN & ASSOCI. DT RESPONSIE D THE CONTE ROCEDURE. TI NSIBLE FOR I FAILURE TO I INNOVATION 44 Tai Yip oon Bay,	ATES LTD. ED WITHOU MUST BE TRUCTION. DESIGNER RIPE STARTI ATES LTD. BLE FOR A LACTOR FA HE CONTRY ANY ERRO DO SO.	VERIFIED CONTRACO OF ANY NG WORK NY ERROI ILL TO BE ILL TOR SE ILL TOR SE ILL TOR SE ILL TOR SE RESUL	ON CTOR (. RS SERVE IALL BE
AS SHOWN 11 . 05 . 2017	AL DES AL	IGN & ASSOCI. MNOT BE USE SSION. EASUREMENT EFORE CONS' NOTIFY THE EFPANCY BEFO IGN & ASSOCI. OT RESPONSIE D THE CONTR ACCEDURE. TI NSIBLE FOR A FAILURE TO I	ATES LTD. ED WITHOU MUST BE TRUCTION. DESIGNER RIPE STARTI ATES LTD. BLE FOR A LACTOR FA HE CONTRY ANY ERRO DO SO.	VERIFIED CONTRACO OF ANY NG WORK NY ERROI ILL TO BE ILL TOR SE ILL TOR SE ILL TOR SE ILL TOR SE RESUL	ON CTOR (. RS SERVE IALL BE
	LL DES MAD CASE REPORT OF THE PROJECT OF THE PROJEC	IGN & ASSOCI. MINOT BE USE SSION. EASUREMENT EFORE CONS' NOTIFY THE EPANCY BEFO IGN & ASSOCI. OT RESPONSIE D THE CONTR ROCCEDURE. TI NSIBLE FOR I FAILURE TO I INNOVATION T 44 Tai Yip oon Bay,	ATES LTD. ED WITHOU MUST BE TRUCTION. DESIGNER RIPE STARTI ATES LTD. BLE FOR A LACTOR FA HE CONTRY ANY ERRO DO SO.	VERIFIED CONTRACO OF ANY NG WORK NY ERROI ILL TO BE ILL TOR SE ILL TOR SE ILL TOR SE ILL TOR SE RESUL	ON CTOR (. RS SERVE IALL BE
	LL DES LL DES LL DES LL ME LET BEHALL LISCRE LL DES	IGN & ASSOCI. MINOT BE USE SSION. EASUREMENT EFORE CONS' NOTIFY THE EPANCY BEFO IGN & ASSOCI. OT RESPONSIE D THE CONTR ROCCEDURE. TI NSIBLE FOR I FAILURE TO I INNOVATION T 44 Tai Yip oon Bay,	MUST BE TRUCTION. DESIGNER RES STARTI ATES LTD. BLE FOR A RACTOR FA HE CONTRY. ANY ERRO DO SO.	VERIFIED CONTRACO OF ANY NG WORK NY ERROILL TO OBSECTION OF ANY NO COTOR SHARS RESUL	ON CTOR (. RS SERVE IALL BE
RAWN BY DESIGNED BY	LL DES ND CA ERMIS LLL ME ERMIS LLL ME ERMIS LLL ME ERMIS LLL ME ERMIS LL DES L	IGN & ASSOCI. MINOT BE USE SSION. EASUREMENT EFORE CONS' NOTIFY THE EFPANCY BEFO IGN & ASSOCI. OT RESPONSIE D THE CONTR ROCEDURE. TI NSIBLE FOR I FAILURE TO I INNOVATION T 44 Tai Yip oon Bay, IIIIE AILS NBOARD	MUST BE TRUCTION. DESIGNER RES STARTI ATES LTD. BLE FOR A RACTOR FA HE CONTRY. ANY ERRO DO SO. D Street Hong K	THEIR WIVERIFIED CONTRACO OF ANY NG WORK NY ERROILL TO OBSICTOR SHESS RESUL	ON C. RS SERVE ALL BE ITINGS
JH/ SC AY	LL DES END CASE NO CAS	IGN & ASSOCI. MINOT BE USE SSION. EASUREMENT EFORE CONS' NOTIFY THE EFPANCY BEFO IGN & ASSOCI. OT RESPONSIE DO THE CONTE ROCEDURE. TI NSIBLE FOR A FAILURE TO I THE CONTE THE	MUST BE TRUCTION. DESIGNER RIPE STARTI. ATES LTD. BLE FOR A ACTOR FA HE CONTRY ANY ERRO DO SO. DA DA DA 1	VERIFIED CONTRACO OF ANY NG WORK NY ERROI LITOR SHATE OF A RESULTOR SHATE OF A RESULTO	ON C. RS SERVE ALL BE ITINGS
	LL DES SIND CASE NO CA	IGN & ASSOCIANNOT BE USE SION. EASUREMENT EFORE CONS' NOTIFY THE EPONE IGN & ASSOCIATION	MUST BE TRUCTION. DESIGNER RIPE START! ATES LTD. BLE FOR A RACTOR FA HE CONTRA. ANY ERRO DO SO. D Street Hong K	VERIFIED CONTRACO OF ANY NG WORK NY ERROI ILL TO OBSICTOR SHEET OF CITCO	ON C. RS SERVE ALL BE ITINGS
PPROVED BY	AL DES SAND CASE	IGN & ASSOCI. MINOT BE USE SION. EASUREMENT EFORE CONS' NOTIFY THE PEPANCY BEFO IGN & ASSOCI. OT RESPONSIE OT RESPONSIE TO THE CONTE ROCEDURE. TI NSIBLE FOR / FAILURE TO I INTOVATION THE ALLS NBOARD BY SC	MUST BE TRUCTION. DESIGNER RIPE START! ATES LTD. BLE FOR A RACTOR FA HE CONTRA. ANY ERRO DO SO. D Street Hong K	VERIFIED CONTRACO OF ANY NG WORK NY ERROI ILL TO OBSICTOR SHEET OF CITCO	ON C. RS SERVE ALL BE ITINGS

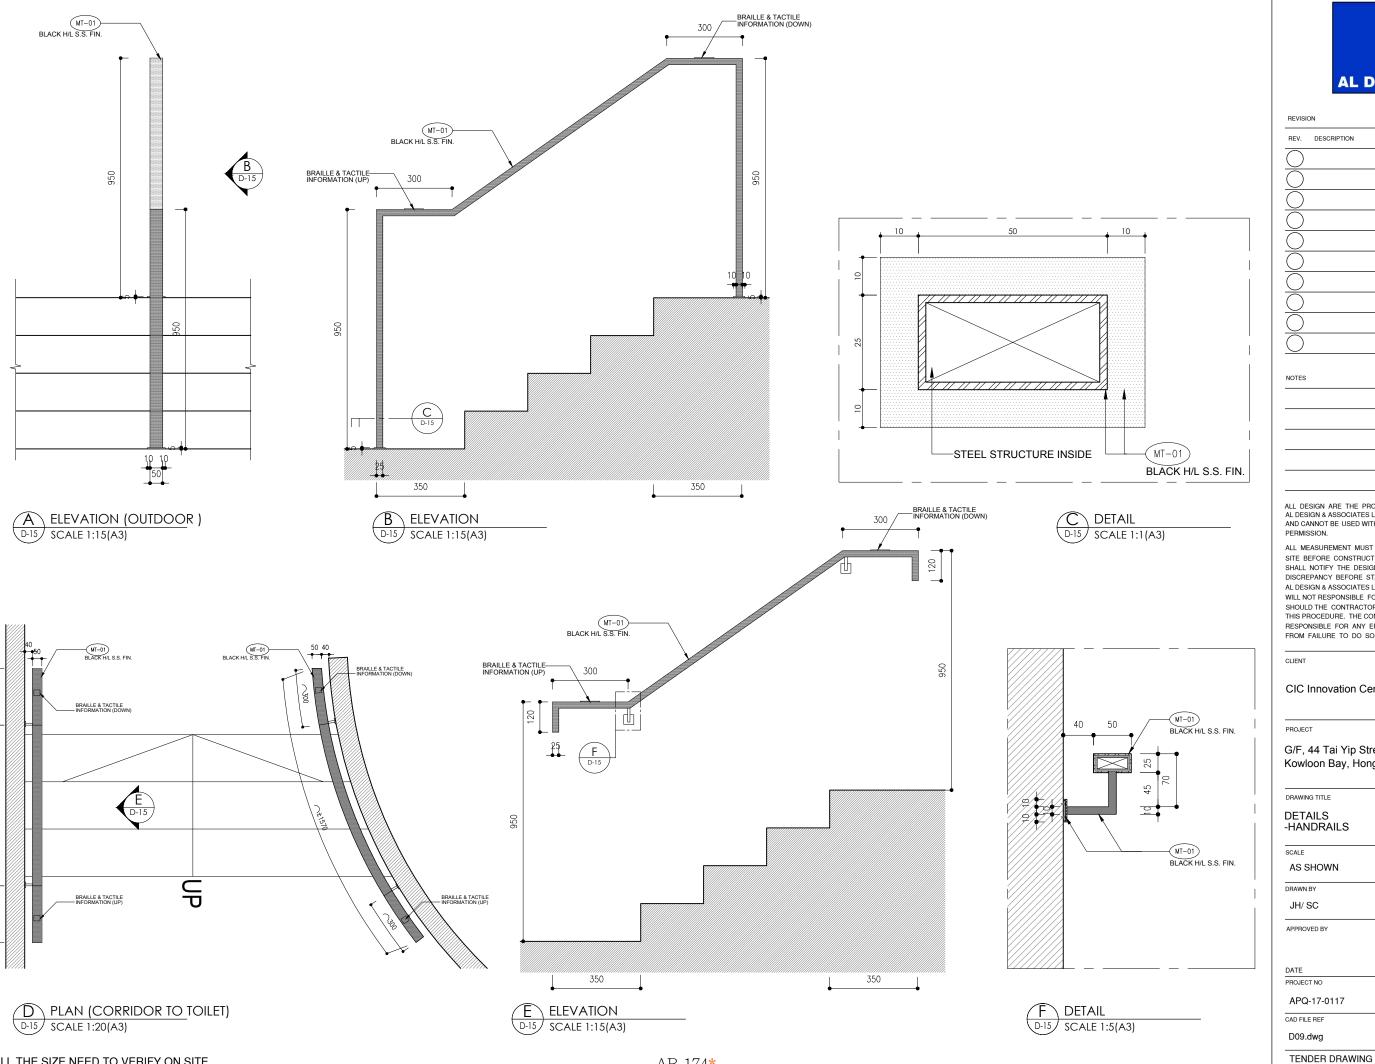



REVISIO	ON	
REV.	DESCRIPTION	DATE
$\overline{\bigcirc}$		
$\overline{\bigcirc}$		
$\overline{\bigcirc}$		
\bigcirc		
\bigcirc		
$\overline{\bigcirc}$		
\bigcirc		
NOTES		
	·	

ALL DESIGN ARE THE PROPERTY OF AL DESIGN & ASSOCIATES LTD.
AND CANNOT BE USED WITHOUT THEIR WRITTEN PERMISSION.

ALL MEASUREMENT MUST BE VERIFIED ON SITE BEFORE CONSTRUCTION. CONTRACTOR SHALL NOTIFY THE DESIGNER OF ANY DISCREPANCY BEFORE STARTING WORK AL DESIGN & ASSOCIATES LTD.
WILL NOT RESPONSIBLE FOR ANY ERRORS SHOULD THE CONTRACTOR FAIL TO OBSERVE THIS PROCEDURE. THE CONTRACTOR SHALL BE RESPONSIBLE FOR ANY ERRORS RESULTINGS FROM FAILURE TO DO SO.

CIC Innovation Center (IC)


G/F, 44 Tai Yip Street Kowloon Bay, Hong Kong

SCALE	DATE
AS SHOWN	11 . 05 . 2017
DRAWN BY	DESIGNED BY
JH/ SC	AY
APPROVED BY	

PROJECT NO	DWG NO
APQ-17-0117	D-15
CAD FILE REF	
D09.dwg	

* ALL THE SIZE NEED TO VERIFY ON SITE


AB-174*

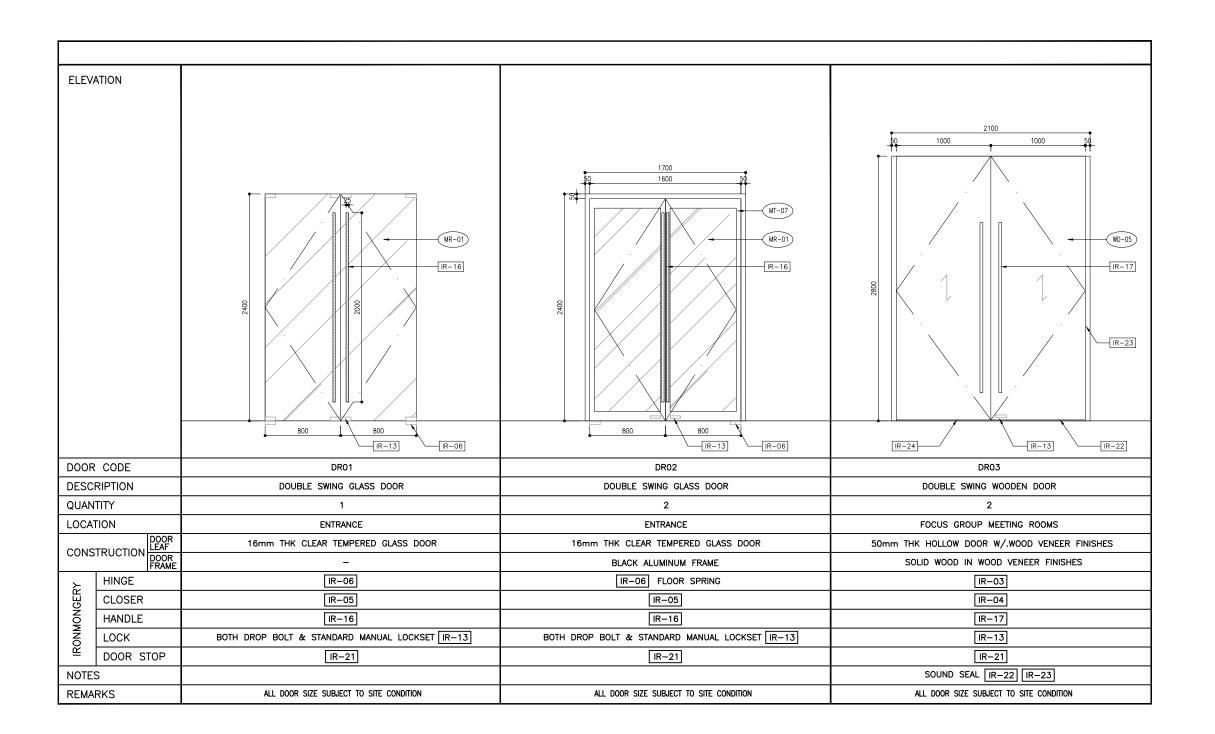

REV.	DESCRIPTION	DA	TE
$\overline{}$			
$\stackrel{<}{\lnot}$			
eq			
eq			
eq			
${\leftarrow}$			
eq			
\neq			
\neq			
\geq			
<u>)</u>			
TES			
IOUL IIS PE SPO	D THE CONTRA ROCEDURE, THE	E FOR ANY ERRORS CTOR FAIL TO OBSERVE E CONTRACTOR SHALL BE NY ERRORS RESULTINGS O SO.	
.IENT			
IC I	Innovation	Center (IC)	
		Center (IC)	
/F,		Street	
/F,	[⊤] 44 Tai Yip	Street	
/F, owl	[⊤] 44 Tai Yip oon Bay, H	Street long Kong	
/F, owl	эт 44 Tai Yip oon Bay, H	Street dong Kong ULE	
OOJECOJECO	эт 44 Tai Yip oon Bay, H	Street long Kong ULE	
/F, owline	HA4 Tai Yip oon Bay, H IGTITLE R SCHEDI D (A3)	Street Hong Kong ULE DATE 11.05.2017 DESIGNED BY	
/F, owline	HA4 Tai Yip oon Bay, H GTITLE R SCHEDI O (A3)	Street Hong Kong ULE DATE 11.05.2017	
OO CALE 1:40	HA4 Tai Yip oon Bay, H GTITLE R SCHEDI O (A3)	Street Hong Kong ULE DATE 11.05.2017 DESIGNED BY	
/F, Fowling Additional Company of the Company of th	HA4 Tai Yip oon Bay, H IGTITLE R SCHEDI D (A3) BY SC	Street Hong Kong ULE DATE 11.05.2017 DESIGNED BY	
OO CALE 1:40	HA4 Tai Yip oon Bay, H IGTITLE R SCHEDI D (A3) BY SC	Street Hong Kong ULE DATE 11.05.2017 DESIGNED BY	


CAD FILE REF

Details (current).dwg

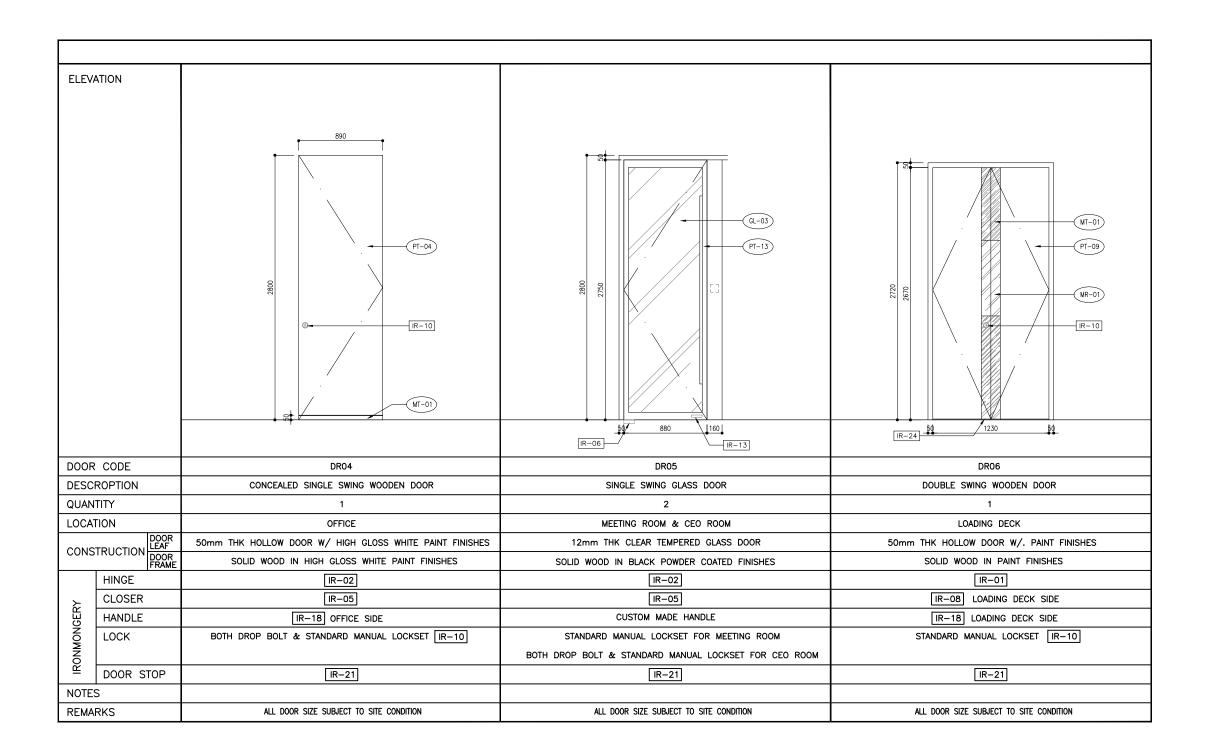


REV. DESCRIPTION	DATE
$\overline{\bigcirc}$	
\bigcirc	
$\stackrel{\smile}{\cap}$	
$\overline{\bigcirc}$	
\bigcirc	
NOTES	
ALL MEASUREMENT MI SITE BEFORE CONSTRI SHALL NOTIFY THE DE DISCREPANCY BEFORE AL DESIGN & ASSOCIATI WILL NOT RESPONSIBLE	UCTION. CONTRACTOR SIGNER OF ANY STARTING WORK. ES LTD. FOR ANY ERRORS
ALL MEASUREMENT MI SITE BEFORE CONSTR SHALL NOTIFY THE DE DISCREPANCY BEFORE AL DESIGN & ASSOCIATI WILL NOT RESPONSIBLE SHOULD THE CONTRAC THIS PROCEDURE. THE RESPONSIBLE FOR AN	UST BE VERIFIED ON UCTION. CONTRACTOR SIGNER OF ANY STARTING WORK. ES LTD. E FOR ANY ERRORS ITOR FAIL TO OBSERVE CONTRACTOR SHALL BE Y ERRORS RESULTINGS
ALL MEASUREMENT MI SITE BEFORE CONSTR SHALL NOTIFY THE DE DISCREPANCY BEFORE AL DESIGN & ASSOCIATI WILL NOT RESPONSIBLE SHOULD THE CONTRAC THIS PROCEDURE. THE RESPONSIBLE FOR AN FROM FAILURE TO DO	UST BE VERIFIED ON UCTION. CONTRACTOR SIGNER OF ANY STARTING WORK. ES LTD. E FOR ANY ERRORS ITOR FAIL TO OBSERVE CONTRACTOR SHALL BE Y ERRORS RESULTINGS
ALL MEASUREMENT MI SITE BEFORE CONSTR SHALL NOTIFY THE DE DISCREPANCY BEFORE AL DESIGN & ASSOCIATI WILL NOT RESPONSIBLE SHOULD THE CONTRAC THIS PROCEDURE. THE RESPONSIBLE FOR AN FROM FAILURE TO DO	UST BE VERIFIED ON UCTION. CONTRACTOR SIGNER OF ANY STARTING WORK. ES LTD. E FOR ANY ERRORS ITOR FAIL TO OBSERVE CONTRACTOR SHALL BE Y ERRORS RESULTINGS SO.
ALL MEASUREMENT MI SITE BEFORE CONSTRI SHALL NOTIFY THE DE DISCREPANCY BEFORE AL DESIGN & ASSOCIATI WILL NOT RESPONSIBLE SHOULD THE CONTRAC THIS PROCEDURE. THE RESPONSIBLE FOR AN FROM FAILURE TO DO	UST BE VERIFIED ON UCTION. CONTRACTOR SIGNER OF ANY STARTING WORK. ES LTD. E FOR ANY ERRORS ITOR FAIL TO OBSERVE CONTRACTOR SHALL BE Y ERRORS RESULTINGS SO.
ALL MEASUREMENT MI SITE BEFORE CONSTR SHALL NOTIFY THE DE DISCREPANCY BEFORE AL DESIGN & ASSOCIATI WILL NOT RESPONSIBLE SHOULD THE CONTRACT THIS PROCEDURE. THE RESPONSIBLE FOR AN FROM FAILURE TO DO CLIENT CIC Innovation (PROJECT G/F, 44 Tai Yip S	UST BE VERIFIED ON UCTION. CONTRACTOR SIGNER OF ANY STARTING WORK. ES LTD. FOR ANY ERRORS STOR ANIL TO OBSERVE CONTRACTOR SHALL BE Y ERRORS RESULTINGS SO. Center (IC)
ALL MEASUREMENT MISITE BEFORE CONSTRISHALL NOTIFY THE DE DISCREPANCY BEFORE AL DESIGN & ASSOCIATIVELL OF THE CONTRACTIVE PROCEDURE. THE RESPONSIBLE FOR AN FROM FAILURE TO DOCLIENT CIC Innovation (PROJECT G/F, 44 Tai Yip S KOWLOON Bay, He	UST BE VERIFIED ON UCTION. CONTRACTOR SIGNER OF ANY STARTING WORK. ES LTD. FOR ANY ERRORS STOR ANIL TO OBSERVE CONTRACTOR SHALL BE Y ERRORS RESULTINGS SO. Center (IC)
ALL MEASUREMENT MISITE BEFORE CONSTRISHALL NOTIFY THE DE DISCREPANCY BEFORE AL DESIGN & ASSOCIATI WILL NOT RESPONSIBLE SHOULD THE CONTRACTHIS PROCEDURE. THE RESPONSIBLE FOR AN FROM FAILURE TO DOCLIENT CIC Innovation (PROJECT G/F, 44 Tai Yip S KOWLOON Bay, HODRAWING TITLE	UST BE VERIFIED ON UCTION. CONTRACTOR SIGNER OF ANY STARTING WORK. ES LTD. FOR ANY ERRORS TOOR FAIL TO OBSERVE CONTRACTOR SHALL BE Y ERRORS RESULTINGS SO. Center (IC) Street ong Kong
ALL MEASUREMENT MISTE BEFORE CONSTRIBUTED THE DEDISCREPANCY BEFORE AL DESIGN & ASSOCIATIVE LICENSE ASSOCIATIVE LICENSE AL DESIGN & ASSOCIATIVE LICENSE AND ASSOCIATIVE LICENSE AL DESIGN & ASSOCIATIVE LICENSE AND ASSOCIATIVE LICENSE AL DESIGN & ASSOCIATIVE LICENSE AND ASS	UST BE VERIFIED ON UCTION. CONTRACTOR SIGNER OF ANY STARTING WORK. ES LTD. FOR ANY ERRORS TOOR FAIL TO OBSERVE CONTRACTOR SHALL BE Y ERRORS RESULTINGS SO. Center (IC) Street ong Kong
ALL MEASUREMENT MISTE BEFORE CONSTRIBUTED THE DEDISCREPANCY BEFORE AL DESIGN & ASSOCIATIVE LICENSE ASSOCIATIVE LICENSE AL DESIGN & ASSOCIATIVE LICENSE AND ASSOCIATIVE LICENSE AL DESIGN & ASSOCIATIVE LICENSE AND ASSOCIATIVE LICENSE AL DESIGN & ASSOCIATIVE LICENSE AND ASS	UST BE VERIFIED ON UCTION. CONTRACTOR SIGNER OF ANY STARTING WORK. ES LTD. FOR ANY ERRORS TOR FAIL TO OBSERVE CONTRACTOR SHALL BE Y ERRORS RESULTINGS SO. Center (IC) Street ong Kong
ALL MEASUREMENT MISTE BEFORE CONSTRIBUTED THE DEDISCREPANCY BEFORE AL DESIGN & ASSOCIATIVELY THE DEDISCREPANCY BEFORE AL DESIGN & ASSOCIATIVELY CONTRACTHIS PROCEDURE. THE RESPONSIBLE FOR AN FROM FAILURE TO DOCLIENT CIC Innovation (PROJECT G/F, 44 Tai Yip S KOWLOON Bay, HODON SCHEDL DRAWING TITLE DOOR SCHEDL SCALE 1:40 (A3)	UST BE VERIFIED ON UCTION. CONTRACTOR SIGNER OF ANY STARTING WORK. ES LTD. FOR ANY ERRORS TOO RAIL TO OBSERVE CONTRACTOR SHALL BE Y ERRORS RESULTINGS SO. Center (IC) Street ong Kong DATE 11.05.2017
ALL MEASUREMENT MISTE BEFORE CONSTRISHALL NOTIFY THE DE DISCREPANCY BEFORE AL DESIGN & ASSOCIATIVELL NOT RESPONSIBLE SHOULD THE CONTRACTHIS PROCEDURE. THE RESPONSIBLE FOR AN FROM FAILURE TO DOCLIENT CIC Innovation (CIC) PROJECT G/F, 44 Tai Yip S KOWIOON BAY, HODON SCHEDLE DOOR SCHEDLE 1:40 (A3) DRAWN BY	UST BE VERIFIED ON UCTION. CONTRACTOR SIGNER OF ANY STARTING WORK. ES LTD. FOR ANY ERRORS TOOR FAIL TO OBSERVE CONTRACTOR SHALL BE Y ERRORS RESULTINGS SO. Center (IC) Street ong Kong JLE DATE 11.05.2017
ALL MEASUREMENT MI SITE BEFORE CONSTR SHALL NOTIFY THE DE DISCREPANCY BEFORE AL DESIGN & ASSOCIATI WILL NOT RESPONSIBLE SHOULD THE CONTRAC THIS PROCEDURE. THE RESPONSIBLE FOR AN FROM FAILURE TO DO CLIENT CIC Innovation (PROJECT G/F, 44 Tai Yip S KOWIOON BAY, He DRAWING TITLE DOOR SCHEDL SCALE 1:40 (A3) DRAWN BY JH/ SC	UST BE VERIFIED ON UCTION. CONTRACTOR SIGNER OF ANY STARTING WORK. ES LTD. FOR ANY ERRORS TOO RAIL TO OBSERVE CONTRACTOR SHALL BE Y ERRORS RESULTINGS SO. Center (IC) Street ong Kong DATE 11.05.2017
ALL MEASUREMENT MISTE BEFORE CONSTRIBUTED THE DEDISCREPANCY BEFORE AL DESIGN & ASSOCIATIVELY THE DEDISCREPANCY BEFORE AL DESIGN & ASSOCIATIVELY CONTRACTHIS PROCEDURE. THE RESPONSIBLE FOR AN FROM FAILURE TO DOCLIENT CIC Innovation (PROJECT G/F, 44 Tai Yip S KOWIOON BAY, HO DRAWING TITLE DOOR SCHEDL SCALE 1:40 (A3) DRAWN BY JH/ SC	UST BE VERIFIED ON UCTION. CONTRACTOR SIGNER OF ANY STARTING WORK. ES LTD. FOR ANY ERRORS TOOR FAIL TO OBSERVE CONTRACTOR SHALL BE Y ERRORS RESULTINGS SO. Center (IC) Street ong Kong JLE DATE 11.05.2017
THIS PROCEDURE. THE RESPONSIBLE FOR AN FROM FAILURE TO DO CLIENT CIC Innovation (PROJECT G/F, 44 Tai Yip S Kowloon Bay, He DRAWING TITLE DOOR SCHEDL SCALE 1:40 (A3) DRAWN BY	UST BE VERIFIED ON UCTION. CONTRACTOR SIGNER OF ANY STARTING WORK. ES LTD. FOR ANY ERRORS TOOR FAIL TO OBSERVE CONTRACTOR SHALL BE Y ERRORS RESULTINGS SO. Center (IC) Street ong Kong JLE DATE 11.05.2017

Details (current).dwg

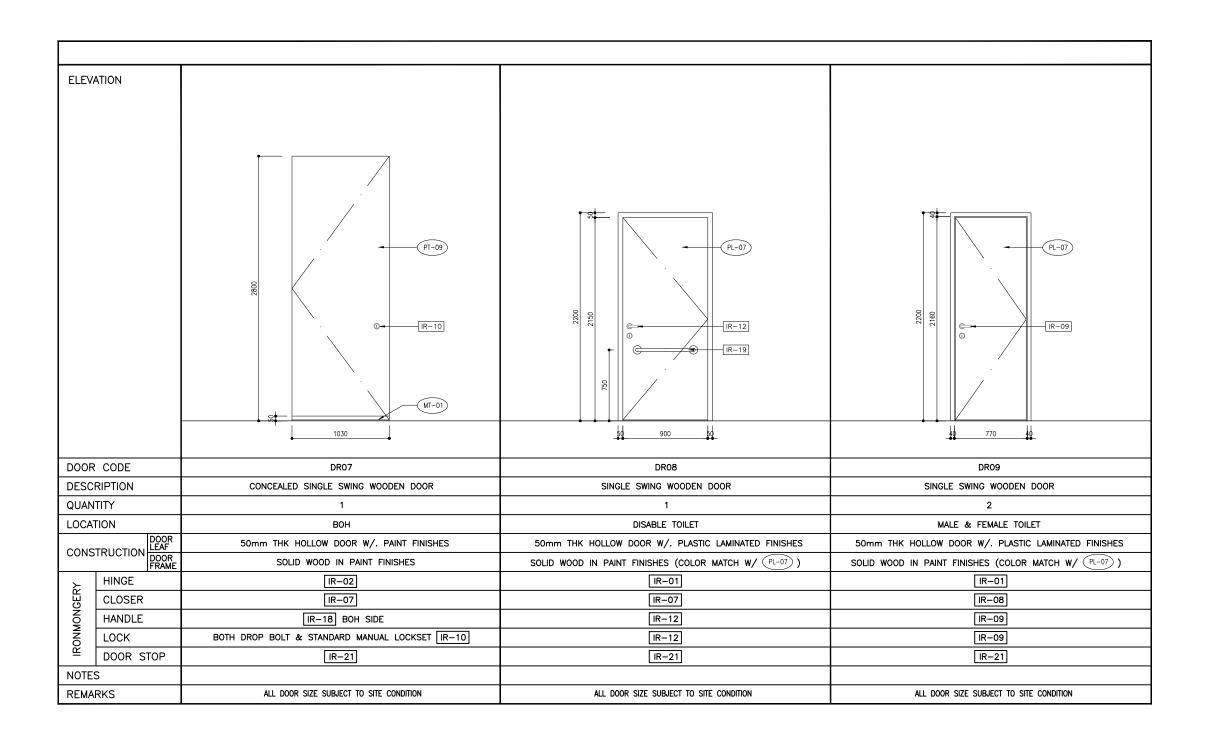

REV. DESCRIPTION	DATE
\bigcap	
$\overline{\bigcirc}$	
$\overline{\bigcirc}$	
$\overline{\bigcirc}$	
\bigcup	
\bigcirc	
NOTES	
ALL MEASUREMENT MU SITE BEFORE CONSTRU SHALL NOTIFY THE DES DISCREPANCY BEFORE AL DESIGN & ASSOCIATE	JCTION. CONTRACTOR SIGNER OF ANY STARTING WORK. SS LTD.
SITE BEFORE CONSTRUSHALL NOTIFY THE DESIDISCREPANCY BEFORE AL DESIGN & ASSOCIATE WILL NOT RESPONSIBLE SHOULD THE CONTRACTHIS PROCEDURE. THE RESPONSIBLE FOR ANY FROM FAILURE TO DO	ICTION. CONTRACTOR SIGNER OF ANY STARTING WORK. SELTD. FOR ANY ERRORS TOR FAIL TO OBSERVE CONTRACTOR SHALL BE ' ERRORS RESULTINGS SO.
SITE BEFORE CONSTRUSHALL NOTIFY THE DESIDISCREPANCY BEFORE AL DESIGN & ASSOCIATE WILL NOT RESPONSIBLE SHOULD THE CONTRACTHIS PROCEDURE. THE RESPONSIBLE FOR ANY FROM FAILURE TO DO	ICTION. CONTRACTOR SIGNER OF ANY STARTING WORK. SELTD. FOR ANY ERRORS TOR FAIL TO OBSERVE CONTRACTOR SHALL BE ' ERRORS RESULTINGS SO.
SITE BEFORE CONSTRUSHALL NOTIFY THE DESIDISCREPANCY BEFORE AL DESIGN & ASSOCIATE WILL NOT RESPONSIBLE SHOULD THE CONTRACTHIS PROCEDURE. THE: RESPONSIBLE FOR ANY FROM FAILURE TO DO	ICTION. CONTRACTOR SIGNER OF ANY STARTING WORK. SELTD. FOR ANY ERRORS TOR FAIL TO OBSERVE CONTRACTOR SHALL BE ' ERRORS RESULTINGS SO.
SITE BEFORE CONSTRUSHALL NOTIFY THE DES DISCREPANCY BEFORE AL DESIGN & ASSOCIATE WILL NOT RESPONSIBLE SHOULD THE CONTRACT THIS PROCEDURE. THE RESPONSIBLE FOR ANY FROM FAILURE TO DO CLIENT CIC Innovation C PROJECT G/F, 44 Tai Yip S	ICTION. CONTRACTOR SIGNER OF ANY STARTING WORK. STA
SITE BEFORE CONSTRUSHALL NOTIFY THE DESIDISCREPANCY BEFORE AL DESIGN & ASSOCIATE WILL NOT RESPONSIBLE SHOULD THE CONTRACTHIS PROCEDURE. THE RESPONSIBLE FOR ANY FROM FAILURE TO DO CLIENT CIC Innovation C PROJECT G/F, 44 Tai Yip S Kowloon Bay, Ho	ICTION. CONTRACTOR SIGNER OF ANY STARTING WORK. STA
SITE BEFORE CONSTRUSHALL NOTIFY THE DESIGNATION BEFORE AL DESIGN & ASSOCIATE WILL NOT RESPONSIBLE SHOULD THE CONTRACTHIS PROCEDURE. THE RESPONSIBLE FOR ANY FROM FAILURE TO DO CLIENT CIC Innovation C PROJECT G/F, 44 Tai Yip S Kowloon Bay, Ho	ICTION. CONTRACTOR SIGNER OF ANY STARTING WORK. SILTD. FOR ANY ERRORS TOR FAIL TO OBSERVE CONTRACTOR SHALL BE ' ERRORS RESULTINGS SO. Center (IC)
SITE BEFORE CONSTRUSHALL NOTIFY THE DESIDISCREPANCY BEFORE AL DESIGN & ASSOCIATE WILL NOT RESPONSIBLE SHOULD THE CONTRACT THIS PROCEDURE. THE RESPONSIBLE FOR ANY FROM FAILURE TO DO CLIENT CIC Innovation C PROJECT G/F, 44 Tai Yip S Kowloon Bay, Ho DRAWING TITLE DOOR SCHEDU	ICTION. CONTRACTOR SIGNER OF ANY STARTING WORK. SILTD. FOR ANY ERRORS TOR FAIL TO OBSERVE CONTRACTOR SHALL BE ' ERRORS RESULTINGS SO. Center (IC)
SITE BEFORE CONSTRUSHALL NOTIFY THE DESIDISCREPANCY BEFORE AL DESIGN & ASSOCIATE WILL NOT RESPONSIBLE SHOULD THE CONTRACT THIS PROCEDURE. THE RESPONSIBLE FOR ANY FROM FAILURE TO DO CLIENT CIC Innovation C PROJECT G/F, 44 Tai Yip S Kowloon Bay, Ho DRAWING TITLE DOOR SCHEDU	ICTION. CONTRACTOR SIGNER OF ANY STARTING WORK. SILTD. FOR ANY ERRORS TOR FAIL TO OBSERVE CONTRACTOR SHALL BE Y ERRORS RESULTINGS SO. Center (IC) Street Ong Kong LE
SITE BEFORE CONSTRISHALL NOTIFY THE DES DISCREPANCY BEFORE AL DESIGN & ASSOCIATE WILL NOT RESPONSIBLE SHOULD THE CONTRACT THIS PROCEDURE. THE RESPONSIBLE FOR ANY FROM FAILURE TO DO CLIENT CIC Innovation C PROJECT G/F, 44 Tai Yip S KOWLOON BAY, HO DRAWING TITLE DOOR SCHEDU SCALE 1:40 (A3)	ICTION. CONTRACTOR SIGNER OF ANY STARTING WORK. SILTD. FOR ANY ERRORS TOR FAIL TO OBSERVE CONTRACTOR SHALL BE Y ERRORS RESULTINGS SO. Center (IC) Street Ong Kong LE
SITE BEFORE CONSTRISHALL NOTIFY THE DES DISCREPANCY BEFORE AL DESIGN & ASSOCIATE WILL NOT RESPONSIBLE SHOULD THE CONTRACT THIS PROCEDURE. THE RESPONSIBLE FOR ANY FROM FAILURE TO DO CLIENT CIC Innovation C PROJECT G/F, 44 Tai Yip S KOWLOON BAY, HO DRAWING TITLE DOOR SCHEDU SCALE 1:40 (A3)	DATE DATE DATE DISTARCTOR DISTARCTOR DATE 11 . 05 . 2017
SITE BEFORE CONSTRISHALL NOTIFY THE DES DISCREPANCY BEFORE AL DESIGN & ASSOCIATE WILL NOT RESPONSIBLE SHOULD THE CONTRACT THIS PROCEDURE. THE RESPONSIBLE FOR ANY FROM FAILURE TO DO CLIENT CIC Innovation C PROJECT G/F, 44 Tai Yip S Kowloon Bay, Ho DRAWING TITLE DOOR SCHEDU SCALE 1:40 (A3) DRAWN BY	DETION. CONTRACTOR SIGNER OF ANY STARTING WORK. SIS LTD. FOR ANY ERRORS TOR FAIL TO OBSERVE CONTRACTOR SHALL BE 'ERRORS RESULTINGS SO. Center (IC) Street Ong Kong LE DATE 11.05.2017
SITE BEFORE CONSTRISHALL NOTIFY THE DES DISCREPANCY BEFORE AL DESIGN & ASSOCIATE WILL NOT RESPONSIBLE SHOULD THE CONTRACT THIS PROCEDURE. THE RESPONSIBLE FOR ANY FROM FAILURE TO DO CLIENT CIC Innovation C PROJECT G/F, 44 Tai Yip S Kowloon Bay, Ho DRAWING TITLE DOOR SCHEDU SCALE 1:40 (A3) DRAWN BY JH/ SC	DETION. CONTRACTOR SIGNER OF ANY STARTING WORK. SIS LTD. FOR ANY ERRORS TOR FAIL TO OBSERVE CONTRACTOR SHALL BE 'ERRORS RESULTINGS SO. Center (IC) Street Ong Kong LE DATE 11.05.2017

Details (current).dwg

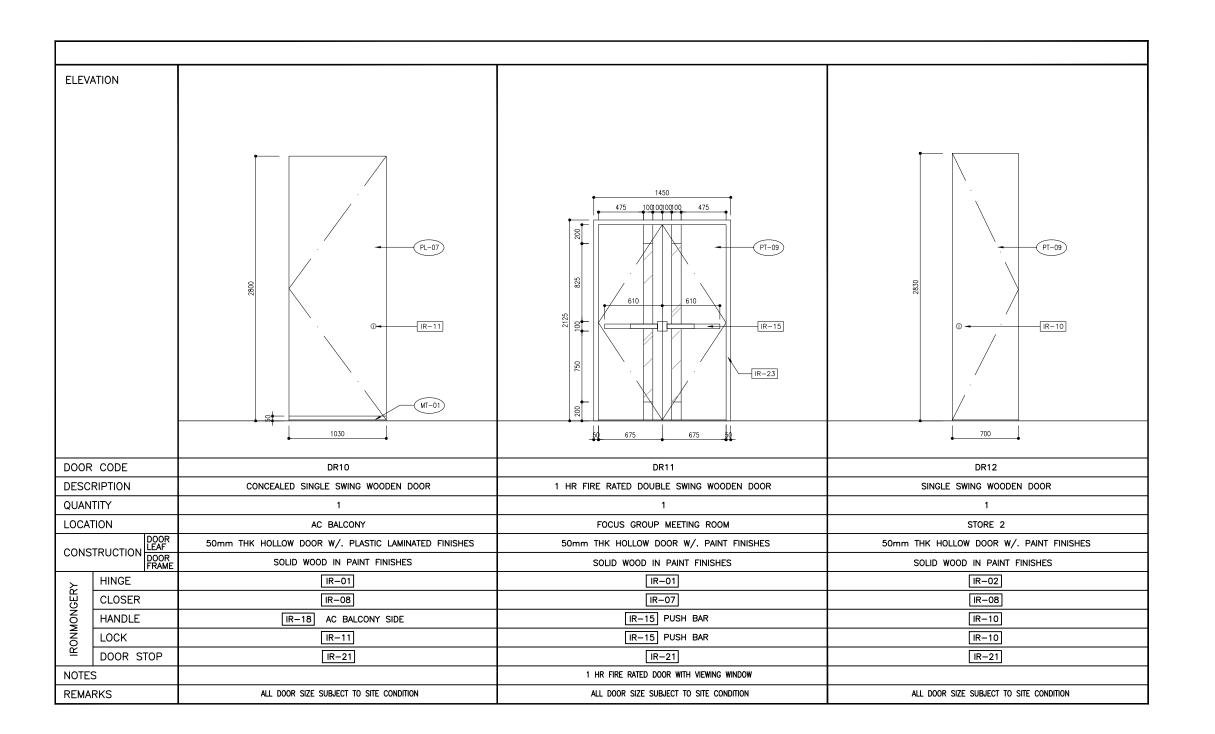

REV.	DESCRIPTION		DATE
$\overline{}$			
\asymp			
\subseteq			
\bigcirc			
\bigcirc			
\bigcirc			
$\overline{\bigcirc}$			
$\check{\bigcirc}$			
$\widetilde{\cap}$			
\preceq			
$\frac{\bigcirc}{\bigcirc}$			
\bigcup			
NOTES			
	IGN & ASSOCIA OT RESPONSIBI	LE FOR ANY ERRORS	
SHOUL THIS PE RESPO	ROCEDURE. TH NSIBLE FOR A	ACTOR FAIL TO OBSER IE CONTRACTOR SHALL NY ERRORS RESULTIN O SO.	. BE
SHOUL THIS PE RESPO FROM	ROCEDURE. TH	IE CONTRACTOR SHALL	. BE
SHOUL THIS PE RESPO FROM CLIENT	ROCEDURE. TH NSIBLE FOR AI FAILURE TO DI	IE CONTRACTOR SHALL	. BE
SHOUL THIS PF RESPO FROM CLIENT	ROCEDURE. TH NSIBLE FOR AI FAILURE TO DI	IE CONTRACTOR SHALL NY ERRORS RESULTIN O SO.	. BE
SHOUL THIS PERESPO FROM CLIENT CIC PROJECT	ROCEDURE. TH NSIBLE FOR A FAILURE TO DO Innovation	IE CONTRACTOR SHALL NY ERRORS RESULTING O SO. Center (IC)	. BE
SHOUL THIS PERESPO FROM CLIENT CIC PROJECT G/F, Kowli	ROCEDURE. TH NSIBLE FOR A FAILURE TO DO Innovation	IE CONTRACTOR SHALL NY ERRORS RESULTING O SO. Center (IC) Street	. BE
SHOUL THIS PRESPO RESPO FROM CLIENT CIC PROJEC G/F, KOWI	Innovation THE TAIL YIP THE	IE CONTRACTOR SHALL NY ERRORS RESULTING O SO. Center (IC) Street Hong Kong	. BE
THIS PROJECT CIC PROJECT G/F, KOWIN DRAWIN	Innovation THE TAIL YIP THE TO BE THE THE TO BE THE	IE CONTRACTOR SHALL NY ERRORS RESULTING O SO. Center (IC) Street Hong Kong	. BE
THIS PROJECT OF THE P	Innovation THE TAIL YIP THE TO BE THE THE TO BE THE	ECONTRACTOR SHALL NY ERRORS RESULTING O SO. Center (IC) Street Hong Kong ULE	BE
THIS PROJECT OF THE P	Innovation 44 Tai Yip oon Bay, H GTITLE R SCHED 0 (A3)	ECONTRACTOR SHALL NY ERRORS RESULTING O SO. Center (IC) Street Hong Kong ULE	BE
THIS PROJECT OF THE P	Innovation THE SCHED O (A3)	ECONTRACTOR SHALL NY ERRORS RESULTING O SO. Center (IC) Street Hong Kong ULE DATE 11.05.20	BE
THIS PERSON THIS	Innovation A44 Tai Yip OON Bay, F R SCHED O (A3) BY SC	ECONTRACTOR SHALL NY ERRORS RESULTING O SO. Center (IC) Street Hong Kong ULE DATE 11.05.20 DESIGNED BY	BE
SHOUL THIS PERSON FROM CIC PROJECT G/F, COMPANIA DOO SCALE 1:40 DRAWN JH/ S APPROV	Innovation A44 Tai Yip OON Bay, F R SCHED O (A3) BY SC	ECONTRACTOR SHALL NY ERRORS RESULTING O SO. Center (IC) Street Hong Kong ULE DATE 11.05.20 DESIGNED BY	BE
SHOUL THIS PROPERTY OF THE SPOND FROM THE SPOND FRO	Innovation THE SCHED O (A3) BY SC ROCCEDURE. THE NSIBLE FOR AIR FAILURE O (A3) BY SC VED BY	ECONTRACTOR SHALL NY ERRORS RESULTING O SO. Center (IC) Street Hong Kong ULE DATE 11.05.20 DESIGNED BY	BE

CAD FILE REF

Details (current).dwg

ELEVA	ATION	## ## ## ## ## ## ## ## ## ## ## ## ##	
	CODE	DR13	
	RIPTION	CONCEALED SINGLE SWING WOODEN DOOR	
QUAN		2	
LOCAT	TON	FOCUS GROUP MEETING ROOM STORAGE	
CONS.	TRUCTION DOOR LEAF DOOR FRAME	50mm THK HOLLOW DOOR W/. PAINT FINISHES	
		SOLID WOOD IN PAINT FINISHES	
<u>₩</u>	HINGE	IR-02	
NGE	CLOSER	IR-08	
IRONMONGERY	HANDLE	CUSTOM MADE	
§	LOCK	IR-13	
	DOOR STOP		
NOTES			
REMA	RKS	ALL DOOR SIZE SUBJECT TO SITE CONDITION	

* ALL THE SIZE NEED TO VERIFY ON SITE

AB-178A*



REVISION	
REV. DESCRIPTION	DATE
\bigcirc	
\bigcirc	
\bigcirc	
\bigcirc	
\bigcirc	
$\overline{\bigcirc}$	
<u> </u>	
NOTES	
LL DESIGN ARE THE PRO LL DESIGN & ASSOCIATES L	.TD.
AND CANNOT BE USED WIT PERMISSION.	HOUT THEIR WRITTEN
ALL MEASUREMENT MUST BITE BEFORE CONSTRUCT	
SHALL NOTIFY THE DESIGNOSCREPANCY BEFORE ST	
AL DESIGN & ASSOCIATES L VILL NOT RESPONSIBLE FO	.TD.
SHOULD THE CONTRACTOR	R FAIL TO OBSERVE
RESPONSIBLE FOR ANY EROM FAILURE TO DO SO	RRORS RESULTINGS
7,123,12 10 20 00	•
CLIENT	
CIC Innovation Ce	nter (IC)
PROJECT	
G/F, 44 Tai Yip Str	eet
Kowloon Bay, Hon	
DRAWING TITLE	
OOR SCHEDULE	Ξ
SCALE	DATE
1:40 (A3)	02 . 06 . 2017
PRAWN BY	DESIGNED BY
JH/ SC	AY
APPROVED BY	
DATE	
PROJECT NO	DWG NO
APQ-17-0117	DR-05
CAD FILE REF	
Details (current).dwg	
TENDER DRAWING	

APQ17-0117

CIC Innovation Center (IC)

MATERIAL SPECIFICATION

LATEST REVISION DATE: 11-05-2017 ISSUE NO.: 2

PROJECT: CIC Innovation Center (IC)

JOB NO.

: APQ17-0117

ISSUE DATE REVISION : 11-05-2017 : A

: A

Code	Material	Description	Location	Supplier	Remarks	Approved
GL-01	Black Glass	6mm THK. Black Glass Panel	Wall at Reception	By contractor		(or equivalent) Sample to be submitted for designer's approval
GL-02	Clear Laminated Glass	16mm THK. Laminated Glass Panel	Façade, Partition for Office	By contractor		(or equivalent) Sample to be submitted for designer's approval
GL-03	Clear Glass	12mm THK. Clear Tempered Glass	Partition for Meeting room & CEO room	By contractor		(or equivalent) Sample to be submitted for designer's approval
GL-04	Clear Glass	8mm THK. Clear Tempered Glass	Cover for Outdoor LED TV	By contractor		(or equivalent) Sample to be submitted for designer's approval
GL-05	White Glass	6mm THK. White Back Painted Glass	Wet Pantry	By contractor		(or equivalent) Sample to be submitted for designer's approval
PL-01	T .	T 11	D	Ci ave advade e		(or oguis glost)
PL-01	Light Grey Vinyl Sheet	Tarkett Concrete/ Chalk 25025 002	Reception & Exhibition Area 1 & 2	Signalplus Mr Chris Pang T: (852) 3918 5510 M: (852) 6179 5088		(or equivalent) Sample to be submitted for designer's approval
PL-02	Grey Vinyl Sheet	Tarkett Concrete/ Cool Grey 25025 000	Reception & Exhibition Area 1 & 2	Signalplus Mr Chris Pang T: (852) 3918 5510 M: (852) 6179 5088		(or equivalent) Sample to be submitted for designer's approval
PL-03	Dark Grey Vinyl Sheet	Tarkett Concrete/ Dark Grey 25025 001	Reception & Exhibition Area 1 & 2	Signalplus Mr Chris Pang T: (852) 3918 5510 M: (852) 6179 5088		(or equivalent) Sample to be submitted for designer's approval
PL-04	Wood-like Vinyl Flooring	Green-Flor Oak contemporary indium grey PE70059	Wet Pantry & Printing Area	Signalplus Mr Chris Pang T: (852) 3918 5510 M: (852) 6179 5088		(or equivalent) Sample to be submitted for designer's approval
PL-05	Clear Acrylic	25mm THK. Clear Acrylic	Exhibition Area 1	By contractor		(or equivalent) Sample to be submitted for designer's approval

PROJECT: CIC Innovation Center (IC)

JOB NO.

: APQ17-0117

ISSUE DATE REVISION

Code	Material	Description	Location	Supplier	Remarks	Approved
PL-06	Grey Acrylic	5mm THK. Grey Acrylic Pantone: Cool Grey 1C	Exhibition Area 1	By contractor		(or equivalent) Sample to be submitted for designer's approval
PL-07	Grey Plastic Laminate	Formica 928 Mouse	Corridor	Formica(Asia) Ltd. Mr Leo Lee T: (852) 2169 8111 F: (852) 2185 7367 M: (852) 6222 3322 Leo.Lee@formica.com		Sample to be submitted for designer's approval
PL-08	Black Plastic Laminate	Formica 0909 Black	Cabinet at Wet Pantry	Formica(Asia) Ltd. Mr Leo Lee T: (852) 2169 8111 F: (852) 2185 7367 M: (852) 6222 3322 Leo.Lee@formica.com		Sample to be submitted for designer's approval
PL-09	Light Grey Plastic Laminate	Formica 0927 Folkstone	Toilet Cubicle	Formica(Asia) Ltd. Mr Leo Lee T: (852) 2169 8111 F: (852) 2185 7367 M: (852) 6222 3322 Leo.Lee@formica.com		Sample to be submitted for designer's approval
PL-10	White Plastic Laminate	Formica 3200 Ultra White	Cabinet at Office	Formica(Asia) Ltd. Mr Leo Lee T: (852) 2169 8111 F: (852) 2185 7367 M: (852) 6222 3322 Leo.Lee@formica.com		Sample to be submitted for designer's approval
MR-01	Clear Mirror	6mm THK. Clear Mirror	Female, Male & Disable Toilet	By Contractor		(or equivalent) Sample to be submitted for designer's approval
MR-02	Black Mirror	6mm thick Black Mirror	Female & Male Toilet	By Contractor		(or equivalent) Sample to be submitted for designer's approval
MT-01	Black Hairline Stainless Steel Plate	316 Black Stainless Steel in Hairline Finish	Railing, General Skirting	By Contractor	NO.	(or equivalent) Sample to be submitted for designer's approval
MT-02	Silver Hairline Stainless Steel Plate	316 Silver Stainless Steel in Hairline Finish (Detail dimension refer to drawing)	General Divider	By Contractor		(or equivalent) Sample to be submitted for designer's approval

PROJECT: CIC Innovation Center (IC)

JOB NO.

: APQ17-0117

ISSUE DATE REVISION : 11-05-2017 : A

Code	Material	Description	Location	Supplier	Remarks	Approved
					•	
MT-03	Light Grey Cladding	Light Grey Cladding Pantone: Cool Grey 1C	Façade Column	By Contractor		(or equivalent) Sample to be submitted for designer's approval
MT-04	Green Cladding	Green Cladding Pantone: 376C	Façade Column	By Contractor		(or equivalent) Sample to be submitted for designer's approval
MT-05	Dark Grey Cladding	Dark Grey Cladding Pantone: Cool Grey 10C	Façade Logo Wall	By Contractor		(or equivalent) Sample to be submitted for designer's approval
MT-06	Black Cladding	Black Cladding Pantone: 425 C	Entrance	By Contractor		(or equivalent) Sample to be submitted for designer's approval
MT-07	Black Aluminum Window Frame	Black Aluminum Window Frame Pantone: 425 C	Facade	By Contractor		(or equivalent) Sample to be submitted for designer's approval
MT-08	White Aluminum Ceiling Tile	White Aluminum Ceiling Tile (Matt Finish) Finish – White on White (Dulux 30GY 88/014)	Female, Male & Disable Toilet	By Contractor		(or equivalent) Sample to be submitted for designer's approval
WD-01	Outdoor Wood	PVC Recycled Plastic Composite Timber Model: PG-DK10025 PVC Color: Walnut Texture: Sanding	Planter & Seating Area	GPM & CO Limited Mr Benny Wong T: (852) 2789 1887 F: (852) 2789 1889 M: (852) 9866 2275 info@gpm.com.hk		(or equivalent) Sample to be submitted for designer's approval
WD-02	Outdoor Wood	PVC Recycled Plastic Composite Timber Model: PG-DK10025 PVC Color: Teak Texture: Sanding	Outdoor Decking	GPM & CO Limited Mr Benny Wong T: (852) 2789 1887 F: (852) 2789 1889 M: (852) 9866 2275 info@gpm.com.hk		(or equivalent) Sample to be submitted for designer's approval
WD-03	Outdoor Wood	PVC Recycled Plastic Composite Timber Model: DK10025 PVC Color: Brown Texture: Sanding	Outdoor Decking	GPM & CO Limited Mr Benny Wong T: (852) 2789 1887 F: (852) 2789 1889 M: (852) 9866 2275 info@gpm.com.hk		(or equivalent) Sample to be submitted for designer's approval

PROJECT: CIC Innovation Center (IC)

JOB NO. ISSUE DATE REVISION : APQ17-0117

Code	Material	Description	Location	Supplier	Remarks	Approved
	•					
WD-04	Wood Veneer Finishes	K 6129AA White Oak **FSC Certified**	Wooden Chair at Lounge	Keding (HK) Enterprises Limited Mr Derek Zhao T: (852) 3689 0417 F: (852) 3689 0418 M: (852) 5616 6367 hk@twkd.com		(or equivalent) Sample to be submitted for designer's approval
WD-05	Wood Veneer Finishes	K 6309 Dyed Oak **FSC Certified**	Door at Exhibition Area 2	Keding (HK) Enterprises Limited Mr Derek Zhao T: (852) 3689 0417 F: (852) 3689 0418 M: (852) 5616 6367 hk@twkd.com		(or equivalent) Sample to be submitted for designer's approval
WD-06	Wood Veneer Finishes	K 6160AN Eucalyptus **FSC Certified**	High Bar Table	Keding (HK) Enterprises Limited Mr Derek Zhao T: (852) 3689 0417 F: (852) 3689 0418 M: (852) 5616 6367 hk@twkd.com		(or equivalent) Sample to be submitted for designer's approval
PT-01	White Paint	ECO Flesh Clean Paint Matt Finish White on White (Color match with Dulux 30GY 88/ 014)	General Wall Finishes	SSK (Hong Kong) Co Ltd Ms Kara Kam T: (852) 2529 3968 M: (852) 6892 0961		(or equivalent) Sample to be submitted for designer's approval
PT-02	Charcoal Grey Paint	ECO Flesh Clean Paint Manor House (Color match with Dulux 50YR 08/ 038)	General Ceiling	SSK (Hong Kong) Co Ltd Ms Kara Kam T: (852) 2529 3968 M: (852) 6892 0961		(or equivalent) Sample to be submitted for designer's approval
PT-03	Exterior Paint	Grey Exterior Paint (Dulux Pro Weathershield Dolphin 20278)	Facade	By Contractor		(or equivalent) Sample to be submitted for designer's approval
PT-04	High Gloss White Paint	ECO Flesh Clean Paint High Gloss White Paint Finishes (Color match with Dulux 30GY 88/014)	Wall at Reception	SSK (Hong Kong) Co Ltd Ms Kara Kam T: (852) 2529 3968 M: (852) 6892 0961		(or equivalent) Sample to be submitted for designer's approval
PT-05	Green Paint	Green Spray Paint Pantone: 376C	Logo Wall	By Contractor		(or equivalent) Sample to be submitted for designer's approval
PT-06	Grey Paint	Grey Spray Paint Pantone: Cool Gray 7C	Logo Wall	By Contractor		(or equivalent) Sample to be submitted for designer's approval

PROJECT: CIC Innovation Center (IC)

JOB NO. ISSUE DATE REVISION : APQ17-0117

Code	Material	Description	Location	Supplier	Remarks	Approved
PT-07	Dark Grey Spray Paint	Dark Grey Spray Paint Pantone: Cool Grey 10C	Logo Wall	By Contractor		(or equivalent) Sample to be submitted for designer's approval
PT-08	Projection Paint	Screen Goo High Contrast Finish Coat	Exhibition Area 1 & 2	Pacific DataCom (Hong Kong) Limited Mr Eddie Choy T: (852) 2303 0018 F: (852) 2303 1633 M: (852) 9255 7173 eddie@pdcl.com		(or equivalent) Sample to be submitted for designer's approval
PT-09	Charcoal Grey Paint	ECO Flesh Clean Paint Manor House (Color match with Dulux 50YR 08/ 038)	General Wall	By Contractor		(or equivalent) Sample to be submitted for designer's approval
PT-10	White Powder Coated Paint	ECO Flesh Clean Paint White Powder Coated Paint Finishes (30%) White on White (Color match with Dulux 30GY 88/014)	Feature Wall at Exhibition Area 1	By Contractor		(or equivalent) Sample to be submitted for designer's approval
PT-11	Special Paint	Rasato Fine #M6007	Exhibition Area 1 & Corridor	Paintech Building Materials Co. Limited Mr Felix Ho T: (852) 2865 0777 F: (852) 2865 0198 M: (852) 6335 3061 felix@paintech.asia		(or equivalent) Sample to be submitted for designer's approval
PT-12	Grey Enamel Paint	Grey Enamel Paint Granite Grey (Dulux 00NN 37/000)	Entrance Gate	By Contractor		(or equivalent) Sample to be submitted for designer's approval
PT-13	Black Powder Coated Paint	Black Powder Coated Paint Finishes Deep Onyx (Dulux 00NN 07/000)	Door & Window Frame at Office	By Contractor		(or equivalent) Sample to be submitted for designer's approval
PT-14	Beige Paint	ECO Flesh Clean Paint (Color match with Dulux 30YY 44/ 114)	Focus Group Meeting Rooms	SSK (Hong Kong) Co Ltd Ms Kara Kam T: (852) 2529 3968 M: (852) 6892 0961		(or equivalent) Sample to be submitted for designer's approval
ST-01	Corian	White Corian GW101 (Glacier White)	Reception Counter, Basin Counter at Toilet & Counter top at Wet Pantry	Cambridge Ms Doris Chuang T: (852) 2392 6631 F: (852) 3743 6142 M: (852)9415 3180		(or equivalent) Sample to be submitted for designer's approval

PROJECT: CIC Innovation Center (IC)

JOB NO.

: APQ17-0117

ISSUE DATE REVISION

Code	Material	Description	Location	Supplier	Remarks	Approved
			,			
ST-02	Corian	Black Corian DN 902 (Nocturne)	Reception Counter	Cambridge Ms Doris Chuang T: (852) 2392 6631 F: (852) 3743 6142 M: (852)9415 3180		(or equivalent) Sample to be submitted for designer's approval
ST-03	Concreate Floor	Match with the Pavement	Entrance	By Contractor		(or equivalent) Sample to be submitted for designer's approval
ST-04	Light Grey Granite		Seat Bench	By Contractor		(or equivalent) Sample to be submitted for designer's approval
WP-01	White Board Sticker	Magwall Screen	Focus Group Meeting Room 1 & 2	Tak Lee Decoration Material Ltd. Mr Kevin Lee T: (852) 2399 0898 F: (852) 2399 0547 M: (852)9665 1176 sales@takleewallpaper.com		(or equivalent) Sample to be submitted for designer's approval
WP-02	Beige Wall- paper	AF 1346	Focus Group- Meeting Room- 1-&-2			
WP-03	Charcoal Grey Sticker	Metallic Hairline AR - 1726	Focus Group Meeting Room 1 & 2	Cobelco Industrial Supplies Ltd. Mr. Christopher Ko T: (852) 3702 6206 F: (852) 3705 1010 M: (852)6016 3056 chris@cobelco.com.hk		(or equivalent) Sample to be submitted for designer's approval
WP-04	Film Sticker		Entrance	By Contractor		(or equivalent) Sample to be submitted for designer's approval
WP-05	Acoustic Panel	ECHO PANEL 101 (FREQUENCY)	CEO room & Meeting room	Infinity Finishes Ltd. Mr. Chris Yip T: (852) 3765 0902 M: (852)6339 7571		(or equivalent) Sample to be submitted for designer's approval
WP-06	3M™ Projection Screen	Whiteboard Film PWF-500	Exhibition Area 1	Pacific DataCom (Hong Kong) Limited Mr Eddie Choy T: (852) 2303 0018 F: (852) 2303 1633 M: (852) 9255 7173 eddie@pdcl.com		(or equivalent) Sample to be submitted for designer's approval

MATERIAL SPECIFICATION

PROJECT: CIC Innovation Center (IC)

JOB NO. ISSUE DATE REVISION : APQ17-0117

: 11-05-2017 : A

Code	Material	Description	Location	Supplier	Remarks	Approved
CP-01	Light Grey Carpet	Interface Colour me 24oz - Smoke 1681-007-000	Focus Group Meeting Room 1 & 2 Office Area	Modular Space Ltd Mr Romeo Cheung T: (852) 2239 0716 F: (852) 2893 3881 M: (852)6344 3216 romeocheng@modularspace. com.hk		(or equivalent) Sample to be submitted for designer's approval
CP-02	Grey Carpet	Interface Colour me 24oz - Pebble 1681-005-000	Focus Group Meeting Room 1 & 2 Office Area	Modular Space Ltd Mr Romeo Cheung T: (852) 2239 0716 F: (852) 2893 3881		(or equivalent) Sample to be submitted for designer's

		1681-005-000	Office Area	1: (852) 2239 0/16 F: (852) 2893 3881 M: (852)6344 3216 romeocheng@modularspace. com.hk	designer's approval
CP-03	Dark Grey Carpet	Interface Colour me 24oz - Graphite 1681-002-000	Focus Group Meeting Room 1 & 2 Office Area	Modular Space Ltd Mr Romeo Cheung T: (852) 2239 0716 F: (852) 2893 3881 M: (852)6344 3216 romeocheng@modularspace. com.hk	(or equivalent) Sample to be submitted for designer's approval
TL-01	Grey Tile	DAUGRES Fusion – Grigio R11 600 x 600	Female, Male & Disable Toilet	BENTA(Global) Co., Ltd. Mr Alex Lee T: (852) 3620 3281	(or equivalent) Sample to be submitted for

1L-01	Grey Tile	Fusion – Grigio R11 600 x 600	remale, Male & Disable Toilet	BENTA(Global) Co., Ltd. Mr Alex Lee T: (852) 3620 3281 M: (852) 6176 2079 leealex@benta-global.com	Sample to be submitted for designer's approval
TL-02	Dark Grey Tile	DAUGRES Ancientstone Antracite STR R12 600 x 600	Corridor	BENTA(Global) Co., Ltd. Mr Alex Lee T: (852) 3620 3281 M: (852) 6176 2079 leealex@benta-global.com	(or equivalent) Sample to be submitted for designer's approval

APQ17-0117

CIC Innovation Center (IC)

IRONMONGERY SPECIFICATION

LATEST REVISION DATE: 01-05-2017 ISSUE NO.: 1



Project: CIC In	novation Center (IC)	Project No. Latest Rev. Date Issue No.	: :	APQ17-0117 01-05-2017 1
Code	Ironmongery Type	First Issue Date	Rev. Date	Rev.
IR-01	Hinge	01-05-2017	-	-
IR-02	Concealed Hinge	01-05-2017	-	-
IR-03	Concealed Hinge	01-05-2017	-	-
IR-04	Concealed Closer	01-05-2017	-	-
IR-05	Concealed Closer	01-05-2017	-	-
IR-06	Floor Spring	01-05-2017	-	-
IR-07	Closer	01-05-2017	-	-
IR-08	Closer	01-05-2017	-	-
IR-09	Lockset	01-05-2017	-	-
IR-10	Lockset	01-05-2017	-	-
IR-11	Lockset	01-05-2017	-	-
IR-12	Lockset	01-05-2017	-	-
IR-13	Lockset	01-05-2017	-	-
IR-14	Concealed Mortise Deadbolt Lock	01-05-2017	-	-
IR-15	Alarm Exit Control Lock	01-05-2017	-	-
IR-16	Pull Handle	01-05-2017	-	-
IR-17	Pull Handle	01-05-2017	-	-
IR-18	Pull Handle	01-05-2017	-	-
IR-19	Grab Bar	01-05-2017	-	-
IR-20	Folding Safety Grab Bar	01-05-2017	-	-
IR-21	Door Stopper	01-05-2017	-	-
IR-22	Drop Seal	01-05-2017	-	-
IR-23	Batwing Seal	01-05-2017	-	-
IR-24	Flush Bolt	01-05-2017	-	-
IR-25	Flush Bolt	01-05-2017	-	-
IR-26	Door Selector	01-05-2017	-	-
IR-27	Hinge	01-05-2017	-	-
IR-28	Sliding track	01-05-2017	-	-

Project: CIC Innovation Center (IC) Project No. APQ17-0117

First Issue Date 01-05-2017

Rev. Rev. Date

Code IR-01

Location Refer to Ironmongery Schedule and Drawings

Ironmongery Type Hinge

"BSW" 804-STD/316 Model

BSW 804-STD/316 full mortise stainless steel butt hinge, 114x102x3mm, AWS,AISI 316 satin S.S. Description

finish, for door weight up to 160kg, Tested to EN1935:2002Classification 4-7-7-1-1-1-14

Colour AISI 316 Satin S.S. finish

Opening Angle Self Closing N/A Hold Open N/A **Closing Force** N/A **Door Thickness** 50mm Max. Door Weight 160kg

/Load Bearing

Max. Door Width N/A Sound Proofing Level : N/A Fire Rated N/A Master Kev N/A Break N/A Country of Origin

Supplier Tung Fat Ho Building Material Ltd.

Contact Mr. Kevin Lau

Tel. O: (852) 3620 2781; M: (852) -

Fax. (852) 3580 0718

Email kevin.lau@tfhbml.com.hk

Remark Contractor is not bound to the specified supplier. Alternative or equivalent may be acceptable.

- Contractor shall verify and ensure all door ironmongery to be suitable and sufficient to perform their required function and to have adequate strength for their purpose.
- 3. Contractor shall ensure all ironmongery used to comply with local regulations.
- Pictorial dimension are for reference only. Contractor is required to verify suitable dimension of hardware.
- Contractor shall verify the left / right hand of the ironmongery if necessary according to the door swing





Project: CIC Innovation Center (IC) Project No. APQ17-0117

First Issue Date 01-05-2017

Rev. Rev. Date

Code IR-02

Location Refer to Ironmongery Schedule and Drawings

Ironmongery Type **Concealed Hinge** : DX 101 3-D Model

: "BaSys" DX 101 3-D concealed hinge, max loading 100kg / 3 dimensionaladjustable, Description

size:180mm x 30mm X30mm, in satin nickel plated finish. (withscrews, Torx 4.2x50)

Colour Satin Nickel Plated finish

Opening Angle Self Closing N/A Hold Open N/A Closing Force N/A **Door Thickness** : N/A Max. Door Weight 100kg

/Load Bearing

Max. Door Width N/A Sound Proofing Level: N/A Fire Rated N/A Master Key N/A Break : N/A Country of Origin

Supplier Tung Fat Ho Building Material Ltd.

Contact Mr. Kevin Lau


Tel. O: (852) 3620 2781; M: (852) -

Fax. (852) 3580 0718

Email kevin.lau@tfhbml.com.hk

Remark Contractor is not bound to the specified supplier. Alternative or equivalent may be acceptable.

- Contractor shall verify and ensure all door ironmongery to be suitable and sufficient to perform their required function and to have adequate strength for their purpose.
- Contractor shall ensure all ironmongery used to comply with local regulations.
- Pictorial dimension are for reference only. Contractor is required to verify suitable dimension of hardware.
- Contractor shall verify the left / right hand of the ironmongery if necessary according to the door swing.

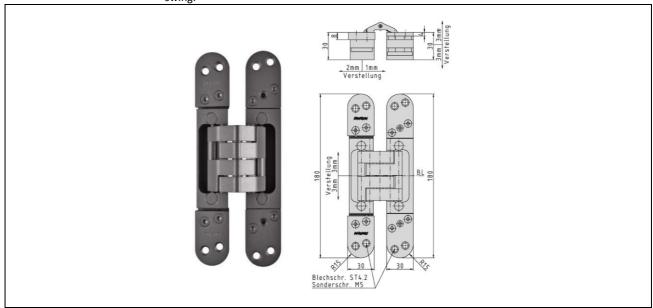



Project: CIC Innovation Center (IC) Project No. APQ17-0117

First Issue Date 01-05-2017

Rev. Rev. Date

: IR-03 Code

Location Refer to Ironmongery Schedule and Drawings

Ironmongery Type : Concealed Hinge : BaSys DX 101 3-D Model

"BaSys" DX 180 3-D Concealed hinge, max loading 180kg / 2 hinge, size:235mm x 37mm X 45mm, Description

in satin nickel plated finish. (without screws -usePhilips screw x8, 5.2x50)

: Satin Nickel Plated finish Colour

Opening Angle **Self Closing** : N/A Hold Open N/A Closing Force N/A **Door Thickness** 50mm Max. Door Weight N/A

/Load Bearing

Max. Door Width : N/A Sound Proofing Level : N/A : N/A Fire Rated Master Key N/A Break N/A Country of Origin :

Tung Fat Ho Building Material Ltd. Supplier

Contact : Mr. Kevin Lau


Tel. : O: (852) 3620 2781; M: (852) -

Fax. (852) 3580 0718

Email kevin.lau@tfhbml.com.hk

Remark 1. Contractor is not bound to the specified supplier. Alternative or equivalent may be acceptable.

- 3. Contractor shall ensure all ironmongery used to comply with local regulations.
- Pictorial dimension are for reference only. Contractor is required to verify suitable dimension of hardware.
- Contractor shall verify the left / right hand of the ironmongery if necessary according to the door 5. swing

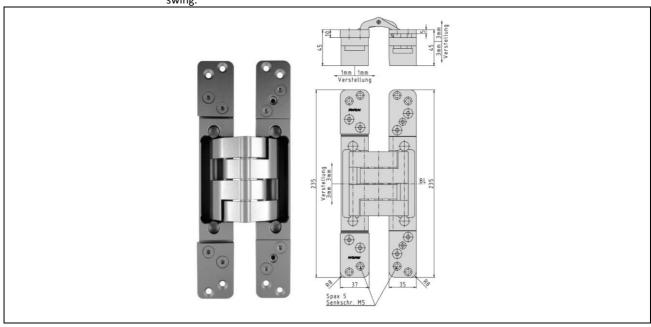

Project: CIC Innovation Center (IC) Project No. : APQ17-0117

First Issue Date : 01-05-2017

Rev. : Rev. Date : -

Code : IR-04

Location : Refer to Ironmongery Schedule and Drawings

Ironmongery Type : Concealed Closer Model : Doma ITS96

Description : "Dorma" ITS96-HO cam action concealed door closer, size EN3-6, w/ hold open device, w/ G96N slide

arm & channel assembly, non handed, in silver finish.

Colour : Silver finish

Opening Angle : Self Closing : N/A
Hold Open : N/A
Closing Force : N/A
Door Thickness : 50mm
Max. Door Weight : N/A

/Load Bearing Max. Door Wid

Max. Door Width : N/A
Sound Proofing Level : N/A
Fire Rated : N/A
Master Key : N/A
Break : N/A
Country of Origin : -

Supplier : Tung Fat Ho Building Material Ltd.

Contact : Mr. Kevin Lau


Tel. : O: (852) 3620 2781 ; M: (852) -

Fax. : (852) 3580 0718

Email : kevin.lau@tfhbml.com.hk

Remark : 1. Contractor is not bound to the specified supplier. Alternative or equivalent may be acceptable.

- 2. Contractor shall verify and ensure all door ironmongery to be suitable and sufficient to perform their required function and to have adequate strength for their purpose.
- 3. Contractor shall ensure all ironmongery used to comply with local regulations.
- 4. Pictorial dimension are for reference only. Contractor is required to verify suitable dimension of hardware.
 - Contractor shall verify the left / right hand of the ironmongery if necessary according to the door swing.

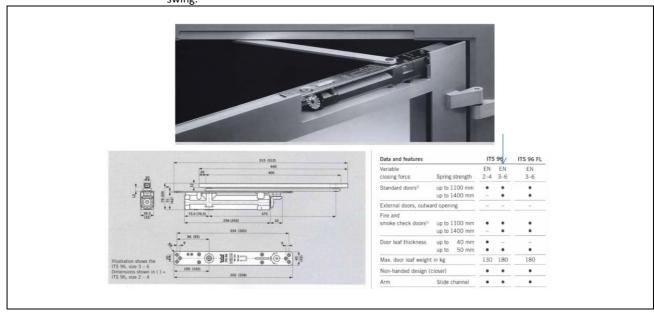

Project: CIC Innovation Center (IC) APQ17-0117 Project No.

First Issue Date 01-05-2017

Rev. Date

Code IR-05

Location Refer to Ironmongery Schedule and Drawings

Ironmongery Type **Concealed Closer** : Dorma ITS96 Model

"Dorma" ITS96-HO cam action concealed door closer, size EN2-4, w/ hold open device, w/ G96N slide Description

arm & channel assembly, non handed, in silver finish.

Silver Finish Colour

Opening Angle **Self Closing** N/A Hold Open N/A **Closing Force** N/A **Door Thickness** 50mm Max. Door Weight N/A

/Load Bearing

Max. Door Width N/A Sound Proofing Level : N/A N/A Fire Rated N/A Master Key Break N/A Country of Origin

Supplier Tung Fat Ho Building Material Ltd.

Contact Mr. Kevin Lau


Tel. O: (852) 3620 2781; M: (852) -

Fax. (852) 3580 0718

Email kevin.lau@tfhbml.com.hk

Contractor is not bound to the specified supplier. Alternative or equivalent may be acceptable. Remark

- Contractor shall verify and ensure all door ironmongery to be suitable and sufficient to perform their required function and to have adequate strength for their purpose.
- Contractor shall ensure all ironmongery used to comply with local regulations.
- Pictorial dimension are for reference only. Contractor is required to verify suitable dimension of hardware.
- Contractor shall verify the left / right hand of the ironmongery if necessary according to the door swing.

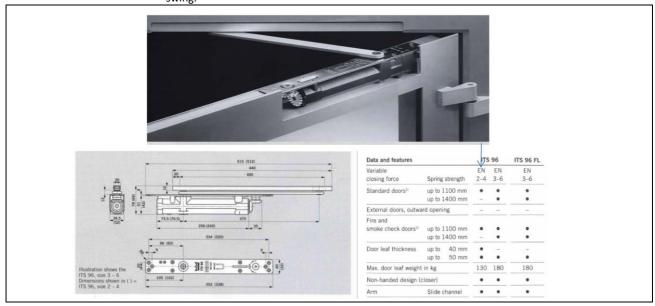

Project: CIC Innovation Center (IC) Project No. : APQ17-0117

First Issue Date : 01-05-2017

Rev. : Rev. Date : -

Code : IR-06

Location : Refer to Ironmongery Schedule and Drawings

Ironmongery Type : Floor Spring
Model : Dorma BTS75R

Description : "Dorma" BTS75R-EN2-5-90HO-SP0, Double action floor spring, heavy duty,180 kgs loading, adjustable

spring size EN2-5, with backcheck, 90 degreehold open, standard spindle, complete with 7510 s.s.

Grade 304 cover plate &screw, w/ 8066 top centre & bottom strap.

Colour : Satin S.S. finish

Opening Angle : Self Closing : N/A
Hold Open : N/A
Closing Force : N/A
Door Thickness : 50mm
Max. Door Weight : N/A

/Load Bearing

Max. Door Width : N/A
Sound Proofing Level : N/A
Fire Rated : N/A
Master Key : N/A
Break : N/A
Country of Origin : -

Supplier : Tung Fat Ho Building Material Ltd.

Contact : Mr. Kevin Lau

Tel. : O: (852) 3620 2781; M: (852) -

Fax. : (852) 3580 0718

Email : kevin.lau@tfhbml.com.hk

Remark : 1. Contractor is not bound to the specified supplier. Alternative or equivalent may be acceptable.


- 2. Contractor shall verify and ensure all door ironmongery to be suitable and sufficient to perform their required function and to have adequate strength for their purpose.
- ${\it 3.} \quad \hbox{Contractor shall ensure all iron mongery used to comply with local regulations}.$
- 4. Pictorial dimension are for reference only. Contractor is required to verify suitable dimension of hardware.
- Contractor shall verify the left / right hand of the ironmongery if necessary according to the door swing.



BTS 75 R
Universal floor spring conforming to DIN EN 1154, non-handed unit suitable for LH and RH single and double action doors up to 180 kg leaf weight, with adjustable spring strength (size EN 2-5) and closing speed, with closing action operational from approx. 175°, Featuring hydraulically fully controlled closing cycle and backcheck. Adjustable size EN2-5 complies with Barrier Free Access for internal, fire and external doors requirements. Equipped with extra heavy duty steel top pivot 8066 and drop forged steel, zinc plated bottom strap 7421 for centre hung and double action doors and single accessories for single action doors. Cover plate to be 304 stainless steel, 1.5 mm thick. Cement box



For applications involving particularly high or heavy loads, likely to exposisouse and doors which have to close against wind or draught conditions, please contact our technical department.

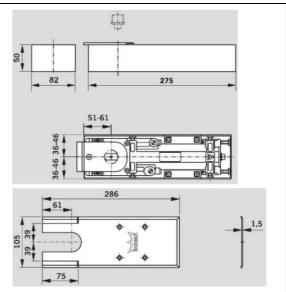

Project: CIC Innovation Center (IC)
Project No. : APQ17-0117
First Issue Date : 01-05-2017

First Issue Date : 01-05-2 Rev. : -

Rev. Date : -

Code : IR-07

Location : Refer to Ironmongery Schedule and Drawings

Ironmongery Type : Closer

Model : Dorma TS83P

Description : "Dorma" TS83P overhead door closer with regular arm, size EN3-6, non holdopen, with backcheck and

delay action, with parallel arm bracket for push sideinstallation, in silver finish.

Colour : Silver Finish

Opening Angle : Self Closing : N/A
Hold Open : N/A
Closing Force : N/A
Door Thickness : 50mm
Max. Door Weight : N/A

/Load Bearing

Max. Door Width : N/A
Sound Proofing Level : N/A
Fire Rated : N/A
Master Key : N/A
Break : N/A
Country of Origin : -

Supplier : Tung Fat Ho Building Material Ltd.

Contact : Mr. Kevin Lau


Tel. : O: (852) 3620 2781 ; M: (852) -

Fax. : (852) 3580 0718

Email : kevin.lau@tfhbml.com.hk

Remark : 1. Contractor is not bound to the specified supplier. Alternative or equivalent may be acceptable.

- 3. Contractor shall ensure all ironmongery used to comply with local regulations.
- 4. Pictorial dimension are for reference only. Contractor is required to verify suitable dimension of hardware.
- Contractor shall verify the left / right hand of the ironmongery if necessary according to the door swing.

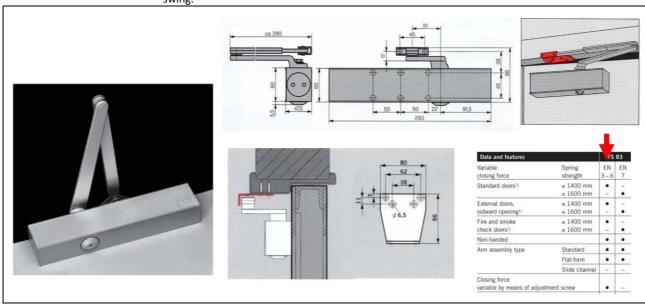



Project: CIC Innovation Center (IC)

Project No.

: APQ17-0117

First Issue Date : 01-05-2017

Rev. : - Rev. Date : -

Code : IR-08

Location : Refer to Ironmongery Schedule and Drawings

Ironmongery Type : Closer Model : Dorma TS72

Description : "Dorma" TS72 overhead door closer with regular arm, size EN2-4, non holdopen, in silver finish.

Colour : Silver Finish

Opening Angle : Self Closing : N/A
Hold Open : N/A
Closing Force : N/A
Door Thickness : 50mm
Max. Door Weight : N/A

/Load Bearing

Max. Door Width : N/A
Sound Proofing Level : N/A
Fire Rated : N/A
Master Key : N/A
Break : N/A
Country of Origin : -

Supplier : Tung Fat Ho Building Material Ltd.

Contact : Mr. Kevin Lau

Tel. : O: (852) 3620 2781; M: (852) -

Fax. : (852) 3580 0718


Email : kevin.lau@tfhbml.com.hk

Remark : 1. Contractor is not bound to the specified supplier. Alternative or equivalent may be acceptable.

- 2. Contractor shall verify and ensure all door ironmongery to be suitable and sufficient to perform their required function and to have adequate strength for their purpose.
- 3. Contractor shall ensure all ironmongery used to comply with local regulations.
- 4. Pictorial dimension are for reference only. Contractor is required to verify suitable dimension of hardware.
- 5. Contractor shall verify the left / right hand of the ironmongery if necessary according to the door swing.



Data and features		TS 72
Spring strength adjustable	Size	EN 2 - 4
Standard doors	≤ 1100 mm ¹⁾	
External doors, outward opening		-
Fire doors		-
Non-handed		
Arm type	Standard	•
	Slide channel	-
Closing speed adjustable at 2 separate valves	180° – 15° 15° – 0°	•
Latching action adjustable (by ar	m)	•
Backcheck		-
Delayed action		-
Hold-open		0
Weight in kg		1.2
Dimensions in mm	Length Overall depth Height	232 45 68
Door closer tested and approved	to EN 1154	
Yes - No Option With parallel-arm fixing, the cl 20 Nm (for doors up to 950 m		rox.

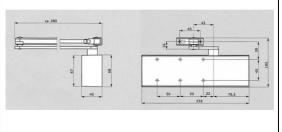



Project: CIC Innovation Center (IC) Project No. APQ17-0117

First Issue Date 01-05-2017

Rev. Rev. Date

Code IR-09

Location Refer to Ironmongery Schedule and Drawings

Ironmongery Type : Lockset

: "Dorma" + "Valance" 381 Model

: "Dorma" 381-B/S70-SS, 300CE series, euro-profile mortise sash lockcase, backset 70mm, with 24mm widt Description

> AISI316 square forend, with AISI316 squarestrike plate and white plastic strike box, in satin s.s. AISI316 finish. + "Dorma"ST6120 lever handle, lever on roses, spring loaded, include escutcheons, satin s.s. 316 finish, in pair. (Art. No. 9385006819626) w/ "Valance" 6PC-ESCY-01-70-SNP, euro-profile cylinder & turn,

pins construction, C keyway,70mm length, in satin nickel plated finish.

Colour Satin S.S. 316 finish

Opening Angle Self Closing : N/A Hold Open : N/A Closing Force : N/A **Door Thickness** 50mm Max. Door Weight N/A

/Load Bearing

Max. Door Width : N/A Sound Proofing Level: N/A Fire Rated N/A Master Key N/A Break N/A Country of Origin

Supplier Tung Fat Ho Building Material Ltd.

Contact Mr. Kevin Lau


Tel. : O: (852) 3620 2781; M: (852) -

Fax. : (852) 3580 0718

Email kevin.lau@tfhbml.com.hk

Remark 1. Contractor is not bound to the specified supplier. Alternative or equivalent may be acceptable.

- Contractor shall verify and ensure all door ironmongery to be suitable and sufficient to perform their required function and to have adequate strength for their purpose.
- Contractor shall ensure all ironmongery used to comply with local regulations.
- Pictorial dimension are for reference only. Contractor is required to verify suitable dimension of hardware.
- Contractor shall verify the left / right hand of the ironmongery if necessary according to the door swing.

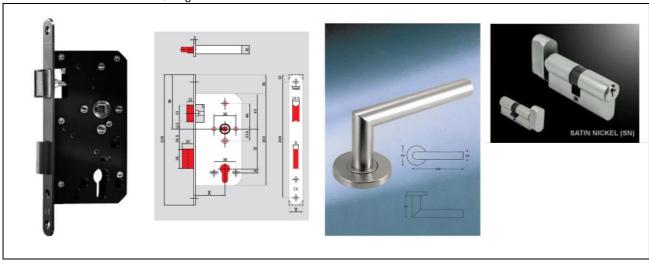



Project: CIC Innovation Center (IC) Project No. APQ17-0117

First Issue Date 01-05-2017

Rev. Rev. Date

Code IR-10

Location Refer to Ironmongery Schedule and Drawings

Ironmongery Type : Lockset : Dorma 388 Model

Description : "Dorma" 388-B/S70-SS, 300CE series, euro-profile mortise deadbolt lockcase,backset 70mm, with 24mm

> AISI316 square forend, with AISI316 squarestrike plate and white plastic strike box, in satin s.s. AISI316 finish. w/"Valance" 6PC-ESCY-01-70-SNP, euro-profile cylinder & turn, 6 pinsconstruction, C keyway, 70mm length, in satin nickel plated finish.+ euro-typeround cylinder rose, in satin s.s., in pair.

Colour Satin S.S. 316 finish

Opening Angle Self Closing : N/A Hold Open : N/A Closing Force : N/A **Door Thickness** 50mm Max. Door Weight N/A

/Load Bearing

Max. Door Width : N/A Sound Proofing Level: N/A Fire Rated N/A Master Key : N/A Break N/A Country of Origin :

Supplier Tung Fat Ho Building Material Ltd.

Contact Mr. Kevin Lau


Tel. : O: (852) 3620 2781; M: (852) -

Fax. : (852) 3580 0718

Email : kevin.lau@tfhbml.com.hk

Remark : 1. Contractor is not bound to the specified supplier. Alternative or equivalent may be acceptable.

- Contractor shall verify and ensure all door ironmongery to be suitable and sufficient to perform their required function and to have adequate strength for their purpose.
- Contractor shall ensure all ironmongery used to comply with local regulations.
- Pictorial dimension are for reference only. Contractor is required to verify suitable dimension of hardware.
- Contractor shall verify the left / right hand of the ironmongery if necessary according to the door

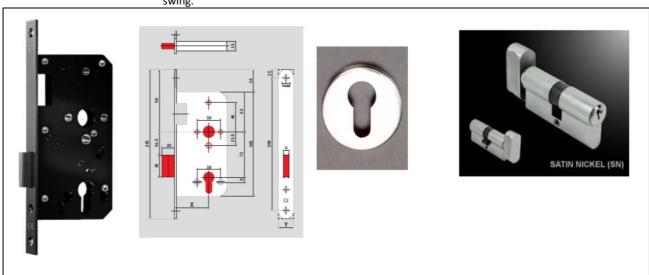



Project: CIC Innovation Center (IC) Project No. APQ17-0117

First Issue Date 01-05-2017

Rev. Rev. Date

Code IR-11

Location Refer to Ironmongery Schedule and Drawings

Ironmongery Type : Lockset : Dorma 388 Model

: "Dorma" 388-B/S70-SS, 300CE series, euro-profile mortise deadbolt lockcase, backset 70mm, with Description

24mm width AISI316 square forend, with AISI316 squarestrike plate and white plastic strike box, in satin s.s. AISI316 finish. w/"Valance" 6PC-ESCY-02-55-SNP, euro-profile half cylinder 6 pinsconstruction, C keyway, 55mm length, in satin nickel plated finish.+ euro-typeround cylinder rose, in satin s.s., in pair.

Satin S.S. 316 finish Colour

Opening Angle **Self Closing** : N/A Hold Open N/A Closing Force N/A **Door Thickness** 50mm Max. Door Weight N/A

/Load Bearing

Max. Door Width : N/A Sound Proofing Level : N/A Fire Rated : N/A Master Key : N/A Break N/A Country of Origin :

Supplier Tung Fat Ho Building Material Ltd.

: Mr. Kevin Lau Contact


: O: (852) 3620 2781; M: (852) -Tel.

Fax. (852) 3580 0718

Email kevin.lau@tfhbml.com.hk

Contractor is not bound to the specified supplier. Alternative or equivalent may be acceptable. Remark 1.

- Contractor shall verify and ensure all door ironmongery to be suitable and sufficient to perform their required function and to have adequate strength for their purpose.
- Contractor shall ensure all ironmongery used to comply with local regulations.
- Pictorial dimension are for reference only. Contractor is required to verify suitable dimension of
- Contractor shall verify the left / right hand of the ironmongery if necessary according to the door swing

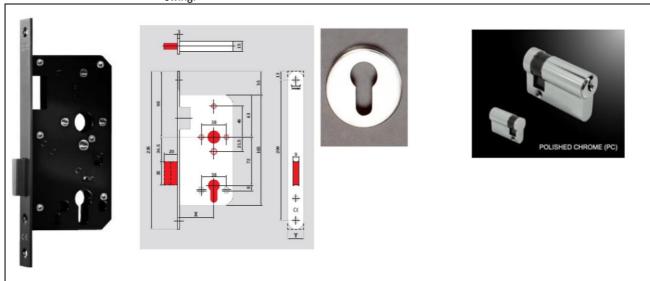



Project: CIC Innovation Center (IC) Project No. APQ17-0117 01-05-2017

First Issue Date Rev.

Rev. Date

Code IR-12

Location Refer to Ironmongery Schedule and Drawings

Ironmongery Type : Lockset

: "Dorma" + "Best" Model

: "Dorma" 385-B/S70-SS, 300CE series, mortise bathroom / W.C. lockcase,backset 70mm, with 24mm Description

> width AISI316 square forend, with AISI316 squarestrike plate and white plastic strike box, in satin s.s. AISI316 finish. + "Dorma"ST6120 lever handle, lever on roses, spring loaded, include escutcheons, satin s.s. 316 finish, in pair. (Art. No. 9385006819626) w/ "Best" 8076-ST,Indicator bolt with emergency

release, with thumb turn, with 8mm spindle, ins.s. satin finish.

Colour Satin S.S. 316 finish

Opening Angle Self Closing : N/A Hold Open : N/A Closing Force : N/A **Door Thickness** 50mm Max. Door Weight N/A

/Load Bearing

Max. Door Width : N/A Sound Proofing Level: N/A Fire Rated N/A Master Key N/A Break N/A Country of Origin :

Supplier Tung Fat Ho Building Material Ltd.

Contact Mr. Kevin Lau


Tel. : O: (852) 3620 2781; M: (852) -

Fax. : (852) 3580 0718

Email kevin.lau@tfhbml.com.hk

Remark 1. Contractor is not bound to the specified supplier. Alternative or equivalent may be acceptable.

- Contractor shall verify and ensure all door ironmongery to be suitable and sufficient to perform their required function and to have adequate strength for their purpose.
- Contractor shall ensure all ironmongery used to comply with local regulations.
- Pictorial dimension are for reference only. Contractor is required to verify suitable dimension of hardware.
- Contractor shall verify the left / right hand of the ironmongery if necessary according to the door swing.

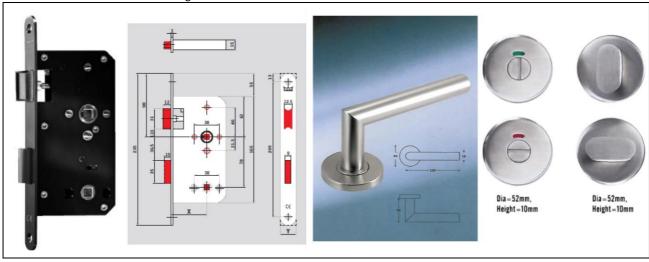

Project: CIC Innovation Center (IC) Project No. APQ17-0117

First Issue Date 01-05-2017

Rev. Date

Code IR-13

Location Refer to Ironmongery Schedule and Drawings

Ironmongery Type Lockset : Dorma 917 Model

"Dorma" No. 917.0 PZ narrow stile bolt lock for europrofile cylinder, DIN18251-2 Class 3, backset Description

30mm, with hexsaw protection, square forend in satinbrushed s.s. finish. w/. "Valance" euro-profile cylinder, L-80mm, outsidecylinder, inside turn w/ master key or keyalike system, in satin nickel finish.

+euro-type oval cylinder rose, in satin s.s., in pair.

Satin Brushed 316 S.S. finish Colour

Opening Angle **Self Closing** N/A Hold Open N/A **Closing Force** N/A **Door Thickness** 50mm Max. Door Weight N/A

/Load Bearing

Max. Door Width N/A Sound Proofing Level N/A Fire Rated N/A Master Key N/A Break N/A Country of Origin

Supplier Tung Fat Ho Building Material Ltd.

Contact Mr. Kevin Lau


O: (852) 3620 2781; M: (852) -Tel.

Fax. (852) 3580 0718

Email kevin.lau@tfhbml.com.hk

Contractor is not bound to the specified supplier. Alternative or equivalent may be acceptable. Remark 1.

- Contractor shall verify and ensure all door ironmongery to be suitable and sufficient to perform their required function and to have adequate strength for their purpose.
- 3 Contractor shall ensure all ironmongery used to comply with local regulations.
- Pictorial dimension are for reference only. Contractor is required to verify suitable dimension of
- Contractor shall verify the left / right hand of the ironmongery if necessary according to the door swing.

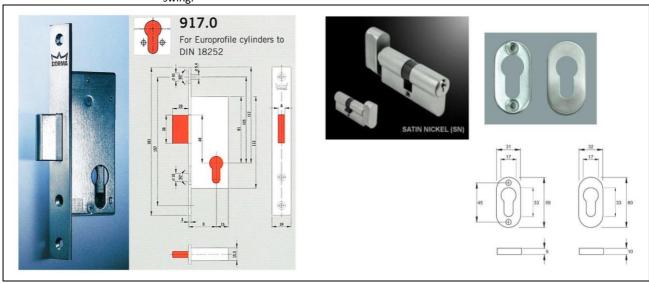



Project: CIC Innovation Center (IC) Project No. APQ17-0117

First Issue Date 01-05-2017

Rev. Rev. Date

: IR-14 Code

Location Refer to Ironmongery Schedule and Drawings

Ironmongery Type Concealed Mortise Deadbolt Lock

: "Best" 3950X Model

: "Best" 3950X concealed mortise deadbolt lock, w/ key retaining function. Description

Colour Silver finish

Opening Angle N/A Self Closing Hold Open N/A **Closing Force** N/A **Door Thickness** : 50mm Max. Door Weight : N/A

/Load Bearing

Max. Door Width : N/A Sound Proofing Level : N/A Fire Rated N/A Master Key N/A Break N/A : Country of Origin

Supplier : Tung Fat Ho Building Material Ltd.

Contact : Mr. Kevin Lau


Tel. : O: (852) 3620 2781; M: (852) -

(852) 3580 0718 Fax.

Email kevin.lau@tfhbml.com.hk

Remark : 1. Contractor is not bound to the specified supplier. Alternative or equivalent may be acceptable.

- Contractor shall ensure all ironmongery used to comply with local regulations.
- Pictorial dimension are for reference only. Contractor is required to verify suitable dimension of hardware.
- Contractor shall verify the left / right hand of the ironmongery if necessary according to the door swing.

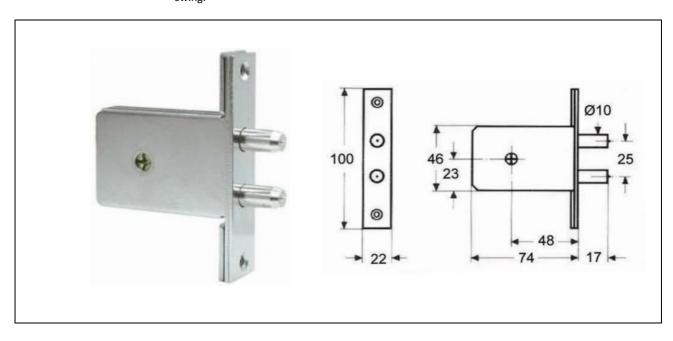

Project: CIC Innovation Center (IC) Project No. : APQ17-0117

First Issue Date : 01-05-2017

Rev. Date : -

Code : IR-15

Location : Refer to Ironmongery Schedule and Drawings

Ironmongery Type : Emergency Alarm Push Bar

Model : Detex Advantex 10 series Rim Exit Device

Description : Refer to manufacturer's specification

Colour : 630 / US32D Brushed Stainless Steel

Opening Angle : Self Closing : N/A
Hold Open : N/A
Closing Force : N/A
Door Thickness : 50mm
Max. Door Weight : N/A

/Load Bearing

Max. Door Width : N/A
Sound Proofing Level : N/A
Fire Rated : N/A
Master Key : N/A
Break : N/A
Country of Origin : -

Supplier : By Contractor

Contact : -


Tel. : O: (852) - ; M: (852) -

Fax. : (852) -

Email

Remark : 1. Contractor is not bound to the specified supplier. Alternative or equivalent may be acceptable.

- 2. Contractor shall verify and ensure all door ironmongery to be suitable and sufficient to perform their required function and to have adequate strength for their purpose.
- 3. Contractor shall ensure all ironmongery used to comply with local regulations.
- 4. Pictorial dimension are for reference only. Contractor is required to verify suitable dimension of hardware.
- 5. Contractor shall verify the left / right hand of the ironmongery if necessary according to the door swing.

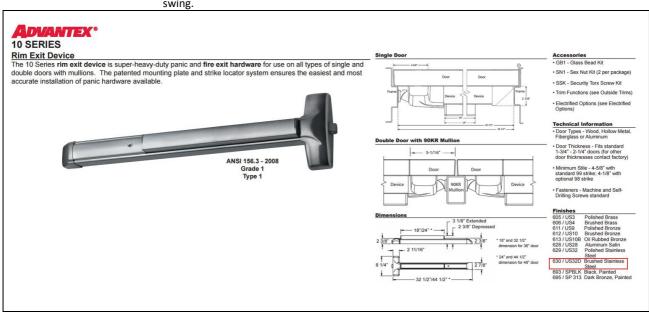

Project: CIC Innovation Center (IC) Project No. : APQ17-0117

First Issue Date : 01-05-2017

Rev. Date : -

Code : IR-16

Location : Refer to Ironmongery Schedule and Drawings

Ironmongery Type : Pull Handle

Model : "Elmes" G1212-22-121-L2000

Description : Refer to manufacturer's specification

Colour : Uni-Wood (Antibacterial Compressed Wood) Scotch Color & Aluminum Blast Anodized Black

Opening Angle : Self Closing : N/A
Hold Open : N/A
Closing Force : N/A
Door Thickness : 50mm
Max. Door Weight : N/A

/Load Bearing

Max. Door Width : N/A
Sound Proofing Level : N/A
Fire Rated : N/A
Master Key : N/A
Break : N/A
Country of Origin : -

Supplier : Tung Fat Ho Building Material Ltd.

Contact : Mr. Kevin Lau


Tel. : O: (852) 3620 2781; M: (852) -

Fax. : (852) 3580 0718

Email : kevin.lau@tfhbml.com.hk

Remark : 1. Contractor is not bound to the specified supplier. Alternative or equivalent may be acceptable.

- 2. Contractor shall verify and ensure all door ironmongery to be suitable and sufficient to perform their required function and to have adequate strength for their purpose.
- 3. Contractor shall ensure all ironmongery used to comply with local regulations.
- 4. Pictorial dimension are for reference only. Contractor is required to verify suitable dimension of hardware.
- 5. Contractor shall verify the left / right hand of the ironmongery if necessary according to the door swing.

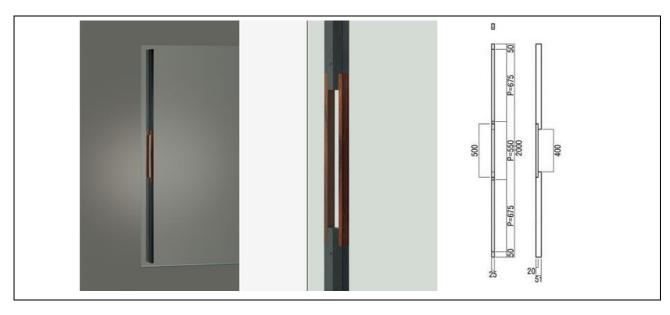

Project: CIC Innovation Center (IC) Project No. APQ17-0117

First Issue Date 01-05-2017

Rev. Rev. Date

Code : IR-17

Location Refer to Ironmongery Schedule and Drawings

Ironmongery Type : Pull Handle

: "Elmes" T2972-26-131-A Model

: Refer to manufacturer's specification Description Colour : Aluminum Blast Anodized Black

Opening Angle . N/A Self Closing Hold Open N/A Closing Force : N/A **Door Thickness** : 50mm Max. Door Weight : N/A

/Load Bearing

Max. Door Width : N/A Sound Proofing Level: N/A Fire Rated : N/A Master Key N/A Break : N/A Country of Origin

Supplier : Tung Fat Ho Building Material Ltd.

Contact : Mr. Kevin Lau


Tel. : O: (852) 3620 2781; M: (852) -

(852) 3580 0718 Fax.

Email kevin.lau@tfhbml.com.hk

Remark : 1. Contractor is not bound to the specified supplier. Alternative or equivalent may be acceptable.

- 2. Contractor shall verify and ensure all door ironmongery to be suitable and sufficient to perform their required function and to have adequate strength for their purpose.
- Contractor shall ensure all ironmongery used to comply with local regulations.
- Pictorial dimension are for reference only. Contractor is required to verify suitable dimension of hardware.
- Contractor shall verify the left / right hand of the ironmongery if necessary according to the door swing.

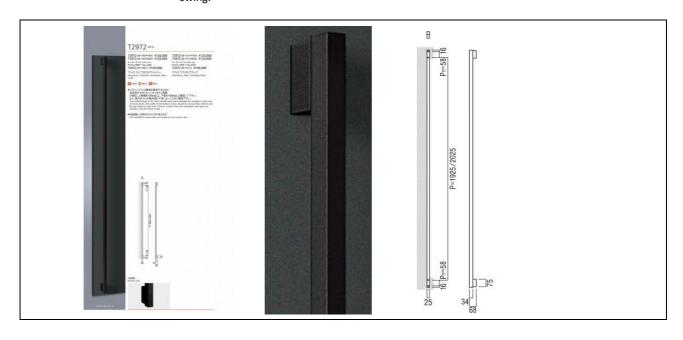

AL Design

IRONMONGERY SPECIFICATION

Project: CIC Innovation Center (IC)

Project No.

APQ17-0117

First Issue Date : 01-05-2017

Rev. Date : -

Code : IR-18

Location : Refer to Ironmongery Schedule and Drawings

Ironmongery Type : Pull Handle Model : "Best" H200

Description : "Valance" BT-H-200 pull handle, Ø25mm, L-275mm, surface fixing on timbermounted, hairline s.s.finish, i

single no.

Colour : Satin S.S. finish

Opening Angle : Self Closing : N/A
Hold Open : N/A
Closing Force : N/A
Door Thickness : 50mm
Max. Door Weight : N/A

/Load Bearing

Max. Door Width : N/A
Sound Proofing Level : N/A
Fire Rated : N/A
Master Key : N/A
Break : N/A
Country of Origin : -

Supplier : Tung Fat Ho Building Material Ltd.

Contact : Mr. Kevin Lau


Tel. : O: (852) 3620 2781; M: (852) -

Fax. : (852) 3580 0718

Email : kevin.lau@tfhbml.com.hk

Remark : 1. Contractor is not bound to the specified supplier. Alternative or equivalent may be acceptable.

- 2. Contractor shall verify and ensure all door ironmongery to be suitable and sufficient to perform their required function and to have adequate strength for their purpose.
- 3. Contractor shall ensure all ironmongery used to comply with local regulations.
- 4. Pictorial dimension are for reference only. Contractor is required to verify suitable dimension of hardware.
- 5. Contractor shall verify the left / right hand of the ironmongery if necessary according to the door swing.

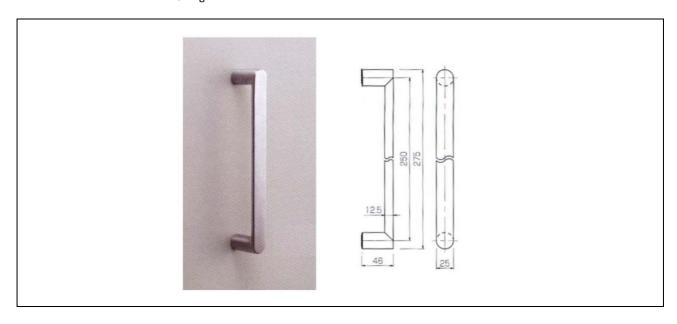



Project: CIC Innovation Center (IC) Project No. : APQ17-0117

First Issue Date : 01-05-2017

Rev. Date : -

Code : IR-19

Location : Refer to Ironmongery Schedule and Drawings

Ironmongery Type : Grab Bar Model : "pba" 440-SS/A

Description : pba" PROGRAMMA 400-SS ART. 440-SS/A horizontal safety support, Ø32mm, max. overall dimension

650mm, centre-to-centre A=570mm, in satin s.s.AISI 316L finish.

Colour : Satin S.S. AISI 316L finish

Opening Angle :
Self Closing : N/A

Hold Open : N/A

Closing Force : N/A

Door Thickness : 50mm

Max. Door Weight : N/A

/Load Bearing

Max. Door Width : N/A
Sound Proofing Level : N/A
Fire Rated : N/A
Master Key : N/A
Break : N/A
Country of Origin : -

Supplier : Tung Fat Ho Building Material Ltd.

Contact : Mr. Kevin Lau

Tel. : O: (852) 3620 2781 ; M: (852) -

Fax. : (852) 3580 0718

Email : kevin.lau@tfhbml.com.hk

Remark : 1. Contractor is not bound to the specified supplier. Alternative or equivalent may be acceptable.

- 3. Contractor shall ensure all ironmongery used to comply with local regulations.
- 4. Pictorial dimension are for reference only. Contractor is required to verify suitable dimension of hardware.
- 5. Contractor shall verify the left / right hand of the ironmongery if necessary according to the door swing.





Project: CIC Innovation Center (IC) Project No. : APQ17-0117

First Issue Date : 01-05-2017

Rev. : - Rev. Date : -

Code : IR-20

Location : Refer to Ironmongery Schedule and Drawings

Ironmongery Type : Folding Safety Grab Bar

Model : "pba" 445S

Description : "PBA" 445S horizontal upswing folding safety grab handrail, 32mmØ x overall750mmlong, in AISI 316L

satin finish.

Colour : Satin S.S. AISI 316L finish

Opening Angle : Self Closing : N/A
Hold Open : N/A
Closing Force : N/A
Door Thickness : 50mm
Max. Door Weight : N/A

/Load Bearing

Max. Door Width : N/A
Sound Proofing Level : N/A
Fire Rated : N/A
Master Key : N/A
Break : N/A
Country of Origin : -

Supplier : Tung Fat Ho Building Material Ltd.

Contact : Mr. Kevin Lau

Tel. : O: (852) 3620 2781 ; M: (852) -


Fax. : (852) 3580 0718

Email : kevin.lau@tfhbml.com.hk

Remark : 1. Contractor is not bound to the specified supplier. Alternative or equivalent may be acceptable.

- 3. Contractor shall ensure all ironmongery used to comply with local regulations.
- 4. Pictorial dimension are for reference only. Contractor is required to verify suitable dimension of hardware.
- 5. Contractor shall verify the left / right hand of the ironmongery if necessary according to the door swing.



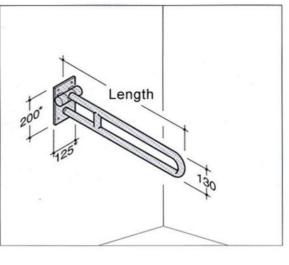



Project: CIC Innovation Center (IC) Project No. APQ17-0117

> First Issue Date 01-05-2017

Rev. Rev. Date

Code : IR-21

Location Refer to Ironmongery Schedule and Drawings

Ironmongery Type : Door Stopper

Model : Kawajun AC-777-XNK

"Kawajun" AC-777-XNK door stopper, Ø35mm, H-40mm, in satin nickel finishand black elastomer. Description

: Satin Nickel finish and Black Elastomer Colour

Opening Angle N/A **Self Closing** Hold Open N/A **Closing Force** N/A : 50mm **Door Thickness** Max. Door Weight : N/A

/Load Bearing

Max. Door Width : N/A Sound Proofing Level : N/A Fire Rated N/A Master Key N/A Break N/A : Country of Origin

: Tung Fat Ho Building Material Ltd. Supplier

Contact : Mr. Kevin Lau


Tel. O: (852) 3620 2781; M: (852) -

Fax. (852) 3580 0718

Email kevin.lau@tfhbml.com.hk

Remark 1. Contractor is not bound to the specified supplier. Alternative or equivalent may be acceptable.

- Contractor shall ensure all ironmongery used to comply with local regulations.
- Pictorial dimension are for reference only. Contractor is required to verify suitable dimension of hardware.
- Contractor shall verify the left / right hand of the ironmongery if necessary according to the door swing.

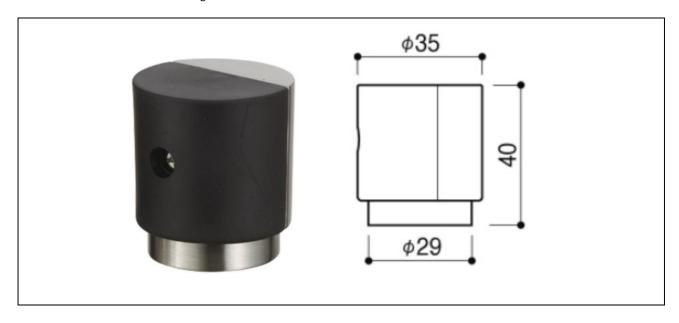



Project: CIC Innovation Center (IC) Project No. APQ17-0117

> First Issue Date 01-05-2017

Rev. : Rev. Date

: IR-22 Code

Location : Refer to Ironmongery Schedule and Drawings

Ironmongery Type : Drop Seal

: "Lorient" LAS8001 Model

: Lorient" LAS8001SI-L935-SV-G-RD, 935mm length automatic Drop Seal, 1Mcycles, BS EN1634-1:2008, BS Description

EN1634-3:2008, BS EN ISO 10140-2:2010 & Certifire, in silver anodized aluminum with silver radius end

plates, and greysilicone rubber gasket. (Size to be confirm)

Colour : Silver anodized aluminium with silver radius end plates

Opening Angle **Self Closing** : N/A Hold Open : N/A Closing Force N/A **Door Thickness** 50mm Max. Door Weight N/A

/Load Bearing

Max. Door Width : N/A Sound Proofing Level : N/A Fire Rated : N/A : N/A Master Key Break N/A Country of Origin :

Supplier Tung Fat Ho Building Material Ltd. :

: Mr. Kevin Lau Contact


: O: (852) 3620 2781; M: (852) -Tel.

: (852) 3580 0718 Fax.

Email kevin.lau@tfhbml.com.hk

1. Contractor is not bound to the specified supplier. Alternative or equivalent may be acceptable. Remark

- Contractor shall ensure all ironmongery used to comply with local regulations.
- Pictorial dimension are for reference only. Contractor is required to verify suitable dimension of
- Contractor shall verify the left / right hand of the ironmongery if necessary according to the door swing.

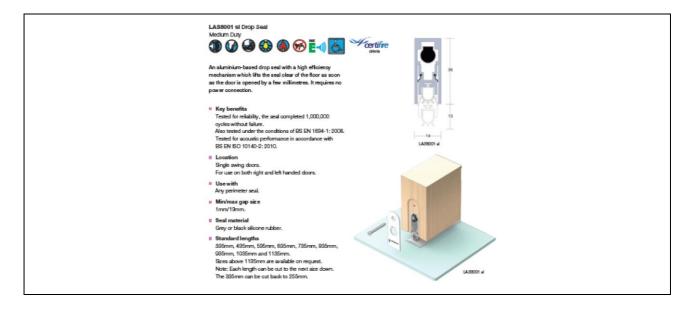



Project: CIC Innovation Center (IC) Project No. APQ17-0117

> First Issue Date 01-05-2017

Rev. Rev. Date

Code : IR-23

Location : Refer to Ironmongery Schedule and Drawings

Ironmongery Type : Batwing Seal : "Lorient" LAS1212 Model

"Lorient-Integrity" LAS1212-L2100-BROWN, Batwing seal, medium duty, self-adhesive type, 2,100mm Description

long, in brown colour.

: Brown Colour Colour

Opening Angle **Self Closing** : N/A Hold Open : N/A Closing Force : N/A : 50mm **Door Thickness** Max. Door Weight : N/A

/Load Bearing

Max. Door Width : N/A Sound Proofing Level: N/A Fire Rated : N/A Master Key : N/A Break : N/A Country of Origin :

Supplier : Tung Fat Ho Building Material Ltd.

Contact : Mr. Kevin Lau


Tel. : O: (852) 3620 2781; M: (852) -

: (852) 3580 0718 Fax.

Fmail : kevin.lau@tfhbml.com.hk

: 1. Contractor is not bound to the specified supplier. Alternative or equivalent may be acceptable. Remark

- Contractor shall ensure all ironmongery used to comply with local regulations.
- Pictorial dimension are for reference only. Contractor is required to verify suitable dimension of hardware.
- Contractor shall verify the left / right hand of the ironmongery if necessary according to the door swing.

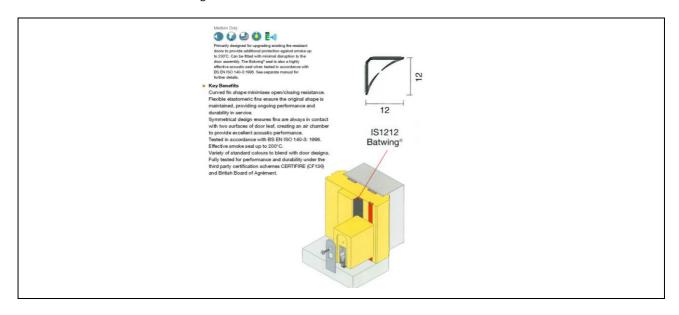



Project: CIC Innovation Center (IC) Project No. APQ17-0117

> First Issue Date 01-05-2017

Rev. Rev. Date

Code : IR-24

Location Refer to Ironmongery Schedule and Drawings

Ironmongery Type Flush Bolt

"Best" FB-450-ST+FB-300-ST+DP-15-SC Model

"Lorient-Integrity" LAS1212-L2100-BROWN, Batwing seal, medium duty, self-adhesive type, 2,100mm Description

long, in brown colour.

Satin S.S. finish Colour

Opening Angle **Self Closing** : N/A Hold Open : N/A **Closing Force** N/A **Door Thickness** 50mm Max. Door Weight N/A

/Load Bearing

Max. Door Width : N/A Sound Proofing Level: N/A Fire Rated N/A Master Key N/A Break N/A Country of Origin :

Supplier : Tung Fat Ho Building Material Ltd.

Contact : Mr. Kevin Lau

Tel. : O: (852) 3620 2781; M: (852) -

: (852) 3580 0718 Fax.

Fmail : kevin.lau@tfhbml.com.hk

Contractor is not bound to the specified supplier. Alternative or equivalent may be acceptable. Remark 1.

- Contractor shall verify and ensure all door ironmongery to be suitable and sufficient to perform their required function and to have adequate strength for their purpose.
- Contractor shall ensure all ironmongery used to comply with local regulations.
- Pictorial dimension are for reference only. Contractor is required to verify suitable dimension of hardware.
- Contractor shall verify the left / right hand of the ironmongery if necessary according to the door swing.





Project: CIC Innovation Center (IC) Project No. APQ17-0117

> First Issue Date 01-05-2017

Rev. Rev. Date

Code : IR-25

Location Refer to Ironmongery Schedule and Drawings

Ironmongery Type Flush Bolt

"Best" FB-300-ST+FB-150-ST+DP-15-SC Model

"BEST" FB-300-ST 300mm length flush bolt in s.s. satin finish. + "BEST" FB-150-ST 150mm length bottom Description

flush bolt in s.s. satin finish. + "Best" DP-15-SCdust proof easy clean socket in satin chrome finish.

: Satin S.S. finish Colour

Opening Angle **Self Closing** : N/A Hold Open : N/A **Closing Force** N/A **Door Thickness** 50mm Max. Door Weight N/A

/Load Bearing

Max. Door Width N/A Sound Proofing Level: N/A Fire Rated N/A Master Key N/A Break N/A Country of Origin

Supplier Tung Fat Ho Building Material Ltd.

Contact : Mr. Kevin Lau


Tel. : O: (852) 3620 2781; M: (852) -

: (852) 3580 0718 Fax.

Email : kevin.lau@tfhbml.com.hk

Remark 1. Contractor is not bound to the specified supplier. Alternative or equivalent may be acceptable.

- Contractor shall ensure all ironmongery used to comply with local regulations.
- Pictorial dimension are for reference only. Contractor is required to verify suitable dimension of hardware.
- Contractor shall verify the left / right hand of the ironmongery if necessary according to the door swing.

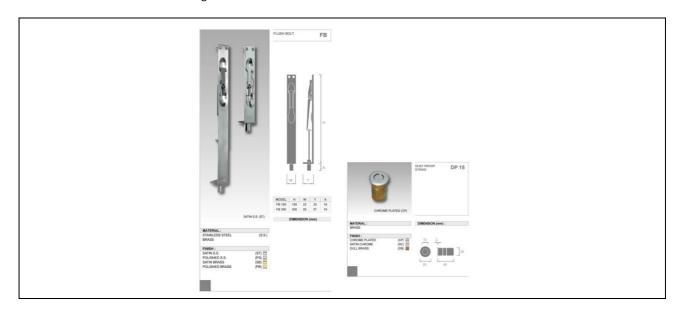

Project: CIC Innovation Center (IC) Project No. APQ17-0117

> First Issue Date 01-05-2017

Rev. Rev. Date

Code IR-26

Location Refer to Ironmongery Schedule and Drawings

Ironmongery Type **Door Selector**

"Hager" 298D-US26D Model

"Hager" 298D-US26D surface mounted gravity type door selector, adjustable angle, ANSI A156.3 Type Description

#21B, in satin. Finish

Satin S.S. finish Colour

Opening Angle Self Closing : N/A Hold Open N/A **Closing Force** N/A **Door Thickness** 50mm Max. Door Weight N/A

/Load Bearing

Max. Door Width N/A Sound Proofing Level N/A Fire Rated N/A Master Key N/A Break N/A Country of Origin

Supplier Tung Fat Ho Building Material Ltd.

Contact Mr. Kevin Lau

Tel. O: (852) 3620 2781; M: (852) -

: (852) 3580 0718 Fax.

Fmail kevin.lau@tfhbml.com.hk

Contractor is not bound to the specified supplier. Alternative or equivalent may be acceptable. Remark 1.

- Contractor shall verify and ensure all door ironmongery to be suitable and sufficient to perform their required function and to have adequate strength for their purpose.
- Contractor shall ensure all ironmongery used to comply with local regulations.
- Pictorial dimension are for reference only. Contractor is required to verify suitable dimension of hardware.
- Contractor shall verify the left / right hand of the ironmongery if necessary according to the door swing.



Project: CIC Innovation Center (IC) Project No. : APQ17-0117

First Issue Date : 01-05-2017

Rev. Date : -

Code : IR-27

Location : Refer to Ironmongery Schedule and Drawings

Ironmongery Type : Hinge

Model : "Dorma" PT10-ST, PT20

Description : "Dorma" PT10 bottom patch fitting, PT20 top patch fitting, max loading 130kg, for 15mm glass

thickness, in satin s.s. finish.

Colour : Satin S.S. finish

Opening Angle : Self Closing : N/A
Hold Open : N/A
Closing Force : N/A
Door Thickness : 15mm
Max. Door Weight : N/A

/Load Bearing

Max. Door Width : N/A
Sound Proofing Level : N/A
Fire Rated : N/A
Master Key : N/A
Break : N/A
Country of Origin : -

Supplier : Tung Fat Ho Building Material Ltd.

Contact : Mr. Kevin Lau


Tel. : O: (852) 3620 2781 ; M: (852) -

Fax. : (852) 3580 0718

Email : kevin.lau@tfhbml.com.hk

Remark : 1. Contractor is not bound to the specified supplier. Alternative or equivalent may be acceptable.

- 3. Contractor shall ensure all ironmongery used to comply with local regulations.
- 4. Pictorial dimension are for reference only. Contractor is required to verify suitable dimension of hardware.
- 5. Contractor shall verify the left / right hand of the ironmongery if necessary according to the door swing.

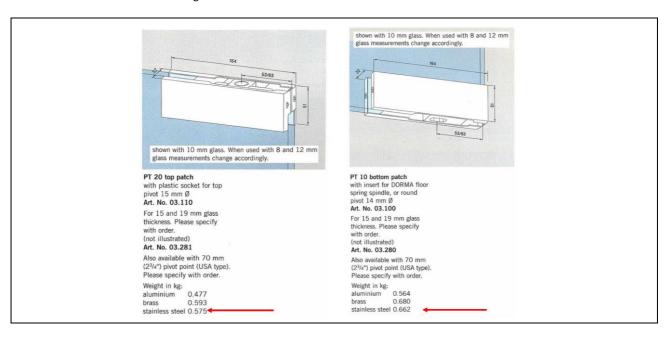



Project: CIC Innovation Center (IC) Project No. APQ17-0117

First Issue Date 01-05-2017

Rev. Rev. Date

Code : IR-28

Location Refer to Ironmongery Schedule and Drawings

Ironmongery Type Sliding Track "Hufcor" Type 36 Model

: Refer to manufacturer's specification Description

Colour : Satin S.S. finish

Opening Angle N/A Self Closing Hold Open N/A **Closing Force** N/A : N/A **Door Thickness** Max. Door Weight : N/A

/Load Bearing

Max. Door Width : N/A Sound Proofing Level : N/A Fire Rated N/A Master Key N/A Break N/A : Country of Origin

: Hufcor Asia Pacific Ltd. Supplier


Contact : Mr. Tony Li

Tel. O: (852) 2173 1225 ; M: (852) 6461 1790

Fax. (852) 2688 0896 Email tonyli@hufcor.com.hk

Remark 1. Contractor is not bound to the specified supplier. Alternative or equivalent may be acceptable.

- Contractor shall verify and ensure all door ironmongery to be suitable and sufficient to perform their required function and to have adequate strength for their purpose.
- Contractor shall ensure all ironmongery used to comply with local regulations.
- Pictorial dimension are for reference only. Contractor is required to verify suitable dimension of hardware.
- Contractor shall verify the left / right hand of the ironmongery if necessary according to the door swing.

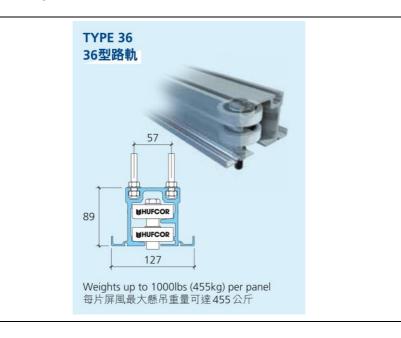

APQ17-0117

CIC Innovation Center (IC)

SANITARY WARE & FITTING SPECIFICATION

LATEST REVISION DATE: 11-05-2017 ISSUE NO.: 2



SANITARY WARE & FITTING SPECIFICATION

Project: CIC	Innovation Center (IC)	Project No. Latest Rev. Date Issue No.		Q17-0117 05-2017
Code	Sanitary Type	First Issue Date	Rev. Date	Rev.
SA-01	Faucet	25-04-2017		
SA-02	Basin	25-04-2017		
SA-03	Urinal	25-04-2017	08-05-2017	Α
SA-04	Toilet closet	25-04-2017		
SA-05	Disable toilet	25-04-2017		
SA-06	Disable accessories	25-04-2017		
SA-07	Disable basin	25-04-2017		
SA-08A	Sink	25-04-2017		
SA-08B	Faucet	25-04-2017		
SA-09	Rolled Paper Rack	25-04-2017		
SA-10	Hanger	25-04-2017		
SA-11	Paper holder	25-04-2017		
SA-12	Soap dispenser	25-04-2017		
SA-13	Hand Dryer	25-04-2017		
SA-14	Fridge	25-04-2017		
SA-15	Toilet Cubicle	11-05-2017		Α



SANITARY WARE & FITTING SPECIFICATION

Project: CIC Innovation Center (IC) Project No. APQ17-0117 02-05-2017 First Issue Date

Rev. Rev. Date

Code : SA-01 Item : Faucet

Location : Male & Female Toilet Model : EFX-275-XOX-OXXX

Description : Refer to Manufacturer's specification

Colour : White Country of Origin

Supplier Delta Force Contact : Mr. Joe Luk

Tel. : (852) 28987400 / 90268752

Fax. : (852) 3747 6492

Email : joeluk@deltaforce.com.hk

Remark Contractor is not bound to the specified supplier. Alternative or equivalent may be acceptable.

Contractor should submit samples for designer's approval.

All Sanitary wares and fittings must comply with local statutory requirements. Contractor is required to provide water certificates of the sanitary wares and fittings.

3. All sanitary wares and fittings should be supplied with all necessary fixture and fittings.





SANITARY WARE & FITTING SPECIFICATION

Project: CIC Innovation Center (IC) Project No. : APQ17-0117
First Issue Date : 02-05-2017

Rev. : - Rev. Date : -

Code : SA-02 Item : Basin

Location : Male & Female Toilet Model : Roca-FORO-32788N

Description : Refer to Manufacturer's specification

Colour : White Country of Origin : Spain

Supplier : Galaxy Bathroom Co Ltd

Contact : Stephen

Tel. : (852) 2802 3009 Fax. : (852) 2802 3128


Email : galaxybcstephen@gmail.com


Remark : 1. Contractor is not bound to the specified supplier. Alternative or equivalent may be acceptable.

Contractor should submit samples for designer's approval.

2. All Sanitary wares and fittings must comply with local statutory requirements. Contractor is required to provide water certificates of the sanitary wares and fittings.

3. All sanitary wares and fittings should be supplied with all necessary fixture and fittings.

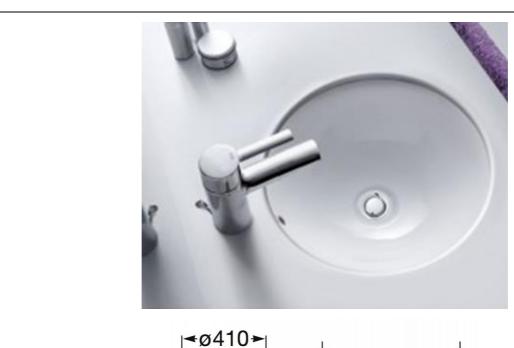

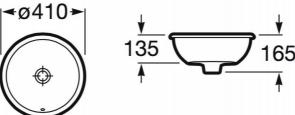

11-05-2017

SANITARY WARE & FITTING SPECIFICATION

Project: CIC Innovation Center (IC) Project No. APQ17-0117 02-05-2017

First Issue Date

Rev.

Rev. Date

Code SA-03 Item Urinal Location Male Toilet Model : US800CKTH

Description : Refer to Manufacturer's specification

Colour White Country of Origin :

VSC Building Products Co. Ltd. Supplier

Contact Mr. Patrick Wong

Tel. (852) 2238 2628 / (852) 9106 4075


Fax. : Email :

Remark 1. Contractor is not bound to the specified supplier. Alternative or equivalent may be acceptable.

Contractor should submit samples for designer's approval.

All Sanitary wares and fittings must comply with local statutory requirements. Contractor is required to provide water certificates of the sanitary wares and fittings.

All sanitary wares and fittings should be supplied with all necessary fixture and fittings.

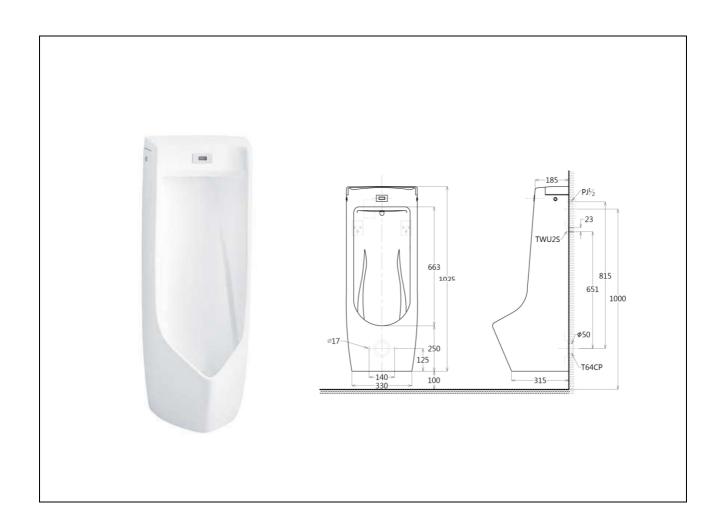



Project: CIC Innovation Center (IC) APQ17-0117 Project No. 02-05-2017 First Issue Date

> Rev. Rev. Date

Code : SA-04 Item **Toilet Closet**

Location : Male & Female Toilet Model : TOTO-CW868NPJ

Description : Refer to Manufacturer's specification

Colour : Indonesia Country of Origin

Supplier : Galaxy Bathroom Co Ltd

Contact : Stephen

Tel. : (852) 2802 3009 Fax. : (852) 2802 3128

Email : galaxybcstephen@gmail.com

Remark : 1. Contractor is not bound to the specified supplier. Alternative or equivalent may be acceptable.

Contractor should submit samples for designer's approval.

All Sanitary wares and fittings must comply with local statutory requirements. Contractor is required to provide water certificates of the sanitary wares and fittings.





Project: CIC Innovation Center (IC) Project No. APQ17-0117 02-05-2017

First Issue Date Rev.

Rev. Date

Code SA-05

Disable Toilet Item Location : Disable Toilet Model : TOTO-CW781PB

Description : Refer to Manufacturer's specification

Colour : White Country of Origin

Supplier Galaxy Bathroom Co Ltd

Contact Stephen


Tel. (852) 2802 3009 Fax. : (852) 2802 3128

Email : galaxybcstephen@gmail.com

Remark : 1. Contractor is not bound to the specified supplier. Alternative or equivalent may be acceptable.

Contractor should submit samples for designer's approval.

All Sanitary wares and fittings must comply with local statutory requirements. Contractor is required to provide water certificates of the sanitary wares and fittings.

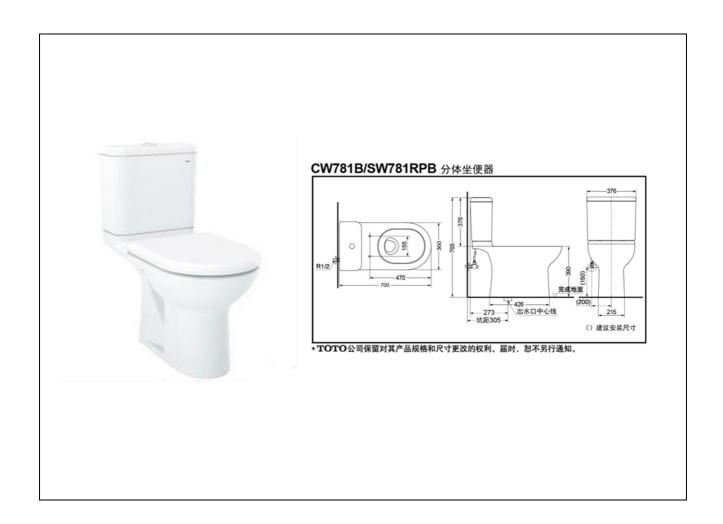



Project: CIC Innovation Center (IC) Project No. APQ17-0117 02-05-2017 First Issue Date

> Rev. Rev. Date

Code : SA-06

Item : Disable Accessories Location : Disable Toilet Model : By contractor

Description : Refer to Manufacturer's specification

Colour

Country of Origin

Supplier By Contractor

Contact Tel. Fax. Email

Remark 1. Contractor is not bound to the specified supplier. Alternative or equivalent may be acceptable. Contractor should submit samples for designer's approval.

> 2. All Sanitary wares and fittings must comply with local statutory requirements. Contractor is required to provide water certificates of the sanitary wares and fittings.





Project: CIC Innovation Center (IC) Project No. : APQ17-0117
First Issue Date : 02-05-2017

Rev. : -

Code : SA-07 Item : Disable Basin Location : Disable Toilet Model : TOTO-L34

Description : Refer to Manufacturer's specification

Colour : White

Country of Origin

Supplier : By Contractor

Contact :
Tel. :
Fax. :
Email :

Remark : 1. Contractor is not bound to the specified supplier. Alternative or equivalent may be acceptable.

Contractor should submit samples for designer's approval.

2. All Sanitary wares and fittings must comply with local statutory requirements. Contractor is required to provide water certificates of the sanitary wares and fittings.





Project: CIC Innovation Center (IC) Project No. : APQ17-0117
First Issue Date : 02-05-2017

Rev. : - Rev. Date : -

Code : SA-08A | Item : Sink | Location : Pantry | Model : Roca-X-tra 61

Description : Refer to Manufacturer's specification

Colour : Silver

Country of Origin

Supplier : Luen Hing Hong Building Materials Ltd

Contact : Mandy

Tel. : (852) 2836 5183 / 2836 5083

Fax. : (852) 2836 5616

Email : laufen@luenhinghong.com.hk

Remark : 1. Contractor is not bound to the specified supplier. Alternative or equivalent may be acceptable.

Contractor should submit samples for designer's approval.

2. All Sanitary wares and fittings must comply with local statutory requirements. Contractor is required to provide water certificates of the sanitary wares and fittings.





Project: CIC Innovation Center (IC) Project No. APQ17-0117

02-05-2017 First Issue Date

Rev. Rev. Date

Code SA-08B Item Faucet Location Pantry

Model Roca-5A8460C00

Description Refer to Manufacturer's specification

Colour

Country of Origin

Supplier Luen Hing Hong Building Materials Ltd

Contact Mandy

Tel. (852) 2836 5183 / 2836 5083

Fax. : (852) 2836 5616

Email : laufen@luenhinghong.com.hk

Remark 1. Contractor is not bound to the specified supplier. Alternative or equivalent may be acceptable.

Contractor should submit samples for designer's approval.

All Sanitary wares and fittings must comply with local statutory requirements. Contractor is

required to provide water certificates of the sanitary wares and fittings.





Project: CIC Innovation Center (IC) APQ17-0117 Project No. 02-05-2017 First Issue Date

> Rev. Rev. Date

Code : SA-09

Item : Rolled Paper Rack Location : Male & Female Toilet Model : Aquarious-70260

Description : Refer to Manufacturer's specification

Colour : White

Country of Origin

Supplier : H.S.Chan co. Ltd Contact May Lee Tel. 9285 1548

Fax. Email

Remark

1. Contractor is not bound to the specified supplier. Alternative or equivalent may be acceptable. Contractor should submit samples for designer's approval.

2. All Sanitary wares and fittings must comply with local statutory requirements. Contractor is required to provide water certificates of the sanitary wares and fittings.





Project: CIC Innovation Center (IC) Project No. : APQ17-0117
First Issue Date : 02-05-2017

Rev. : -

Code : SA-10 Item : Hanger

Location : Male & Female Toilet

Model : TOTO-YKH21

Description : Refer to Manufacturer's specification

Colour : Silver

Country of Origin

Supplier : Galaxy Bathroom Co Ltd

Contact : Stephen

Tel. : (852) 2802 3009 Fax. : (852) 2802 3128

Email : galaxybcstephen@gmail.com

Remark : 1. Contractor is not bound to the specified supplier. Alternative or equivalent may be acceptable.

Contractor should submit samples for designer's approval.

2. All Sanitary wares and fittings must comply with local statutory requirements. Contractor is

Rev. Date

required to provide water certificates of the sanitary wares and fittings.





Project: CIC Innovation Center (IC) Project No. APQ17-0117 02-05-2017 First Issue Date

Rev. Rev. Date

Code : SA-11

Item : Paper Holder (inside hanging cabinet)

Location : Male & Female Toilet Model : Simple Human KT1161

Description : Refer to Manufacturer's specification

Colour White

Country of Origin

Supplier Life Kan

Contact

Tel. 2872 8738

Fax.

Email

Remark 1. Contractor is not bound to the specified supplier. Alternative or equivalent may be acceptable.

Contractor should submit samples for designer's approval.

2. All Sanitary wares and fittings must comply with local statutory requirements. Contractor is required to provide water certificates of the sanitary wares and fittings.





Project: CIC Innovation Center (IC) Project No. : APQ17-0117
First Issue Date : 02-05-2017

Rev. : Rev. Date : -

Code : SA-12

Item:Soap DispenserLocation:Male & Female ToiletModel:Kimberley Clark-92147

Description : Refer to Manufacturer's specification

Colour : White

Country of Origin :

Supplier : H.S.Chan co. Ltd
Contact : May Lee
Tel. : 9285 1548

Fax. : Email :

Remark : 1. Contractor is not bound to the specified supplier. Alternative or equivalent may be acceptable.

Contractor should submit samples for designer's approval.

2. All Sanitary wares and fittings must comply with local statutory requirements. Contractor is required to provide water certificates of the sanitary wares and fittings.





Project: CIC Innovation Center (IC) Project No. APQ17-0117 02-05-2017

First Issue Date

Rev. Rev. Date

Code : SA-13 Item : Hand Dryer

: Male & Female Toilet Location Model : Dyson-Airblade AB 14

Description : Refer to Manufacturer's specification

Colour

Country of Origin

: Jibpool International Ltd Supplier

Contact Carrie Tsui

Tel. (852) 2102 5503 / 2512 8806

Fax.

Email : carrie@jibpool.com.hk / mail@jibpool.com

Remark : 1. Contractor is not bound to the specified supplier. Alternative or equivalent may be acceptable.

Contractor should submit samples for designer's approval.

2. All Sanitary wares and fittings must comply with local statutory requirements. Contractor is

required to provide water certificates of the sanitary wares and fittings.





Project: CIC Innovation Center (IC) Project No. APQ17-0117 02-05-2017 First Issue Date

> Rev. Rev. Date

Code : SA-14 Item : Mini Fridge Location : Pantry

Model : Whirlpool - W07RX : 440W x 510D x 640mmH Description

Colour : Black

Supplier : By Contractor

Remark : 1. Contractor is not bound to the specified supplier. Alternative or equivalent may be acceptable.

Contractor should submit samples for designer's approval.

2. All Sanitary wares and fittings must comply with local statutory requirements. Contractor is required to provide water certificates of the sanitary wares and fittings.





Project: CIC Innovation Center (IC)
Project No. : APQ17-0117
First Issue Date : 11-05-2017

Rev. Date : -

Code : SA-15

Item : Toilet Cubicle

Location : Male & Female Toilet

Model : Formica "Coolinear" Floor to Ceiling Cubicle System

Description : Protec+ Silver (Ag+) antimicrobial compact grade laminate Phenolic resin board, blackcore, decopaper or

double sides in matte finish, 12mm thick for partition, pilaster and door.

Flush door design

Colour : Formica 0927 - Folkstone

Supplier : Formica (Asia) Ltd

Contact : Mr. Leo Lee

Remark

Tel. : (852) 2169 8111 / (852) 6222 3322

Email : leo.lee@formica.com

: 1. Contractor is not bound to the specified supplier. Alternative or equivalent may be acceptable. Contractor should submit samples for designer's approval.

All Sanitary wares and fittings must comply with local statutory requirements. Contractor is

required to provide water certificates of the sanitary wares and fittings.

3. All sanitary wares and fittings should be supplied with all necessary fixture and fittings.



International Standard & Certifications:

Greenguard Gold Certification; Carbon Reduction Label;BS476 Part 6 and 7;

EN-438-2005;ISO9001,ISO14001,ISO4586-2,OHSA S18001,ISO 22196:2011;

Antifungal ASTMG21:2013 test report, with 0(None); Antibacterial JISZ2801:2012 prevent growth of bacterial up to 99% within 24 hours.

Stainless steel hardware includes self-closing / opening gravity hinge, indicator lock set. with emergency opening, 100mm(H) pilaster base cover, handle, angle bracket and coat hook (Flush Door)-

Recommended Dimension:

800-900mm(W) x 1500-1800mm(D) x 2400mm(H)-

(Overall height from finish floor level to false ceiling)



APQ17-0117

CIC Innovation Center (IC)

SOCKETS & SWITCHES SCHEDULE

LATEST REVISION DATE: 02-05-2017 ISSUE NO.:1



SOCKETS & SWITCHES SCHEDULE

Project: CIC Innovation Center (IC) Project No. : APQ17-0117 Latest Rev. Date : 02-05-2017

Issue No. 1

Item	Image	Description	Supplier
SS-01	Control of the Contro	Schneider ZENcelo E8431/1 16AX 1 Gang 1 Way Full-Flat Switch with Ondicator Color: White	By Contractor
SS-02		Schneider ZENcelo E8432/1 16AX 2 Gang 1 Way Full-Flat Switch with Ondicator Color: White	By Contractor
SS-03		Schneider ZENcelo E8432/1 16AX 3 Gang 1 Way Full-Flat Switch with Ondicator Color: White	By Contractor
SS-04	Capping.	Schneider ZENcelo E84426 13A 1 Gang Socket Color: White	By Contractor
SS-05		Schneider ZENcelo E84T426 2 Gang 13A Power Socket Color: White	By Contractor



SOCKETS & SWITCHES SCHEDULE

SS-06	Figure 2	Schneider ZENcelo E8431RJS4 1 Gang Telephone Socket on Shuttered Wallplate Color: White	By Contractor
SS-07	Figures	Schneider ZENcelo E8431RJS/5 1 Gang Data Outlet Category 5e on Shuttered Wallplate Color: White	By Contractor
SS-08		Schneider ZENcelo E8432TDRJS/5 2 Gang Telephone + Data Outlet Category 5e on Shuttered Wallplate Color: White	By Contractor
SS-09		Schneider ZENcelo Entertainment-Socket- ST84UHAVWE_grande Color: White	By Contractor

APQ17-0117

CIC Innovation Center (IC)

LOOSE FURNITURE SPECIFICATION

LATEST REVISION DATE: 02-05-2017 ISSUE NO.: 1



AB-238*

LOOSE FURNITURE DETAIL LIST

CODE	DESCRIPTION	LOCATION	QTY	SUPPLIER	CONTACT			
F-01	BAR TABLE	LOUNGE	2	Maum	Ms. Creamy Yeung T: 2308 1931			
F-02	BAR STOOL	LOUNGE	4	Maum	Ms. Creamy Yeung T: 2308 1931			
F-03	OUTDOOR STOOL	OUTDOOR AREA	5	Maum	Ms. Creamy Yeung T: 2308 1931			
F-04	SIDE TABLE	LOUNGE	1	Maum	Ms. Creamy Yeung T: 2308 1931			
F-05	CEO WORKSTATION	CEO ROOM	1	Lamex	Mr. Raymond Tse T: 2828 6862			
F-06	LEISURE CHAIR	CEO ROOM	2	Maum	Ms. Creamy Yeung T: 2308 1931			
F-07	COFFEE TABLE	CEO ROOM	1	Maum	Ms. Creamy Yeung T: 2308 1931			
F-08	BAR STOOL	WET PANTRY	4	Maum	Ms. Creamy Yeung T: 2308 1931			
F-09	STAFF WORKSTATION	OFFICE AREA	9	Lamex	Mr. Raymond Tse T: 2828 6862			
F-10	STAFF CHAIR	OFFICE AREA CEO ROOM, RECEPTION	13	Lamex	Mr. Raymond Tse T: 2828 6862			
F-11	MEETING TABLE	MEETING ROOM	1	Lamex	Mr. Raymond Tse T: 2828 6862			
F-12	MEETING CHAIR	MEETING ROOM	7	Maum	Ms. Creamy Yeung T: 2308 1931			
F-13	LOW CABINET	MEETING ROOM	1	Maum	Ms. Creamy Yeung T: 2308 1931			
F-14	CEO CHAIR	CEO ROOM	1	HWSPACES	Mr. Mike Leung T: 2832 0288			
F-15	Roller shutter door cabinet	OFFICE	2	Lamex	Mr. Raymond Tse T: 2828 6862			
F-16	CEO CHAIR	OFFICE	3	Lamex	Mr. Raymond Tse T: 2828 6862			
AD 220*								

AB-239*

Lounge Area





Supplier : Maum

Code: F-01

Model: DTC-H2

Size: Dia600 x H1050mm

Finishes: Top: MDF Base: Steel



Bar Stool

Supplier: Maum

Code: F-02

Model: BSW-26

Size: W460 x D470 x H860mm

Finishes:

Seat: polypropylene

Base: wood



Side Table

Supplier : Maum

Code: F-04

Model: STC-66A

Size: Dia480 x H550mm

Finishes:

Top: white sand grain beveled edge

Base: steel powder coated in white

Outdoor Area



Outdoor Stool

Supplier: Maum

Code: F-03

Model: Small River Stone (imported from Italy)

Size: W490 x D490 x H440mm

Finishes: integral polyurethane foam (soft touch plus)

CEO Office



CEO workstation

Supplier: Lamex


Code : F-05

Size:

• Whole set: 2000W x 2900D x 745Hmm

Spec: refer to diagram

Finishes: veneer

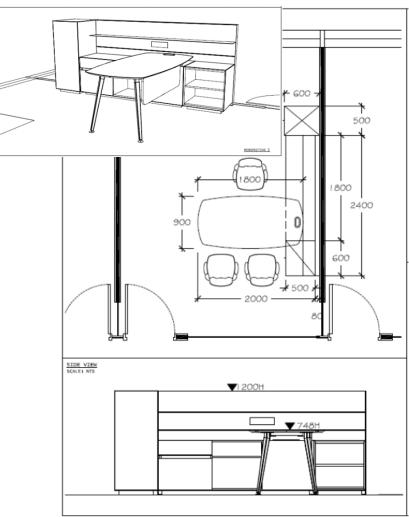

CEO Office



Leisure chair

Supplier : Maum

Code: F-06

Model: LCC-115A

Size: W750 x D750 x H780mm

Finishes:

Seat: fabricBase: steel



Coffee table

Supplier : Maum

Code : F-07

Model: STC-68A/68B *Size:* Dia 600 x H450mm

Finishes:

Top: white sand grain bevelled edge

Base: steel

CEO Office



CEO chair

Supplier: Haworth

Code : F-14

Model: Zody Executive Chair

Finishes:

Back & Seat: full leather

Base: aluminum



Guest chair

Supplier: Lamex

Code: F-10

Model: VT-HMWD4B-LU-B-B-BK-S1-800

Size: 400W x 500D x 605Hmm

Finishes:

• Back: mesh

Seat: fabric

Reception Area



Reception chair

Supplier : Lamex

Code: F-10

Model: VT-HMWD4B-LU-B-B-BK-S1-800

Size: 400W x 500D x 605Hmm

Finishes:

Back: meshSeat: fabric

Wet Pantry



Bar Stool

Supplier : Maum

Code: F-08 Model: BSC-38

Size: W480 x D490 x H1000mm

Finishes:

Seat: polypropylene

Base: steel

Office Area



Staff workstation

Supplier : Lamex Code : F-09

Size:

Table: 1100W x 1100D x 745Hmm

Partition: 355H

Finishes:

Partition: fabricTable top: MFC

Leg: metal



Staff chair

Supplier: Lamex

Code : F-10

Model:

VT-HMWD4B-LU-B-B-BK-S1-800

Size: 400W x 500D x 605Hmm

Finishes:

Back: meshSeat: fabric



Roller shutter door cabinet

Supplier: Lamex

Size:

• Low: 1200W x 450 x 900Hmm (Code : F-15)

High: 1200W x 450D x 2100Hmm (Code : F-16)

Finishes: metal 1980Hmm



AB-247*

Mobile pedestal


Supplier: Lamex

Code: F-09

Model: UBE-H-MPC-3DS-KR-H *Size:* 400W x 500D x 605Hmm

Finishes: metal

Meeting Room

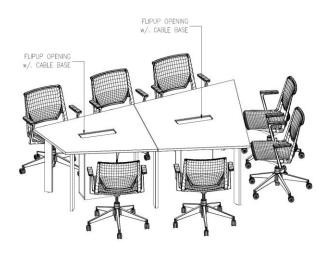

Meeting Table w/ flipper

Brand: By contractor

Code: F-11

Size: W2500/2000 x D1700/700mm

Finishes:

Top: corian

Base: aluminum



Cabinet

Supplier: Maum

Code: F-13

Model: Credenza-01

Size: W2060 x D730 x H500mm Finishes: matt lacquered wood



Meeting Chair

Supplier: Maum

Code: F-12 Model: BSC-38

Size: W480 x D490 x H1000 mm

Finishes:

• Shell: vinyl

Base: steel

APQ17-0117

CIC Innovation Center (IC)

ARCHITECTURAL LIGHTING SPECIFICATION

LATEST REVISION DATE: 11-05-2017 ISSUE NO.:2



Project: CIC Innovation Center (IC)		Project No. Latest Rev. Date Issue No.	: APQ17-0117 : 11-05-2017 : 2	
Code	Lighting Type	First Issue Date	Rev. Date	Rev.
L-01	Outdoor Floor Lamp	02-05-2017	-	-
L-02	Outdoor Tree light	02-05-2017	-	-
L-03	LED Panel (Dimmable)	02-05-2017	-	-
L-04A&b	LED Recessed Downlight (L-04A Dimmable; L-04b Non Dimmable)	02-05-2017	-	-
L-05A	LED Twin Spotlight (Dimmable)	02-05-2017	-	-
L-05B	LED Twin Spotlight	02-05-2017	-	-
L-06	LED Recessed Downlight (Dimmable)	02-05-2017	11-05-2017	Α
L-07	LED Track Light	02-05-2017	-	-
L-08	LED Pendant	02-05-2017	-	-
L-09	LED Spotlight	02-05-2017	-	-
L-10	Outdoor Wall Lamp	02-05-2017	-	-
L-11	Pendant Lamp	02-05-2017	-	-
L-12	Pendant Lamp	02-05-2017	-	-
L-13	LED Single Spotlight	02-05-2017	-	-
L-14	Pendant Lamp	02-05-2017	11-05-2017	Α
L-15	LED Strip	02-05-2017	-	-
L-16	Blue LED Strip	02-05-2017	-	-
L-17	LED Desk Lamp	11-05-2017		

Project: CIC Innovation Center (IC) Project No. : APQ17-0117

First Issue Date : 02-05-2017

Rev. : - Rev. Date : -

Code : L-01

Location : Outdoor area
Light Fitting Type : Outdoor Floor Lamp

Model : SP-003

Description : Refer to manufacturer's specification

Colour : Matte White
Size : Refer to dwg
Cut-Out : Refer to dwg
Light Source : LED

Light Source : LED

Colour Temperature : 3000K

Country of Origin : PRC

Supplier : Metropolis

Contact : Ms Eva Lam

Tel. : (852) 2893 8686


Fax. : (852) 2893 0606

Email : metro@elighting.asia

Remark : 1. Contractor is not bound to the specified supplier. Alternative or equivalent may be acceptable.

2. The decorative lighting specifications are issued for design intent only. For custom made lighting, contractor is required to develop the design and submit shop / fabrication drawings for designer's approval.

3. The numbers, locations and connection details of remote transformers to be responsible by contractor.

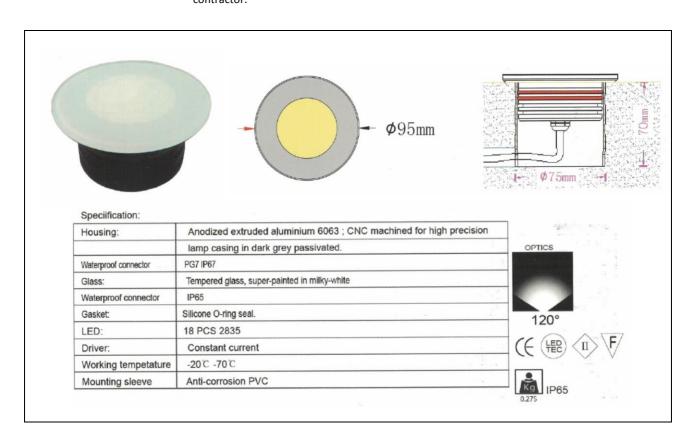



Project: CIC Innovation Center (IC) Project No. APQ17-0117

First Issue Date 02-05-2017

Rev. Rev. Date

Code : L-02

Location : Outdoor area Light Fitting Type : Outdoor Tree light Model : MN-130-10W

Description : Refer to manufacturer's specification

Colour : Matte Black Size Refer to dwg Cut-Out Refer to dwg

Light Source LED Colour Temperature : 3000K Country of Origin : PRC Supplier : Metropolis Contact : Ms Eva Lam : (852) 2893 8686 Tel. : (852) 2893 0606 Fax. Email : metro@elighting.asia

Remark Contractor is not bound to the specified supplier. Alternative or equivalent may be acceptable. : 1.

> The decorative lighting specifications are issued for design intent only. For custom made lighting, contractor is required to develop the design and submit shop / fabrication drawings for designer's approval.

> 3. The numbers, locations and connection details of remote transformers to be responsible by contractor.



MN-130-10W

Power: Bridgelux COB 10W

Color Temp.: 3000K

ø80 x 105 x H185mm Dimension:

25° Beam Angle:

Base: 插地 or 座地

IP65 IP Level:

Silver or Black Color:

Project: CIC Innovation Center (IC) Project No. APQ17-0117

First Issue Date 02-05-2017 :

Rev. Rev. Date

Code : L-03 (Dimmable))

Location : Focus Group Meeting Rooms

Light Fitting Type : LED Panel Model : EW-PL60120

Description : Refer to manufacturer's specification

Colour : Matte Black Size : 1200 x 600mm Cut-Out Refer to dwg

Light Source : LED Colour Temperature : 4000K Country of Origin : PRC

Supplier : ELWIN Lighting & Electrical Co. Ltd

Contact : Mr Andrew Pun

: (852) 3698 2989; M: (852) 9097 9152 Tel.


(852) 3003 3076 Fax.

Email mercury02@netvigator.com

Remark Contractor is not bound to the specified supplier. Alternative or equivalent may be acceptable. : 1.

> The decorative lighting specifications are issued for design intent only. For custom made lighting, contractor is required to develop the design and submit shop / fabrication drawings for designer's approval.

> 3. The numbers, locations and connection details of remote transformers to be responsible by contractor.

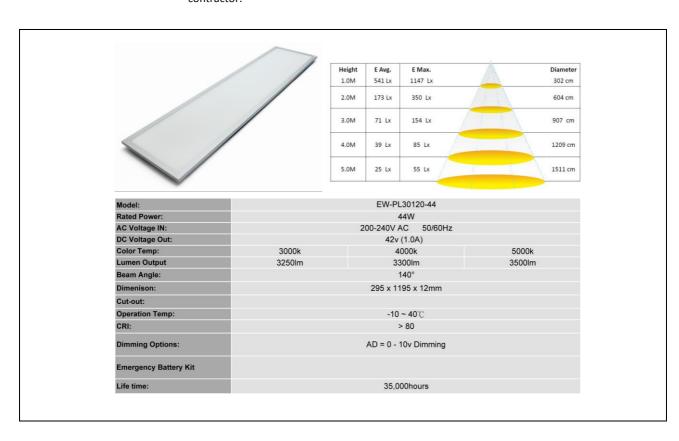



Project: CIC Innovation Center (IC) Project No. APQ17-0117

First Issue Date 02-05-2017

Rev. Rev. Date

Code L-04A (Dimmable)

Location Focus Group Meeting Rooms Light Fitting Type LED Recessed Downlight

Model : CG-DL06-15

Description Refer to manufacturer's specification

Colour Matte Black Size Refer to dwg Cut-Out Refer to dwg

Light Source LED Colour Temperature 4000K Country of Origin PRC

Supplier ELWIN Lighting & Electrical Co. Ltd

Contact Mr Andrew Pun

Tel. (852) 3698 2989; M: (852) 9097 9152


(852) 3003 3076 Fax.

Email mercury02@netvigator.com

Remark : 1. Contractor is not bound to the specified supplier. Alternative or equivalent may be acceptable.

> The decorative lighting specifications are issued for design intent only. For custom made lighting, contractor is required to develop the design and submit shop / fabrication drawings for designer's approval.

> 3. The numbers, locations and connection details of remote transformers to be responsible by contractor.

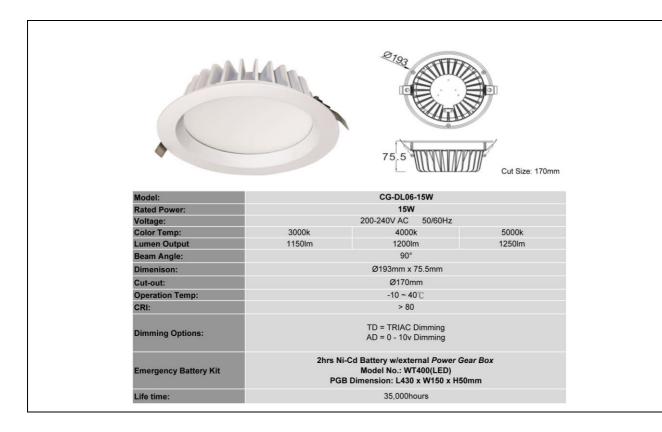

Project: CIC Innovation Center (IC) Project No. APQ17-0117

First Issue Date 02-05-2017

Rev. Rev. Date

Code L-04B Location Toilet

Light Fitting Type LED Recessed Downlight

Model : CG-DL06-15

Description Refer to manufacturer's specification

Colour White Size Refer to dwg Refer to dwg Cut-Out

Light Source LED Colour Temperature 4000K : Country of Origin PRC

Supplier ELWIN Lighting & Electrical Co. Ltd

Contact Mr Andrew Pun :

Tel. (852) 3698 2989; M: (852) 9097 9152

Fax. (852) 3003 3076

Email mercury02@netvigator.com

Remark 4. Contractor is not bound to the specified supplier. Alternative or equivalent may be acceptable. :

> The decorative lighting specifications are issued for design intent only. For custom made lighting, 5. contractor is required to develop the design and submit shop / fabrication drawings for designer's approval.

> The numbers, locations and connection details of remote transformers to be responsible by 6. contractor.



Ø111

ARCHITECTURAL LIGHTING SPECIFICATION

Project: CIC Innovation Center (IC) Project No. APQ17-0117 02-05-2017

First Issue Date Rev.

Rev. Date

Code L-05A (Dimmable)

Location Reception

Light Fitting Type **LED Twin Spotlight** Model : CG-DL06-15

Description Refer to manufacturer's specification

Colour Matte Black Size Refer to dwg Cut-Out Refer to dwg

Light Source LED 4000K Colour Temperature Country of Origin PRC

Supplier ELWIN Lighting & Electrical Co. Ltd

Contact Mr Andrew Pun

(852) 3698 2989; M: (852) 9097 9152 Tel.

(852) 3003 3076 Fax.

Email mercury02@netvigator.com

Remark : 1. Contractor is not bound to the specified supplier. Alternative or equivalent may be acceptable.

> The decorative lighting specifications are issued for design intent only. For custom made lighting, contractor is required to develop the design and submit shop / fabrication drawings for designer's approval.

> 3. The numbers, locations and connection details of remote transformers to be responsible by contractor.



Project: CIC Innovation Center (IC) Project No. APQ17-0117

First Issue Date 02-05-2017

Rev. Rev. Date

Code : L-05B

Location : Exhibition Area 1 & 2 Light Fitting Type : LED Twin Spotlight Model : CG-DL06-15

Description : Refer to manufacturer's specification

Colour : Matte Black Size Refer to dwg Cut-Out Refer to dwg

Light Source LED Colour Temperature : 4000K Country of Origin : PRC

Supplier : ELWIN Lighting & Electrical Co. Ltd

Contact : Mr Andrew Pun

: (852) 3698 2989; M: (852) 9097 9152 Tel.

(852) 3003 3076 Fax.

Email mercury02@netvigator.com

Remark : 1. Contractor is not bound to the specified supplier. Alternative or equivalent may be acceptable.

> The decorative lighting specifications are issued for design intent only. For custom made lighting, contractor is required to develop the design and submit shop / fabrication drawings for designer's approval.

> 3. The numbers, locations and connection details of remote transformers to be responsible by contractor.



AL Design

TM

Project: CIC Innovation Center (IC) Project No. : APQ17-0117

First Issue Date : 02-05-2017

Rev. : A

Rev. Date : 11-05-2017

Code : L-06 Location : Reception

Light Fitting Type : LED Recessed Downlight (Dimmable)

Model : Mini Trim 2 XCA

Description : Refer to manufacturer's specification

Colour : Matte White
Size : Refer to dwg
Cut-Out : Refer to dwg
Light Source : LED

Light Source : LED
Colour Temperature : 4000K
Country of Origin : PRC
Supplier : Zodiac

Contact : Mr Blaze Chow

Tel. : (852) 2898 7615 / (852) 9751 5730

Fax. : (852) 2558 3114

Email : blaze.chow@zodiaclighting.com

Remark : 1. Contractor is not bound to the specified supplier. Alternative or equivalent may be acceptable.

2. The decorative lighting specifications are issued for design intent only. For custom made lighting, contractor is required to develop the design and submit shop / fabrication drawings for designer's approval.



Project: CIC Innovation Center (IC) Project No. APQ17-0117

First Issue Date 02-05-2017

Rev. Rev. Date

Code L-07

Location Exhibition Area 2 Light Fitting Type LED Track light Model : CG-CT004

Description Refer to manufacturer's specification

Colour Matte Black Size Refer to dwg Cut-Out Refer to dwg

Light Source LED 4000K Colour Temperature Country of Origin PRC

Supplier ELWIN Lighting & Electrical Co. Ltd

Contact Mr Andrew Pun


Tel. (852) 3698 2989; M: (852) 9097 9152

(852) 3003 3076 Fax.

Email mercury02@netvigator.com

Remark 1. Contractor is not bound to the specified supplier. Alternative or equivalent may be acceptable. :

> The decorative lighting specifications are issued for design intent only. For custom made lighting, contractor is required to develop the design and submit shop / fabrication drawings for designer's approval.

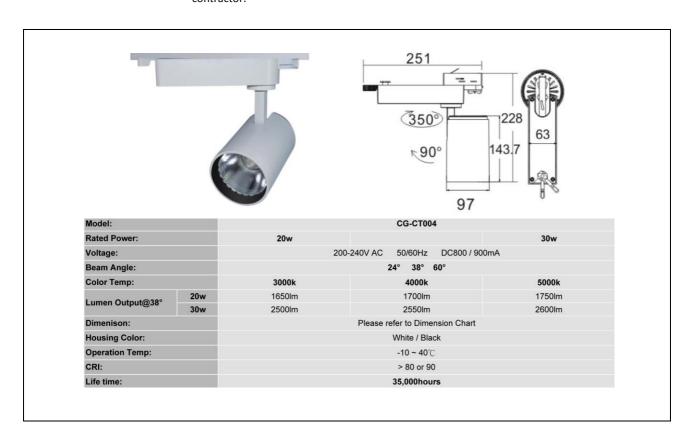

Project: CIC Innovation Center (IC) Project No. APQ17-0117

First Issue Date 02-05-2017

Rev. Rev. Date

Code L-08 Location : Office Light Fitting Type : LED Panel Model : FL-913

Description : Refer to manufacturer's specification

Colour : White Size 1550 x 150mm Cut-Out Refer to dwg

Light Source LED : 4000K Colour Temperature Country of Origin : PRC

Supplier **Future Lighting Collection Limited**

Contact Ms Ceci Wong


Tel. (852) 3104 0698 / (852 6998 3878)

Fax.

Email project@flcl.com.hk

Remark 1. Contractor is not bound to the specified supplier. Alternative or equivalent may be acceptable. :

> The decorative lighting specifications are issued for design intent only. For custom made lighting, contractor is required to develop the design and submit shop / fabrication drawings for designer's approval.

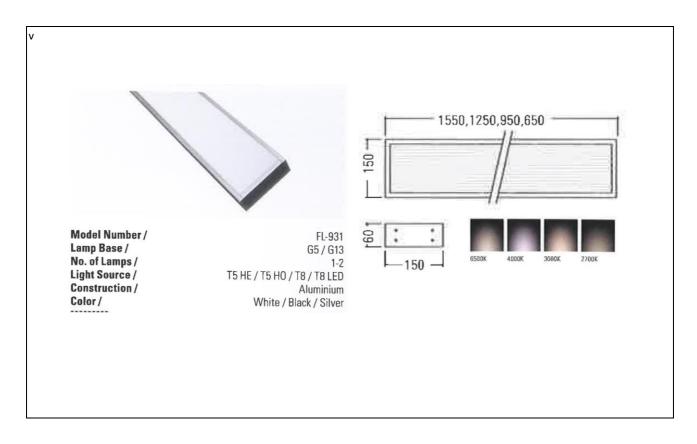

Project: CIC Innovation Center (IC) Project No. APQ17-0117

First Issue Date 02-05-2017

Rev. Rev. Date

Code L-09

Location Exhibition Area 1 Light Fitting Type : LED Spotlight Model : FL-1154

Description Refer to manufacturer's specification

Colour Black Size Refer to dwg Cut-Out Refer to dwg

Light Source LED Colour Temperature 4000K Country of Origin PRC

Supplier **Future Lighting Collection Limited**

Contact Ms Ceci Wong

Tel. (852) 3104 0698 / (852 6998 3878)

Fax.

Email project@flcl.com.hk

Remark 1. Contractor is not bound to the specified supplier. Alternative or equivalent may be acceptable. :

> The decorative lighting specifications are issued for design intent only. For custom made lighting, contractor is required to develop the design and submit shop / fabrication drawings for designer's approval.





Project: CIC Innovation Center (IC) Project No. APQ17-0117

First Issue Date 02-05-2017

Rev. Rev. Date

Code : L-10 Location : Outdoor

Light Fitting Type : Outdoor Wall Lamp

Model : MP174A

Description : Refer to manufacturer's specification

Colour : Black Size Refer to dwg Cut-Out Refer to dwg Light Source LED

Colour Temperature : 3000K Country of Origin : PRC Supplier : Metropolis Contact : Ms Eva Lam : (852) 2893 8686 Tel. : (852) 2893 0606 Fax. Email : metro@elighting.asia

Remark : 1. Contractor is not bound to the specified supplier. Alternative or equivalent may be acceptable.

> The decorative lighting specifications are issued for design intent only. For custom made lighting, contractor is required to develop the design and submit shop / fabrication drawings for designer's approval.

> 3. The numbers, locations and connection details of remote transformers to be responsible by contractor.





Lamp: COB LED 2 x 5W Color Temp.: 3000K / 4000K / 6000K Lumen: 1000 lm CRI: 85 Beam Angle: 38° Tilt Angle: Fixed Dimension: Ф90 х 170 Material: Aluminium IP Level: **IP44** Color: **Anodized Black**



Project: CIC Innovation Center (IC) Project No. APQ17-0117

First Issue Date 02-05-2017

Rev. Rev. Date

Code : L-11 Location : Pantry Light Fitting Type : Pendant Lamp Colour : White Colour Temperature : 3000K

Supplier : By Contractor

Remark : 1. Contractor is not bound to the specified supplier. Alternative or equivalent may be acceptable.

> The decorative lighting specifications are issued for design intent only. For custom made lighting, contractor is required to develop the design and submit shop / fabrication drawings for designer's approval.





Project: CIC Innovation Center (IC) Project No. APQ17-0117 First Issue Date 02-05-2017

Rev.

Rev. Date


Code : L-12

Location : Meeting Room Light Fitting Type : Pendant Lamp Brand : Philips Colour : White Colour Temperature : 3000K

Supplier : By Contractor

Remark Contractor is not bound to the specified supplier. Alternative or equivalent may be acceptable. : 1.

> The decorative lighting specifications are issued for design intent only. For custom made lighting, contractor is required to develop the design and submit shop / fabrication drawings for designer's approval.

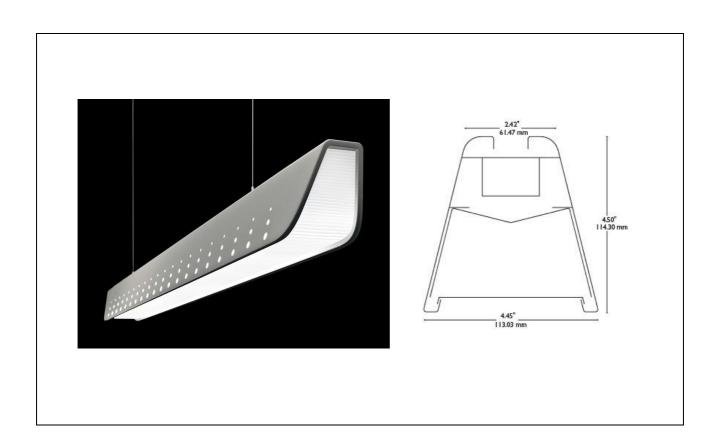

Project: CIC Innovation Center (IC) Project No. APQ17-0117

First Issue Date 02-05-2017

Rev. Rev. Date

Code : L-13 Location : Office

Light Fitting Type : LED Single Spotlight

Model : CG-DL06-15

Description : Refer to manufacturer's specification

Colour : Matte Black Size Refer to dwg Cut-Out Refer to dwg

Light Source : LED Colour Temperature : 4000K Country of Origin : PRC

Supplier : ELWIN Lighting & Electrical Co. Ltd

Contact : Mr Andrew Pun

Tel. : (852) 3698 2989; M: (852) 9097 9152

: (852) 3003 3076 Fax.


Email : mercury02@netvigator.com

Remark : 1. Contractor is not bound to the specified supplier. Alternative or equivalent may be acceptable.

> The decorative lighting specifications are issued for design intent only. For custom made lighting, contractor is required to develop the design and submit shop / fabrication drawings for designer's approval.





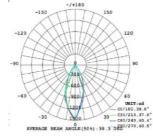





Model:	CG-COB111-18			
Rated Power:	18w			
Voltage:		200-240V AC 50/60Hz 500mA		
Beam Angle:		25° 40° 60°		
Color Temp:	3000k	4000k	5000k	
Lumen Output:	1560lm	1600lm	1820lm	
Dimenison:	Ø111mm x H60mm			
Surface Color:	White / Black			
Operation Temp:	-10 ~ 40℃			
CRI:	> 80			
Housing	L152 x W152 x H122mm (Trimless recessed)			
Emergency Battery Kit	2hrs Ni-Cd Battery w/external <i>Power Gear Box</i> Model No.: WT400(LED) PGB Dimension: L430 x W150 x H50mm			
Life time:	35,000hours			

Project: CIC Innovation Center (IC) Project No. : APQ17-0117

First Issue Date : 02-05-2017

Rev. : A

Rev. Date : 11-05-2017

Code : L-14
Location : Reception
Light Fitting Type : Pendant Lamp
Model : ROAD 00-3251-14-M1

Description : Refer to manufacturer's specification

Colour : White
Size : Refer to dwg
Cut-Out : Refer to dwg

Light Source : LED
Colour Temperature : 4000K
Country of Origin : PRC
Supplier : Zodiac

Contact : Mr Blaze Chow


Tel. : (852) 2898 7615 / (852) 9751 5730

Fax. : (852) 2558 3114

Email : blaze.chow@zodiaclighting.com

Remark : 4. Contractor is not bound to the specified supplier. Alternative or equivalent may be acceptable.

 The decorative lighting specifications are issued for design intent only. For custom made lighting, contractor is required to develop the design and submit shop / fabrication drawings for designer's approval.

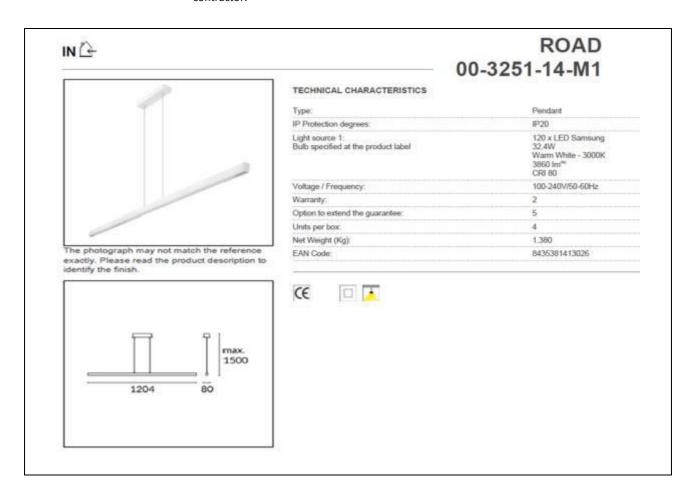



Project: CIC Innovation Center (IC) Project No. APQ17-0117

First Issue Date 02-05-2017

Rev. Rev. Date

Code : L-15 Light Fitting Type : LED Strip

Model : Flexible LED strip

Description : Refer to manufacturer's specification

Colour : Transparent Size : Refer to dwg Cut-Out : Refer to dwg

Light Source : LED Colour Temperature : 4000K Country of Origin : PRC

Supplier : By Contractor

Remark : 1. Contractor is not bound to the specified supplier. Alternative or equivalent may be acceptable.

> The decorative lighting specifications are issued for design intent only. For custom made lighting, contractor is required to develop the design and submit shop / fabrication drawings for designer's approval.

> 3. The numbers, locations and connection details of remote transformers to be responsible by contractor.

DESCRIPTION: FLEXIBLE LED STRIP,14.4W PER METER

FINISH: TRANSPARENT

DIMENSIONS: W:13MM X H-4MM X L:5000MM

CUTTING UNIT: EVERY 100MM

60 X SMD5050 0.24W 3000K LED,CRI60 LAMP TYPE: 24V DC LED POWER SUPPLY NOTES:

ILLUSTRATION:





Project: CIC Innovation Center (IC)

Project No.

: APQ17-0117

First Issue Date : 02-05-2017

Rev. Date : -

Code : L-16

Light Fitting Type : Blue LED Strip
Model : Flexible LED strip

Description : Refer to manufacturer's specification

Colour : Ice Blue
Size : Refer to dwg
Cut-Out : Refer to dwg

Light Source : LED Country of Origin : PRC

Supplier : By Contractor

Remark : 1. Contractor is not bound to the specified supplier. Alternative or equivalent may be acceptable.

 The decorative lighting specifications are issued for design intent only. For custom made lighting, contractor is required to develop the design and submit shop / fabrication drawings for designer's approval.



Project: CIC Innovation Center (IC) Project No. : APQ17-0117

First Issue Date : 11-05-2017

Rev. Date : -

Code : L-17

Light Fitting Type : LED Desk Lamp Model : MJTD01YL

Description : Refer to manufacturer's specification

Colour : White
Size : Refer to dwg
Cut-Out : Refer to dwg

Light Source : LED


Country of Origin : PRC

Supplier : Xiaomi

Remark

: 1. Contractor is not bound to the specified supplier. Alternative or equivalent may be acceptable.

2. The decorative lighting specifications are issued for design intent only. For custom made lighting, contractor is required to develop the design and submit shop / fabrication drawings for designer's approval.

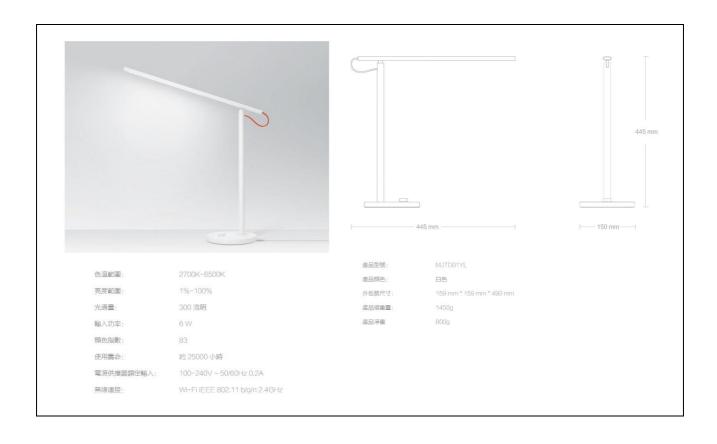



Category 6 U/UTP Cable

Product Fact

- Exceeds TIA/EIA-568-B.2-1 Category 6 and ISO 11801 Class E specifications
- X-Web Spacer to maximize NEXT performance
- Exceeds all requirements for Gigabit Ethernet
- AWG 23 solid conductor
- Lead-free jacketing

	Fire Rating	Outside Dimensions	Colour	Packing	Part Number
Γ	LSZH	6 mm	White	305m Reel-in-Box	219585-2
Ī	CMR	6.40 mm	White	1000ft Reel-in-Box	6-1427200-2
	CMR	6.40 mm	Blue	1000ft Reel-in-Box	9-1427200-6
	CM	6.40 mm	Blue	305m Reel-in-Box	1427254-6

LSZH sheath conform to IEC 60332-1, IEC 60754-1, IEC 60754-2 and IEC 61034-2

Category 6 UTP Patch Panel

Product Fact

- Meets or exceeds TIA and ISO Category 6 component performance requirements
- Ports may be individually replaced
- Packaged unloaded with jacks bagged separately for termination with SL Series Jack Termination Tool
- Universal wiring may be terminated to T568A or T568B
- Replacement labels and clear label covers can be ordered
- 12-Port Mini Patch Panels mount vertically on 89D bracket (included)

Description	Height	Width	Style	Figure	Part Number
12-Port	10.00"	2.3"	Flat	А	1375013-2
24-Port	1U (1.75")	19.0"	Flat	-	1933796-2
24-Port	1U (1.75")	19.0"	Angled	-	1933798-2
48-Port	1U (1.75")	19.0"	Flat	-	1933458-1
48-Port	1U (1.75")	19.0"	Angled	-	1933658-1
48-Port	2U (3.5")	19.0"	Flat	В	1933797-2
96-Port	4U (7")	19.0"	Flat	-	1375016-2







Memorandum of Agreement

of

Fitting Out Works for the Construction Innovation and Technology Application Centre (CITAC)

for

the Construction Industry Council

May 2017

© 2017 Construction Industry Council

The contents of this document remain the property of the CIC, and may not be reproduced in whole or in part without the expressed permission of the CIC.

To be Signed by a Contractor

MEMORANDUM OF AGREEMENT

MEMORA	ANDUM OF AGREEMENT made on theday of
2017 BET	WEEN THE CONSTRUCTION INDUSTRY COUNCIL of ¹
	(hereinafter called "the Employer") of the one
part and ² of ³	/L 11 - J
<u> </u>	(hereinafter called "the") of the other part WHEREAS the Employer requires the Contractor to
	omplete and maintain the whole of the said works in respect of the Fitting Out
	the Construction Innovation and Technology Application Centre for the
Employer	(hereinafter called "the Assignment") and details of which are set out in the
_	nt Brief annexed hereto AND WHEREAS the Contractor has agreed to complete
	in accordance with the Assignment Brief, Conditions of Employment annexed reinafter referred to as "the Conditions"), and subject to the payment to him by
	entarted referred to as the Conditions), and subject to the payment to find by byer of the fees and other payments set out in the Fee Proposal and the
-	s annexed hereto.
NOW THE	EREFORE IT IS AGREED AS FOLLOWS :-
1.	This Agreement shall comprise:-
	(a) Conditions of Tender and Appendices
	(b) Special Conditions of Tender
	(c) Form of Tender
	(d) CIC's General Conditions of Contract and Guidelines for Works or
	Services(2b-CAR) *
	(e) Assignment Brief and its Annexes
	(f) Technical Proposal and Fee Proposal
	(g) General Conditions of Employment
	(h) Any relevant correspondence
	all of which are annexed hereto.
	*Delete where inappropriate
2	
2.	The Director for the purposes of this Agreement shall be 4

3. In consideration of the payments made at the times and in the manner set forth in the Agreement by the Employer, the Contractor hereby jointly and severally undertakes to perform and complete the said works subject to and in accordance with the Agreement.

IN WITNESS this Agreement has been executed as a deed on the date first above written

	SIGNED for and on behalf of the Employer by ⁶)))
	in the presence of	
	Signature, name and address	
(a)	SIGNED for and on behalf of the Contractor by ⁷)))
	in the presence of	
	Signature, name and address	
	OR	
(b)	SIGNED for and on behalf of and as lawful attorney for ² under power of attorney dated By in the presence of))))
	Signature, name and address	

OR

Memorandum of Agreement

(c) SIGNED on behalf of the Contractor by ⁸

)
)

in the presence of

Signature, name and address

NOTES: (for preparation of but not inclusion in the engrossment of the Memorandum of Agreement)

Case (a) is for use where the Contractor executes the Assignment.

Case (b) is for use where the Contractor executes through an attorney.

Case (c) is for use where the Contractor comprises a partnership or consortium. As regards the attestation clause, each member forming the partnership or consortium just executes.

- 1 Insert the address for service of documents.
- 2 Insert the name of the Contractor.
- 3 Insert the address of the Contractor.
- 4 Insert the post title.
- Delete "jointly and severally" where cases (a) or (b) apply. Initial the deletion by the signatories of the Memorandum of Agreement.
- 6 Insert the name and appointment of the officer.
- Insert the name(s) and capacity of the person(s) (usually the Directors of the Contractor) executing the Agreement for the Contractor. The person's authority to execute the Agreement for the Contractor is prescribed in the Memorandum of Association of the Contractor.
- 8 Insert the names of the partners.

General Conditions of Employment

of

Fitting Out Works for the Construction

Innovation and Technology Application Centre (CITAC)

for

the Construction Industry Council

May 2017

© 2017 Construction Industry Council

The contents of this document remain the property of the CIC, and may not be reproduced in whole or in part without the expressed permission of the CIC.

Table of Contents

Clau	ise	Page
1	Definitions	CE-4
2	Singular and Plural	CE-5
3	Marginal Headings	CE-5
4	Laws	CE-5
5	Interpretation	CE-5
6	Memorandum of Agreement	CE-5
7	Documents Mutually Explanatory	CE-5
8	Use of English Language and Metric Units	CE-5
9	Confidentiality	CE-6
10	Information to be supplied by the Employer	CE-6
11	Information to be supplied by the Contractors	CE-7
12	Retention of Documents and Audit Inspection	CE-7
13	Attendance at Meetings	CE-7
14	Facilities for Inspection	CE-7
15	Approval of Documents	CE-7
16	Delegation of Employer's Power	CE-8
17	Amendments to the Contract Conditions	CE-8
18	Written Approval	CE-8
19	Consultation	CE-8
20	Response to Queries	CE-8
21	Exclusive Ownership	CE-9
22	Care and Diligence	CE-9
23	Instruction and Procedure	CE-10
24	Approval for Variations and Claims	CE-10
25	Referral of Variations and Claims	CE-10
26	Programme to be Submitted and Agreed	CE-11

27	Payment	CE-11
28	Fees to be Inclusive	CE-11
29	Payment in Hong Kong Dollars	CE-11
30	Expenses incurred in currencies other than Hong Kong dollars (not used)	CE-12
31	Payment of Accounts	CE-12
32	Rendering of Accounts	CE-12
33	Payment for Additional Services	CE-12
34	Reduction of Lump Sum Fees	CE-13
35	Notifications and Payment for Delays	CE-13
36	Resident Site Staff (not used)	CE-14
37	Non-Assignment	CE-14
38	Employment and Replacement of sub-consultants / sub-contractors	CE-14
39	Liability of Contractor for acts and default of sub-consulta / sub-contractors	
40	Publicity relating to contract works (not used)	CE-15
41	Suspension, resumption or termination	CE-15
42	Special Risks (not used)	CE-16
43	Appeal to Director	CE-16
44	Settlement of Disputes	CE-16
45	Prevention of Bribery	CE-17
46	Declaration of Interest	CE-17
47	Insurance	CE-17
48	Safety Precaution	CE-18
49	Avoidance of Nuisance and Making Good Working Areas	CE-18
50	Disclosure of Information	CE-18
51	Code of Conduct for Staff	CE-19
52	Probity	CE-19

General Conditions of Employment

53	Copyright	CE-19
54	Contractor's Claims for Extras	CE-20
55	Commencement of the Works	CE-20
56	Time for Completion	CE-20
57	Liquidated Damages	CE-20
58	Completion of the Works	CE-21
59	Variations	CE-23
60	Valuation of Variations	CE-24
61	Rights of Third Parties	CE-26

General Conditions of Employment for Fitting Out Works for the Construction Innovation and Technology Application Centre (CITAC) for the Construction Industry Council

1 Definitions

In the Agreement as hereinafter defined the following words and expressions shall have the meaning hereby assigned to them except when the context otherwise requires:

"Agreement" means and includes the Memorandum of Agreement, Conditions of Employment for Fitting out works for Construction Innovation and Technology Application Centre (CITAC) for the Construction Industry Council, the Assignment Brief and its Annexes, Fee Proposal and such other documents as may be referred to in the Memorandum of Agreement.

"Assignment" means that part of the Project undertaken by the Contractor as detailed in the Assignment Brief and its Annexes.

"Assignment Brief" means the document attached to the Memorandum of Agreement which describes the Project and sets out the details of the Assignment.

"Contractor" means the person, firm or company named in the Memorandum of Agreement and includes the Contractor's permitted assignees.

"Deliverables" means all the reports, drawings, documents, software, certificates and other items described in the Assignment Brief and its Annexes which are to be produced by the Contractor under the Assignment.

"Director" means the person designated in the Memorandum of Agreement to act as the Director or such other person as may be appointed from time to time by the Employer and notified in writing to the Contractor to act as the Director for the purposes of this Agreement and the person so designated or appointed.

"Employer" means the Construction Industry Council.

"Government" means the Government of the Hong Kong Special Administrative Region.

"Project" means the scheme described in the Assignment Brief and its Annexes, of which the Assignment forms a part.

"Services" means duties, work, services, surveys and investigations to be carried out and obligations to be fulfilled by the Contractor under this Agreement.

2 Singular and Plural

Words and expressions in the singular include the plural and words and expressions in the plural include the singular where the context so implies.

3 Marginal Headings

The index, marginal notes or headings in any documents forming part of the Agreement shall not in any way vary, limit or extend the interpretation of the Agreement.

4 Laws

The Agreement shall be governed by and construed according to the laws for the time being in force in HKSAR.

5 Interpretation

The Interpretation and General Clauses Ordinance shall apply to the Agreement.

6 Memorandum of Agreement

The Contractor when called upon to do so shall enter into and execute a Memorandum of Agreement which shall be prepared at the cost of the Employer in the form annexed with such modifications as may be necessary.

7 Documents Mutually Explanatory

- (A) Save to the extent that any Special Conditions of Employment provides to the contrary the provisions of the Conditions of Employment shall prevail over those of any other document forming part of the Agreement.
- (B) Subject to sub-clause (A) of this Clause the several documents forming the Agreement are to be taken as mutually explanatory of one another but in the case of ambiguities and discrepancies the same shall be explained and adjusted by the Employer.

8 Use of English Language and Metric Units

All the correspondence in connection with this Agreement shall be in English. All Deliverables shall be in English and metric units shall be used throughout, unless otherwise stated in the Assignment Brief or approved by the Employer.

9 Confidentiality

- (A) Save for the performance of the Services the Contractor shall not disclose the terms and conditions of this Agreement or any information, specifications, documents, drawing, plan, software, data or particulars furnished by or on behalf of the Employer in connection therewith, to any person other than a person employed or engaged by the Contractor in carrying out this Assignment or any approved sub-consultants / sub-contractors or the Contractor's legal and insurance advisers.
- (B) Any disclosure to any person, sub-consultants / sub-contractors or advisers permitted under sub-clause (A) of this Clause shall be in strict confidence and shall extend only so far as may be necessary for the purpose of this Agreement and the Contractor shall take all necessary measures to ensure the confidentiality of any such disclosure.
- (C) The Contractor shall not without the prior written consent of the Director which approval shall not be unreasonably withheld publish, either alone or in conjunction with any other person, in any newspaper, magazine, or periodical, any article, photograph or illustration relating to this Agreement.
- (D) If the Contractor has provided the Employer with documents and information which he has declared in writing to be confidential and stamped accordingly whether in relation to his practice or special circumstances or for other good causes, unless the Director within two months of receipt of such information by notice in writing disagrees, then that information will be treated as confidential. The Employer shall not permit the disclosure of such confidential information to third parties without the written consent of the Contractor.

10 Information to be supplied by the Employer

The Employer shall keep the Contractor informed on such matters as may appear to him to affect the performance of the Services and shall give such assistance, approvals, and decisions in writing as and when they shall reasonably be required for the performance of the Services.

11 Information to be supplied by the Contractors

The Contractor shall keep the Employer informed on all matters related to the Assignment within the knowledge of the Contractor including details of all staff employed by them in the performance of the Services and shall answer all reasonable enquiries received from the Employer and render reports at reasonable intervals when asked to do so and shall assist the Employer to form an opinion as to the manner in which they are proceeding with the Assignment.

12 Retention of Documents and Audit Inspection

- (A) For a period of 2 years commencing with the completion of any works contract, supervision of which is part of the Services, the Contractor shall retain and provide spaces for that purpose all his records, data, accounts and other information in respect of the services.
- (B) The Contractor shall give assistance to Employer for the purpose of audit inspection to inspect such records, data, accounts and other information whatsoever and shall answer queries or supply information reasonably requested by such personnel in pursuance of such audit inspection.

13 Attendance at Meetings

The Contractor shall, if reasonably possible, attend or be represented at all meetings convened by the Employer to which he may be summoned and shall advise and assist the Director and the Employer on all matters relating to the Services.

14 Facilities for Inspection

The Contractor shall at all time give to the Director, his representatives and any persons duly authorized by him reasonable facilities to inspect or view the documents, records and correspondence in his possession relevant to this Agreement.

15 Approval of Documents

- (A) The Contractor shall, when so requested by the Employer, submit to him for his approval such record, data, account or other documents, matters or things prepared by them as a direct requirement of the Assignment as he may specify or require.
- (B) No such approval shall affect the responsibility of the Contractor in connection with the Services.

16 Delegation of Employer's Power

The Contractor shall take instructions and directions and, where appropriate, receive the Employer's decisions and views only through the Employer and, subject to any limitations imposed by the Employer in any letter of authority granted by him, such other person to whom the Employer may delegate his powers.

17 Amendments to the Contract Conditions

- (A) The Employer shall make any changes to the Contract Conditions which he considers necessary or desirable for the successful completion of the Assignment or the Project.
- (B) Any queries on, or suggestions for amendments to the Contract Conditions shall be referred to the Employer for his clarification or instructions regarding further action.

18 Written Approval

The Contractor shall obtain the written approval of the Employer prior to entering into any commitment to expenditure for which there is provision for reimbursement under the Fee Proposal.

19 Consultation

The Contractor shall, as may be necessary for the successful completion of the Assignment, consult all authorities, or who may be appointed by the Employer in connection with the Assignment and bodies or persons affected by the Assignment.

20 Response to Queries

- (A) The Contractor shall respond to queries on the findings and conclusions of this Assignment raised during the period defined in the Assignment Brief for such queries by the Employer or by any Contractor who may be appointed by the Employer for the subsequent stage of the Project.
- (B) The Contractor shall use his best endeavours to respond to queries on the findings and conclusions of this Assignment raised after the period defined in the Assignment Brief for such queries by the Employer or any person who may be appointed by the Employer or nominated by the Employer.

21 Exclusive Ownership

The Employer shall become the exclusive owner of all Deliverables, save those Deliverables under licence or those Deliverables in respect of which there is a pre-existing copyright or patent, supplied or produced by, for or on behalf of the Contractor under this Agreement. The liability of the Contractor in respect of the Employer's use of such Deliverables shall be limited to liabilities arising from uses contemplated under this Agreement or expressly agreed to in writing by the Contractor. The Employer hereby:

- (i) Indemnifies the Contractor against all claims, damages, losses or expenses suffered by the Employer; and
- (ii) Agrees to indemnify the Contractor against all claims, made by third parties against the Contractor;

arise out of or in connection with a use by the Employer of any Deliverable which use was not contemplated under this Agreement or not expressly agreed to in writing by the Contractor.

22 Care and Diligence

- (A) The Contractor shall exercise all reasonable professional skill, care and diligence in the performance of all and singular the Services and, in so far as his duties are discretionary, shall act fairly between the Employers and any third party.
- (B) The Contractor shall, in respect of any work done or information supplied by or on behalf of the Employer, report to the Employer any errors, omissions and shortcomings of whatsoever nature of which the Contractor becomes aware in the performance of the Services.
- (C) The Contractor shall indemnify and keep indemnified the Employer against all claims, damages, losses or expenses arising out of or resulting from any negligence in or about the conduct of and performance by the Contractor, his servants or agents, of the Services.
- (D) In the event of any errors or omissions for which the Contractor is responsible and as a result of which the re-execution of the Services is required, the Contractor shall, without relieving any liability and obligation under the Agreement, at his own cost re-execute such Services to the satisfaction of the Employer.

23 Instruction and Procedure

The Contractor shall comply with all reasonable instructions of the Director or the Employer. The Employer shall issue to the Contractor general instructions on procedure and shall supply such additional information as may be required.

24 Approval for Variations and Claims

The Contractor shall obtain prior approval in writing of the Employer to the order of a variation to the contract works or to the commitment otherwise of the Employer to expenditure under the works contract other than in respect of claims, if the value of such order or commitment is estimated to exceed the sum specified in the Assignment Brief, or if not specified in the Assignment Brief, as advised in writing by the Employer. With the exception that in emergencies such prior approval shall not be required, provided that the order or other commitment is essential and that it is impractical to seek the prior approval of the Employer.

25 Referral of Variations and Claims

- (A) Notwithstanding the requirements of Clause 24 the Contractor shall:
 - (i) refer the details of every variation to the Contract Works under any such Works Contract, including the reasons for it and its estimated value, to the Employer for information as soon as the variation is ordered.
 - (ii) as soon as the value of a variation to the Contract Works has been determined, refer the details of the evaluation to the Employer for information.
 - (iii) report to the Employer all claims for additional payment made by the Contractor and, except for those solely in respect of agreement of rates, refer the principles underlying their assessment of each claim, to enable the Employer to provide its view of the matter before the Contractor reaches a decision; and
 - (iv) report to the Employer all delays to the progress of the Contract Works and, except for those delays solely in respect of inclement weather conditions, refer his assessment of granting of extension of time for completion, if any, to enable the Employer to provide its view of the matter before the Contractor reach a decision.

(B) The foregoing referrals and reporting to the Employer shall be in writing.

26 Programme to be Submitted and Agreed

- (A) The Contractor may propose changes to some or all of the key dates specified in the Assignment Brief for incorporation into the draft programme prepared under sub-clause (B) of this Clause. If any of such proposed changes are agreed by the Employer, who may impose conditions on his agreement, the corresponding key dates shall be changed and the changed dates incorporated into the draft programme.
- (B) The Contractor shall submit a draft programme which shall be in accordance with the requirements of the Assignment Brief and shall incorporate the key dates specified in the Assignment Brief, including any changes agreed under sub-clause (A) of this Clause. The Employer shall either agree the draft programme or instruct the Contractor to submit a revised draft programme which he shall do.
- (C) If the Employer does not agree the revised draft programme submitted under sub-clause (B) of this Clause, he shall issue an instruction under Clause 23 to the Contractor.
- (D) When the Employer has agreed the draft programme or the revised draft programme submitted under sub-clause (B) of this Clause or such other draft programme as may result from sub-clause (C) of this Clause, the agreed draft programme or revised draft programme shall become the Agreed Programme for carrying out the Assignment and shall be amended only with the approval of the Employer.

27 Payment

Payments under this Agreement shall be made in accordance with the Fee Proposal.

28 Fees to be Inclusive

Unless provided otherwise, the fees quoted in the Fee Proposal shall be inclusive of all labour, materials and expenses incurred in the performance of the Services.

29 Payment in Hong Kong Dollars

Unless provided otherwise, payments shall be made in Hong Kong dollars.

30 Expenses incurred in currencies other than Hong Kong dollars (not used)

Not used.

31 Payment of Accounts

- (A) Except as provided for in sub-clause (B) of this Clause accounts of all money due from the Employer to the Contractor in accordance with this Agreement shall be paid within 30 days after receipt of the Contractor's invoice by the Employer. In the event of failure by the Employer to make payment to the Contractor in compliance with the provisions of this Clause the Employer shall pay to the Contractor interest at the judgment debt rate prescribed from time to time by the Rules of the Supreme Court (Chapter 4 of the Laws of Hong Kong) (interpreted in accordance with the Hong Kong Reunification Ordinance) upon any overdue payment from the date on which the same should have been made.
- (B) If any item or part of an item of an account rendered by the Contractor is reasonably disputed or reasonably subject to question by the Employer, the Employer shall within 14 days after receipt of the invoice by the Employer inform the Contractor in writing of all items under dispute or subject to question. Payment by the Employer of the remainder of that account shall not be withheld on such grounds and the provisions of sub-clause (A) of this Clause shall apply to such remainder.

32 Rendering of Accounts

The Contractor shall render his accounts for interim payments in accordance with the Fee Proposal.

33 Payment for Additional Services

The Contractor shall be entitled to payment for the performance of any Services which he could not reasonably have anticipated at the time of entering into this Agreement resulting from:

- (i) explanations of adjustments made under sub-clause (B) of Clause 7;
- (ii) changes to the Assignment Brief made under sub-clause (A) of Clause 17;
- (iii) clarifications or instructions given under sub-clause (B) of Clause 17; and

(iv) instructions given under Clause 23.

Provided that such Services are not attributable to default on the part of the Contractor.

34 Reduction of Lump Sum Fees

If there shall be a reduction in the Services resulting from:

- (i) explanations or adjustment made under sub-clause (B) of Clause 7;
- (ii) changes to the Assignment Brief made under sub-clause (A) of Clause 17;
- (iii) clarifications or instructions given under sub-clause (B) of Clause 17; and
- (iv) instructions given under Clause 23;

then the Employer shall be entitled to a reduction in the lump sum fees in respect of such a reduction in the Services.

35 Notifications and Payment for Delays

- (A) The Contractor shall not be entitled to payment in respect of any additional costs he incurs as a result of delays arising during the performance of the Services if the causes of delay which are the fault of neither party.
- (B) The Contractor shall notify the Employer when a delay arises and shall detail what in his opinion are the reasons for the delay, the consequences or likely consequences of the delay and any additional costs he has incurred or may incur.
- (C) The Contractor shall keep such contemporary records as may reasonably be necessary to support any claim for payment under this Clause and shall give to the Employer details of the records being kept in respect thereof. Without necessarily admitting the Employer's liability, the Employer may require the Contractor to keep and agree with the Employer any additional contemporary records as are reasonable and may in the opinion of the Employer be material to the claim. The Contractor shall permit the Employer to inspect all records kept pursuant to this Clause and shall supply copies thereof as and when the Employer so requires.

- (D) After the giving of a notice of delay to the Employer under sub-clause (B) of this Clause, the Contractor shall, as soon as is reasonable, send to the Employer a first interim account giving full and detailed particulars of the circumstances giving rise to the delay and any additional costs he incurred. Thereafter at such intervals as the Employer may reasonably require, the Contractor shall send to the Employer further up-to-date accounts giving the accumulated total of the additional costs and any further full and detailed particulars in relation thereto.
- (E) If the Contractor fails to comply with the provisions of sub-clause (B) of this Clause in respect of any claim, such claim shall not be considered.
- (F) If the Contractor fails to comply with the provisions of sub-clauses (C) or (D) of this Clause in respect of any claim, the Employer may consider such claim only to the extent that the Employer is able on the information made available.
- (G) The Contractor shall take all reasonable steps to mitigate the costs which may be incurred as a result of the delays.

36 Resident Site Staff (not used)

Not used.

37 Non-Assignment

The Contractor shall not have the right to assign or transfer the benefit and obligations of this Agreement or any part thereof.

38 Employment and Replacement of sub-consultants / sub-contractors

The Consultant / Contractor shall obtain the prior written approval of the Employer to:

- (i) the appointment of sub-consultants / sub-contractors to undertake any part of the Services; and
- (ii) the replacement of any sub-consultants / sub-contractors appointed under sub-clause (i) of this Clause.

39 Liability of Contractor for acts and default of sub-consultants / sub-contractors

The appointment of sub-consultants / sub-contractors to undertake any part of the Services shall not relieve the Consultant / Contractor from any liability or obligation under this Agreement and he shall be responsible for the acts, default and neglects of any sub-consultants / sub-contractors, his agents, servants or workmen as fully as if they were the acts, default and neglects of the Contractor, his agents, servants or workmen.

40 Publicity relating to contract works (not used)

Not used.

41 Suspension, resumption or termination

- (A) This Agreement may be suspended or terminated by the Employer at any time, by the Employer giving the Contractor one months' notice in writing.
- (B) On suspension or termination, the Contractor shall be paid all fees and expenses commensurate with the Services performed by them up to the date of suspension or termination less all fees and expenses previously paid to the Contractor. The Contractor has the obligations to stop work immediately but in an orderly manner and do deliver to the Employer documents in its control relating to the Project. The Employer shall not be liable for any loss of profits and other losses incurred by the Contractor as a result of termination or suspension. The Employer reserves its right to claim for loss and damages against the Contractor as a result of termination of his contract including re-nominating the others to carry out and complete the remaining items. In case the payment balance is insufficient to cover the actual loss being suffered by the Employer, the Contractor has to reimburse the same accordingly.
- (C) In the event of suspension or termination the Contractor shall be entitled to reimbursement of the actual cost of or an amount in fair compensation for any financial commitment or obligation outstanding after the giving of the notice of suspension or termination which he has properly incurred in accordance with this Agreement prior to the giving of the notice of suspension or termination.
- (D) The payments referred to in sub-clauses (B) and (C) of this Clause shall be deemed in full and final payment for the Services up to the date of suspension or termination. The Contractor shall be entitled to such payments only if the suspension or termination is not attributable to default

on the part of the Contractor.

- (E) In the event of suspension and subsequent resumption of this Agreement the Contractor shall be reimbursed any expenses necessarily incurred as a result of such resumption.
- (F) If this Agreement is resumed any payment of fees under this Clause except in respect of abortive work that has to be re-done shall rank as payment on account towards the fees payable under this Agreement.
- (G) Should this Agreement continue to be suspended for a period of more than two years then either:
 - (i) it shall be terminated upon the written notice of either party; or
 - (ii) it may be renegotiated with the agreement of both parties.

42 Special Risks (not used)

Not used.

43 Appeal to Director

The Contractor shall have the right to appeal to the Director against any instruction or decision of the Employer which he considers to be unreasonable.

44 Settlement of Disputes

- (A) If any dispute or difference of any kind whatsoever shall arise between the Employer and the Contractor in connection with or arising out of this Agreement, either party shall be entitled to refer the dispute or difference to the Employer Delegates and the partner or director of the Contractor, who shall meet within 21 days of such matter being referred to them.
- (B) If the dispute or difference cannot be resolved within 2 months of a meeting under sub-clause (A) of this Clause or upon written agreement that the dispute or difference cannot be resolved, either the Employer or the Contractor may at any time thereafter request that the matter be referred to mediation in accordance with and subject to the Hong Kong International Arbitration Centre Mediation Rules or any modification thereof for the time being in force.
- (C) If the matter cannot be resolved by mediation, or if either the Employer or the Contractor do not wish the matter to be referred to mediation then either

the Employer or the Contractor may within the time specified herein require that the matter shall be referred to arbitration in accordance with and subject to the provisions of the Arbitration Ordinance (Chapter 609, Laws of Hong Kong) or any statutory modification thereof for the time being in force and any such reference shall be deemed to be a submission to arbitration within the meaning of such Ordinance. Any such reference to arbitration shall be made within 90 days of either the refusal to mediate, or the failure of the mediation.

(D) The Hong Kong International Arbitration Centre Domestic Arbitration Rules shall apply to any arbitration instituted in accordance with this Clause unless the parties agree to the contrary.

45 Prevention of Bribery

The Contractor shall inform his employees who are engaged either directly or indirectly on the formulation and implementation of a project of the Construction Industry Council that the soliciting or accepting of an advantage as defined in the Prevention of Bribery Ordinance is not permitted. The Contractor shall also caution his employees against soliciting or accepting any excessive hospitality, entertainment or inducements which would impair his impartiality in relation to the projects of the Construction Industry Council.

46 Declaration of Interest

- (A) On appointment and during the currency of this Agreement, the Contractor must declare any interest if it is considered to be in real or apparent conflict with the Services. The Contractor shall not undertake any services, which could give rise to conflict of interest, except with the prior approval of the Employer which approval shall not be unreasonable withheld.
- (B) In any case, the Contractor or any of his associated companies shall not undertake any services for a Contractor in respect of a contract between that contractor and the Employer for which the Contractor is providing a service to the Employer.

47 Insurance

(A) Without limiting his obligations and responsibilities nor his liability to indemnify the Employer under Clause 22 the Contractor shall, as from the date of commencement of this Agreement, and thereafter, maintain an insurance cover to meet any claims that may be made by the Employer in respect of any negligence in or about the conduct of and performance by the Contractor, his servants and agents of all and singular the Services.

- (B) In the event that through no fault of the Contractor it becomes impractical or unreasonable to maintain the said cover for the full period required by sub-clause (A) of this Clause, the Employer may approve alternative arrangements.
- (C) The foregoing insurance policy or policies shall be affected with an insurer (or insurers) and in terms acceptable to the Employer. Throughout the period of insurance the Contractor shall each year lodge with the Employer a certificate signed by and on behalf of the Contractor's insurers stating that the said policy or policies of insurance remain in force.
- (D) The amount of insurance cover as mentioned in sub-clause (A) of this Clause shall be a minimum of HK\$30 million.

48 Safety Precaution

The Contractor shall be responsible for taking all necessary steps in ensuring the safety of all persons and properties affected by the work stipulated under the Assignment in the vicinity of the works at all stages, whether or not they are engaged in the execution of the works.

49 Avoidance of Nuisance and Making Good Working Areas

- (A) All Contractor's operations shall be carried out in such a manner as to cause as little inconvenience as possible to residents, the public or the operation of construction sites. The Contractor shall be held responsible for any claim, which arises from non-compliance with this clause.
- (B) The Contractor shall take all reasonable care so as not to cause any damage to property or not to cause any nuisance. The Contractor shall indemnify the Employer against any claim arising from default of the Contractor in this respect.
- (C) The Contractor shall confine his operations to the minimum areas required for the works and shall at all times work in a tidy and considerate manner. As soon as work has been completed for any location, the Contractor shall remove all debris resulting from his activities and make good any damage.

50 Disclosure of Information

The Employer shall have the right to disclose to any person, whenever it considers appropriate or upon request by any third party (written or otherwise), and in such form and manner as it deems fit:

- (i) the fees, costs and expenses payable by the Employer for engaging the Contractor; and
- (ii) the fee proposal submitted by the Contractor.

51 Code of Conduct for Staff

- (A) The Contractor shall explicitly prohibit his employees from soliciting or accepting any advantages as defined in the Prevention of Bribery Ordinance when providing service in relation to this Assignment.
- (B) The Contractor shall implement a system requiring his employees to declare to him any interest they or their immediate families may have, or any conflict between their personal interest and their official positions, in relation to this Assignment.
- (C) The Contractor shall prohibit his employees to take up any outside work or employment, which could create or potentially give rise to a conflict of interest situation in connection with this Assignment.
- (D) The Contractor shall take adequate measures to protect any confidential / privileged information entrusted or obtained in relation to this Assignment; and his employees must not disclose to a third party any such information without prior consent from the Employer.
- (E) The Contractor shall prohibit his employees from introducing or recommending, directly or indirectly, service providers (including contractors) to owners, tenants or occupiers of premises in buildings covered by this Assignment.

52 Probity

The Contractor shall prohibit his employees, agents and sub-contractors who are involved in this Contract from offering, soliciting or accepting any advantage as defined in the Prevention of Bribery Ordinance, Cap 201 when conducting business in connection with this Contract. Any such offence committed by the Contractor or his employee or agent will render the tender null and void. The Employer may also terminate the contract granted.

53 Copyright

The copyright of all reports, documents, recommendations, Guidelines, Alerts and any other information prepared or collected by the Contractor's team, and their employees and agents in the course of this Agreement shall be with the Employer.

The Contractor shall not disclose any information in relation to this Consultancy to any third party without the written consent of the Employer.

54 Contractor's Claims for Extras

- (A) The Contractor shall send to the CIC once in every month an account giving particulars (as full and detailed as possible) of all claims for any extension of contract period and / or additional expense to which the Contractor may consider himself entitled and of all extra or additional work contained in Contractor's instructions issued during the preceding month.
- (B) No consideration will be given to any claim for extension of contract period and / or payment for additional expense or extra or additional work which has not been made within a reasonable time to enable the circumstances and reasons for extensions or the additional expense to be ascertained and evaluated.

55 Commencement of the Works

The Contractor shall commence the Works on the date for commencement of the Works as notified in writing by the Employer and shall proceed with the same with due diligence. The Contractor shall not commence the Works before the notified date for commencement.

56 Time for Completion

- (A) The Works and any Section thereof shall be completed within the time or times stated in the Contract calculated from and including the date for commencement notified by the Employer in accordance with Clause 55 or such extended time as may be determined in accordance with Clause 54.
- (B) General Holidays shall be included in the time for completion unless otherwise stated in the Contract.

57 Liquidated Damages

(A) If the Contractor fails to complete the Works or where the Works are divided into Sections any Section within the time for completion prescribed by Clause 56 or such extended time as may be granted in accordance with Clause 54, then the Employer shall be entitled to recover from the Contractor liquidated damages. The payment of such damages shall not relieve the Contractor from his obligations to complete the Works or from any other of his obligations under the Contract.

- (B) The liquidated damages shall be calculated using the rate per day prescribed in the Contract, either for the Works or for the relevant Section, whichever is applicable. Provided that, if the Employer certifies completion under Clause 58 of any part of the Works before completion of the Works or any part of any Section before the completion of the whole thereof, then the rate per day of liquidated damages for the Works or the relevant Section shall from the date of such certification be reduced in the proportion which the value of the part so certified bears to the value of the Works or the relevant Section, as applicable, both values as of the date of such certification shall be determined by the Employer.
- (C) The period for which liquidated damages shall be calculated shall be the number of days from the prescribed date for completion or any extension or revision thereof of the Works or the relevant Section until and including the certified date of completion.
- (D) All monies payable by the Contractor to the Employer pursuant to this Clause shall be paid as liquidated damages for delay and not as a penalty.

58 Completion of the Works

- (A) When the Works have been substantially completed and have satisfactorily passed any final test that may be prescribed by the Contract, the Contractor may serve notice in writing to that effect to the Employer, accompanied by an undertaking to carry out any outstanding work during the Defects Liability Period, requesting the Employer to issue a certificate of completion in respect of the Works. The Employer shall, within 21 days of the date of receipt of such notice either:
 - (i) issue a certificate of completion stating the date on which, in the Employer's opinion, the Works were substantially completed in accordance with the Contract and the Defects Liability Period shall commence on the day following the date of completion stated in such certificate, or
 - (ii) give instructions in writing to the Contractor specifying all the work which, in the Employer's opinion, is required to be done by the Contractor before such certificate can be issued, in which case the Contractor shall not be permitted to make any further request for a certificate of completion and the provisions of sub-clause (B) of this Clause shall apply.

- (B) Notwithstanding the provisions of sub-clause (A) of this Clause, as soon as in the opinion of the Employer the Works have been substantially completed and satisfactorily passed any final test which may be prescribed by the Contract, the Employer shall issue a certificate of completion in respect of the Works and the Defects Liability Period shall commence on the day following the date of completion stated in such certificate.
- (C) The Contractor shall carry out any outstanding work as soon as practicable after the issue of the certificate of completion or as reasonably directed by the Employer and in any event before the expiry of the Defects Liability Period. The Contractor's obligation to provide, service and maintain site offices, latrines and the like, shall continue for as long as may be required by the Employer.
- (D) The provisions of sub-clauses (A), (B) and (C) of this Clause shall apply equally to any Section.
- (E) (i) The Employer shall give a certificate of completion in respect of any part of the Works which has been completed to the satisfaction of the Employer and is required by the Employer for permanent occupation or use before the completion of the Works or any Section.
- (ii) The Employer, following a written request from the Contractor, may give a certificate of completion in respect of any substantial part of the Works which has been completed to the satisfaction of the Employer before the completion of the Works or any Section and is capable of permanent occupation and/or permanent use by the Employer.
 - (iii) When a certificate of completion is given in respect of a part of the Works such part shall be considered as completed and the Defects Liability Period for such part shall commence on the day following the date of completion stated in such certificate.
- (F) Any certificate of completion given in accordance with this Clause in respect of any Section or part of the Works shall not be deemed to certify completion of any ground or surface requiring reinstatement unless the certificate shall expressly so state.

59 Variations

- (A) The Employer may order in writing any Variation that is necessary for the completion of the Works or is in his opinion desirable for or to achieve the satisfactory completion and functioning of the Works. The Contractor shall forthwith carry out such Variation in accordance with the Employer's instruction.
- (B) No Variation ordered by the Employer shall in any way vitiate or invalidate the Contract but all such Variations shall be valued in accordance with Clause 60.
- (B) Any Variation ordered by the Employer may include a requirement for the Contractor to prepare and submit within 14 days of the Contractor receiving the Variation order, a lump sum quotation in writing for complying with the order.
- (D) (i) Notwithstanding sub-clause (C) of this Clause, prior to ordering a Variation, the Employer may request the Contractor to submit a lump sum quotation in writing within 14 days of receipt of such request, or within such other time as may be agreed between the Employer and the Contractor.
 - (ii) In the event that the Contractor is not subsequently instructed by the Employer to execute the Variation referred to in Clause 59(D)(i) above, the Contractor shall be entitled to any cost incurred in the preparation of the lump sum quotation which cost shall be ascertained and certified by the Employer.
- (E) (i) The Contractor may propose a Variation by submitting in writing to the Employer a proposal together with sufficient details and justification to show that:
 - (1) the time for construction of the Works can be reduced, and/or
 - (2) the future maintenance cost can be reduced, and/or
 - (3) the quality of design and/or the construction of the Works can be enhanced, and/or
 - (4) the Contract Sum can be reduced by the amount of the lump sum reduction that the Contractor can offer to the Employer, and
 - (5) in any event:
 - (1) the quality of the design or construction of the Works is not prejudiced, or
 - (2) the proposed Variation is in the interests of the Employer.
 - (ii) The Employer shall within 14 days of receipt of the Contractor's proposed Variation and supporting detailed information under sub-clause (E)(i) of this Clause, or within such time as may be agreed between the Contractor and the Employer, but solely at the discretion of the Employer, confirm

- whether or not he agrees to the proposed Variation and, if so, order the Contractor in writing to carry out the proposed Variation under this sub-clause.
- (iii) No adjustment shall be made to the Contract Sum by virtue of this sub-clause except the reduction pursuant to sub-clause (E)(i)(4) of this Clause.

60 Valuation of Variations

- (A) The Employer shall determine the sum (if any) which in his opinion shall be added to or deducted from the Contract Sum as a result of a Variation order given by the Employer under Clause 59 (other than a Variation ordered under sub-clause (E) of Clause 59) in accordance with the following principles:
 - (1) by valuation in accordance with sub-clause (D) of this Clause, or
 - (2) by acceptance of a lump sum quotation prepared and submitted by the Contractor to the Employer in accordance with sub-clauses (E) and (F) of this Clause.
- (B) The valuation of any Variation ordered by the Employer in accordance with sub-clause (A) of Clause 59 shall include the cost (if any) of any disturbance to, or prolongation of both varied and unvaried work.
- (C) In the event of the Employer and the Contractor failing to reach agreement on any rate or price under the provisions of sub-clause (D) of this Clause, the Employer shall fix such rate or price as shall in his opinion be reasonable and notify the Contractor accordingly.
- (D) The Employer shall determine the value of a Variation as follows:
 - (1) Any item of work omitted shall be valued at the rate or price set out in the Contract for such work or, in the absence of such a rate or price, at a rate or price agreed between the Employer and the Contractor.
 - (2) Any work carried out which is the same as or similar in character to and executed under the same or similar conditions and circumstances to any item of work priced in the Contract shall be valued at the rate or price set out in the Contract for such item of work.
 - (3) Any work carried out which is not the same as or similar in character to or is not executed under the same or similar conditions or circumstances to any item of work priced in the Contract shall be valued at a rate or price based on the rates or prices in the Contract so far as may be reasonable, failing which, at a rate or price agreed between the Employer and the Contractor.

Provided that if the nature or extent of any Variation ordered in accordance with sub-clause (A) of Clause 59 relative to the nature or extent of the Works or any part thereof shall be such that in the opinion of the Employer any rate or price contained in the Contract for any item of work is by reason of such Variation rendered unreasonable or inapplicable then a new rate or price shall be agreed between the Employer and the Contractor for that item, using the Contract rates or prices as the basis for determination and taking into account the provisions of sub-clause (B) of this Clause.

- (E) Any lump sum quotation submitted by the Contractor to the Employer in accordance with sub-clause (C) or (D) of Clause 59 shall indicate how the lump sum was calculated by showing separately full details of:
 - (1) the cost of complying with the order,
 - (2) the cost of preparing the lump sum quotation,
 - (3) the cost (if any) of any disturbance to or prolongation of varied and unvaried work as a consequence of complying with the order, and
 - (4) such other information as will enable the Employer to evaluate the lump sum quotation.
- (F) The Employer shall notify the Contractor not later than 14 days from the receipt of any such lump sum quotation (or such other time as may be agreed between the Employer and the Contractor) whether or not it has been accepted. If accepted, the amount specified in the lump sum quotation, or otherwise agreed between the Employer and the Contractor, shall be the full sum to which the Contractor is entitled for complying with that order.
- (G) In the event that a lump sum quotation is submitted in accordance with sub-clause (C) or (D) of Clause 59 and the lump sum quotation is not accepted by the Employer, then the work ordered under sub-clause (A) of Clause 59 shall be valued in accordance with sub-clause (E) of this Clause.
- (H) The Contractor shall supply the Employer with any further information reasonably requested by the Employer within 14 days of the request to enable him to value any Variation ordered under sub-clause (A) of Clause 59.
- (I) The Employer shall within 28 days of the receipt of the information requested under sub-clause (H) of this Clause notify the Contractor of his valuation.

General Conditions of Employment

61 Rights of Third Parties

Notwithstanding the Contracts (Rights of Third Parties) Ordinance (Chapter 623 of the Laws of Hong Kong), no one other than a party to this Contract will have any right to enforce any of the terms in this Contract.



General Conditions of Contract and Guidelines for Works or Services

A. General Conditions of Contract

- 1. "Contractor" means the person who enters into the contract with the Construction Industry Council or the person or service provider whose quotation has been accepted.
- 2. "Contract" means the Contract, purchase order or letter of acceptance herein including the contents of the Schedule and these general conditions.
- 3. The Works / Services and Variation
 - (a) The works to be undertaken or services to be performed under this Contract shall be as laid down in the Quotation and Special conditions (if any) and shall be carried out to the satisfaction of Construction Industry Council.
 - (b) The Contractor shall not extend the works / services beyond the requirements specified in the Schedule except as directed in writing by Construction Industry Council; but Construction Industry Council may, at any time during the Contract period by notice in writing direct the Contractor to alter, amend, omit, add to, or otherwise vary any of the works / services and/or the contract period, and the Contractor shall carry out such variations, and be bound by the same conditions, so far as are applicable, as though the said variations were stated in the Schedule.
 - (c) Where a variation has been made to this Contract the amount to be added to or deducted from the Contract price in accordance with that variation shall be determined in accordance with the discounted rates specified in the Schedule so far as the same may be applicable and where rates are not contained in the said Schedule, or are not applicable, such amount shall be such sum as is reasonable in the circumstances. In any circumstances, such amount should be subject to the approval of Construction Industry Council.

4. Assignment

The Contractor shall not, without the written consent of Construction Industry Council, assign or otherwise transfer any part of this Contract, and the performance of this Contract by the Contractor shall be deemed to be personal to him.

5. Quality of Works / Services

The works / services shall be as specified in the Schedule and shall fulfil all the conditions and terms of any drawings and specifications (if any) supplied to the Contractor.

6. Compliance with the laws of Hong Kong Special Administrative Region and Valid Licences

The Contractor has to comply with all laws of Hong Kong Special Administrative Region. The Contractor shall not employ illegal workers or any person who are forbidden by the laws of Hong Kong Special Administrative Region or not entitled for whatever reasons to undertake any employment in Hong Kong Special Administrative Region in the execution of this Contract. The Contractor should hold valid licences when performing relevant works if required by law. If there is any breach of this clause, Construction Industry Council may terminate this Contract and the Contractor is not entitled to claim any compensation. The Contractor shall be liable for all financial loss or expenses necessarily incurred by Construction Industry Council as a result of the termination of this Contract.

7. Inspection, Rejection and Acceptance

- (a) The Works undertaken or Services performed shall be subject to inspection by Construction Industry Council who may at its own discretion terminate this Contract or withhold payment unless the works / services have been undertaken / performed in accordance with the terms and conditions of this Contract and to the satisfaction of Construction Industry Council. Upon breach of any essential terms and conditions of this Contract by the Contractor, including but not limited to failure to comply with the performance requirements in accordance with the Schedule, Construction Industry Council shall have the right to reject unsatisfactory performance of the Works / Services and suspend payment until the defects have been rectified by the Contractor to the satisfaction of Construction Industry Council. Construction Industry Council reserves the right to claim against the Contractor for all related financial loss or expenses necessarily incurred by Construction Industry Council.
- (b) Being notified in writing of the rejection of any works / services, the Contractor shall take immediate and necessary action to rectify such rejected Works / Services within reasonable time as agreed by Construction Industry Council.

- (c) If the Contractor shall fail to rectify such rejected works / services in accordance with item (b) above, Construction Industry Council may, without prejudice to any other rights and remedies available to Construction Industry Council, carry out and complete such works / services by its own resources or by other contractors. All costs and expenses whatsoever which may be incurred by Construction Industry Council thereof shall be recoverable in full from the Contractor forthwith.
- (d) The works undertaken or services performed in pursuance of this Contract shall not be deemed to have been accepted unless either:-
 - Construction Industry Council shall so certify; or
 - ii. The works / services are not rejected as being unsatisfactory within 21 working days after receiving the report of certification upon the execution of the work.

8. Payment for works / services

After the receipt of goods and provision of services or completion of works in accordance with the agreed terms and conditions and to the satisfaction of Construction Industry Council, Construction Industry Council will settle payment within 30 days after receiving and verifying the invoices.

- 9. Injury to Persons and Property and Indemnity
 - (a) The Contractor shall be liable for, and shall indemnify Construction Industry Council against, any expense, liability, loss, claim or proceedings whatsoever arising under any statute or at common law in respect of personal injury to or the death of any person whomsoever arising out of or in the course of or caused by the carrying out of the works under the Contract, save to the extent that the same may be due to any act or neglect of Construction Industry Council or of any person for whom Construction Industry Council is responsible.
 - (b) The Contractor shall be liable for, and shall indemnify Construction Industry Council against, any expense, liability, loss, claim or proceedings in respect of any injury or damage whatsoever to any property real or personal in so far as such injury or damage arises out of or in the course of or by reason of the carrying out of the works under the Contract, save to the extent that the same may be due to any act or neglect of Construction Industry Council or of any person for whom Construction Industry Council is responsible.

10. Employee's Compensation Insurance Policy ("EC policy")

- (a) Without prejudice to the Contractor's obligations, liabilities and responsibilities under the Contract and his obligation to insure by law, the Contractor shall at his own expenses warrant to take out and maintain an EC policy covering against all liabilities arising from any death, accident or injury to any workmen or other persons in the employment of the Contractor and any sub-contractor of any tier and Construction Industry Council shall not be liable for any damages or compensation in respect thereof. Such EC policy shall be maintained during the Contract period and for the whole of the time that such workmen or other persons are employed on the works including the Maintenance Period or Defects Liability Period (if applicable).
- (b) Before the commencement of works under the Contract, the Contractor shall, whenever required by Construction Industry Council, produce to Construction Industry Council a copy of the EC policy (include Endorsements W338, W348 and W204) which he is required to effect pursuant to item (a) above together with satisfactory proof of payment of the current premiums thereof.
- (c) If the Contractor shall fail to effect and maintain the EC policy or if the Contractor shall fail to provide any evidence thereof which he is required to by item (b), Construction Industry Council may at its own discretion terminate the Contract.
- (d) In the event of any of the Contractor's sub-contractors of any tier or employees or agents or the subcontractors' employees suffering any injury or death in the course of or arising out of this Contract and whether there be a claim for compensation or not, the Contractor shall within 7 working days give notice in writing of such injury or death to Construction Industry Council.

11. Contractors' All Risks Insurance Policy ("CAR")

- (a) Without limiting the obligations, liabilities and responsibilities of the Contractor under the Contract, Construction Industry Council has effected, with insurers of Construction Industry Council's choice, for the benefit inter alia of Construction Industry Council, the Contractor and his sub-contractors of any tier and other direct specialist contractors a CAR in respect of inter alia:
 - i. Loss and damage to the works under the Contract;
 - ii. Third party liability
 - Refer to Section B for an insurance synopsis and reference should be made thereto for its full terms and effect.
- (b) The Contractor's All Risks / Third Party Liability Insurance only covers contract within the contract details as stated in the Insurance Synopsis of Contractors' All Risks/ Third Party Liability Insurance. Should the contract not within the contract details, contractor must arrange another Contractor's All Risks / Third Party Liability Insurance, joint name with Construction Industry Council, at contractor's own cost. Minimum coverage for third party liability is HK\$30,000,000.

- (c) The Contractor shall for himself and on behalf of all sub-contractors of any tier accept the CAR as if it has been effected by himself and shall with all due diligence observe and fulfil, and procure that all sub-contractors of any tier observe and fulfil, the terms, provisions and conditions contained therein.
- (d) The Contractor shall be deemed to have read and understood the terms, provisions, conditions, exclusions and excesses of the CAR. If, in the Contractor's opinion, the amounts and / or risks insured are insufficient to cover the Contractor's risks, duties, obligations and liabilities under the Contract, at common law or otherwise, the Contractor may effect such further insurance at his own expense as he considers necessary.
- (e) It is acknowledged and understood that the CAR is subject to excesses and exclusions. In the event of a claim under the CAR in respect of a matter for which the Contractor is responsible or liable under the Contract, the full amount of such excesses and exclusions shall be borne by the Contractor. In the event of any default by the Contractor in making good any damage to the works where required by the terms and conditions of the Contract, Construction Industry Council may deduct the applicable policy excess from any sums due or to become due to the Contractor under this Contract or recover the same as a debt due from the Contractor.
- (f) Save for any case in which the relevant loss or injury arises from any act or neglect of Construction Industry Council or any person for whom Construction Industry Council is responsible, all costs and incidental expenses incurred in relation to claims including the preparation and submission of all formal quantified claims under the CAR shall be borne by the Contractor.
- (g) The Contractor shall forward to Construction Industry Council's representative a copy of all notices and claims submitted by him or all sub-contractors of any tier pursuant to the conditions of the CAR within 24 hours of dispatch of such notice or claim. Upon a written request from Construction Industry Council, Construction Industry Council shall be entitled to take over the conduct of any claim submitted by the Contractor or all sub-contractors of any tier under the CAR, and in any such event the Contactor hereby appoints, and shall procure that all sub-contractors of any tier appoint, Construction Industry Council as his or their agent for that purpose.
- (h) All monies to be received under the CAR shall be paid to Construction Industry Council as loss payee. The Contractor and all sub-contractors of any tier hereby irrevocably authorize Construction Industry Council to give good discharge to the insurers for such monies.
- (i) Upon the occurrence of any loss or damage to the works under the Contract, the Contractor with due diligence shall restore works damaged, replace or repair any unfixed materials or goods which have been destroyed or injured, remove and dispose any of debris and proceed with the carrying out and completion of the works. All monies received under the CAR (less any amounts to cover professional fees) shall be paid to the Contractor by instalments under the Interim Payment Certificates or Final Payment Certificates issued by Construction Industry Council's representative. The Contractor shall not be entitled to any payment in respect of the restoration of work damaged, the replacement and repair of any unfixed materials or goods, and the removal and disposal of debris other than the monies received under the said CAR.

12. Bankruptcy or Receivership

Construction Industry Council may at any time by notice in writing summarily terminate the Contract without entitling the Contractor to compensation if the Contractor shall at any time become bankrupt, insolvent, or shall be placed in receivership or go into liquidation or receivership, or if a petition for liquidation, bankruptcy or receivership (whether voluntary or involuntary, save for the purpose of reconstruction or amalgamation) is filed against the Contractor, but without any prejudice to any right or action or remedy which shall have accrued or shall accrue thereafter to Construction Industry Council.

13. Corruption

Construction Industry Council prohibits any member of the staff from soliciting or accepting any advantage. Without the approval of Construction Industry Council, it is an offense under the Prevention of Bribery Ordinance to offer or give any gift, loan, fee, reward, commission, office, employment, contract, other services of favour, discount to any staff of Construction Industry Council. Construction Industry Council will terminate the Contract without prior notice and hold the Contractor liable for any loss or damage so caused to Construction Industry Council.

14. Personal Data Submitted by Contractor

All personal data submitted by the Contractor will be used by Construction Industry Council for the purpose of this Contract only. Under the provisions of the Personal Data (Privacy) Ordinance, the Contractor has the right to request access to or correction of personal data. Written requests should be addressed to Construction Industry Council. Construction Industry Council may be unable to process and consider incomplete information submitted.

15. Working Hours

Unless it is specifically allowed in other part of the Contract, the works under this Contract shall be undertaken during normal working hours as specified by Construction Industry Council.

16. Valid Certificates of Intermediate Trade Testing or higher qualifications Except for carrying out general cleaning, delivering or sweeping tasks or having special approval of Construction Industry Council, all workers employed by the Contractor to work under this Contract have to hold valid certificates of intermediate trade testing (or higher qualifications) relevant to the trades under which they are working. A list of such workers with their valid and relevant qualifications has to be submitted to Construction Industry Council before the commencement of works.

17. Temporary Work Permit

When carrying out the works under the Contract, all workers have to wear the temporary work permit issued by Construction Industry Council. If the temporary work permit is lost, the Contractor or worker has to report to Construction Industry Council and request a re-issue at \$30.

18. Parking

If the Contractor finds it necessary to park their motor vehicles within the premises of Construction Industry Council, application has to be lodged in advance. If the application is approved, the parking permit issued by Construction Industry Council and the contact telephone number of the driver has to be displayed on the motor vehicles.

19. Refuse Removal

All refuse has to be delivered to the refuse collection warehouse specified by Construction Industry Council at the end of each working day or on any dates specified by Construction Industry Council.

20. Rights of Third Parties

Notwithstanding the Contracts (Rights of Third Parties) Ordinance (Chapter 623 of the Laws of Hong Kong), no one other than a party to this Contract will have any right to enforce any of the terms in this Contract.

B. Insurance Synopsis of Contractors' All Risks / Third Party Liability Insurance

1. Summary

Type : Contractors' All Risks – Open Cover

Form : To follow the terms, limits and conditions of Asia Insurance Co Ltd Contractors'

All Risks policy wordings as agreed.

Insured : Construction Industry Council as principal &/or all Main Contractors and its

sub-contractors of every tier.

Period of Insurance : From 00:00 1st January 2017 to 24:00 31st December 2017 Local Hong Kong

Time (both dates inclusive).

Contract Details

: Scope and Nature

Renovation / Restoration / Maintenance / Alteration / Repair Work and/or Installation Work of Building Services including building maintenance work and/or builder's work but excluding construction/erection/demolition of building structure (i.e. structural walls, columns, beams and slabs of a building) and/or

Installation/ Maintenance/ Repair Work of Building Services equipment; office equipment; training equipment; and trade test equipment

carried out at the premises of the Insured which are covered under the Property Policy but definitely excluding any construction sites.

Contract Value of Each Contract

Contract Value at inception must not exceed HK\$3,000,000.

Period of Insurance for Each Contract

- (1) Insured Contract other than Maintenance Contract Work
- (a) Contract Period

Follow the original Contract Period of each contract work provided that: -

- the duration of the Contract Period shall not exceed 120 days;
- the Insured Contract must commence within the Period of Insurance specified in the Schedule

(b) Maintenance Period

Follow the original Maintenance Period of each contract work provided that the duration of the Maintenance Period shall not exceed 12 months immediately after the Original Contract Period.

(2) Maintenance Contract Work only

The Period of Insurance in respect of the Maintenance Work shall follow the original Contract Period of each Maintenance Work provided that:-

- the duration of the Maintenance Work shall not exceed 12 months;
- the Insured Contract must commence within the Period of Insurance specified in the Schedule.

Coverage

: Section I – Material Damage

To indemnify the Insured in respect of loss of or damage to the Insured Property whilst at the site during the Period of Insurance arising from any cause whatsoever not excluded by the original policy.

Insured Property - Item 1

The permanent and temporary works constructed erected or in the course of construction or erection in performance of the contract and all other property for which the insured contractors are responsible under the contract whilst on the site and subject to its value being included in the sum insured however excluding constructional plant and temporary buildings.

Insured Property - Item 2

Removal of debris: costs and expenses necessarily incurred by the Insured with the consent of the Insurers in dismantling and removing debris of the portion or portions of the property insured under item (1) destroyed or damaged by any peril hereby insured against.

Sum Insured: HK\$100,000 any one contract

: Section II - Liability to Third Parties

To indemnify the Insured in respect of all sums which the Insured shall become legally liable for:

- i) Accident death bodily injury illness or disease suffered by any person
- ii) Accidental loss or damage to physical property arising out of the performance of the contract and in addition the insurers shall be liable for
- iii) All costs and expenses of litigation recovered by any claimant against the insured
- iv) All costs and expenses of litigation incurred by the insured with written consent of the insurers in resisting any claim

Limit of Indemnity: HK\$30,000,000 any one accident and unlimited for the period of insurance (Cost inclusive)

Geographical Area: Hong Kong SAR and Jurisdiction

Excess

: Section I - Material Damage

	For contract with	For contract with	For contract with
	value of	value exceeding	value exceeding
	HK\$500,000 or	HK\$500,000 upto	HK\$1,500,000 upto
	<u>below</u>	HK1,500,000	HK\$3,000,000
	HK\$	HK\$	HK\$
Act of God/Fire/Theft:	20,000	25,000	35,000
Others:	20,000	25,000	35,000
Temporary Works:	20,000 min or 50%	25,000 min or 50%	35,000 min or 50% of
	of loss (*)	of loss (*)	loss (*)
Water Damage to	20,000 min or 20%	25,000 min or 20%	35,000 min or 20% of
Work:	of loss (*)	of loss (*)	loss (*)

Section II - Liability to Third Party

HK\$

Third Party Property Damage : 50,000 min or 10% of loss (*)
Vibration : 50,000 min or 20% of loss (*)
Underground Services : 50,000 min or 20% of loss (*)
Oil-Filled/Fibre-Optic Cable : 50,000 min or 40% of loss (*)
Principal Property : 50,000 min or 20% of loss (*)
Water Damage to Third Party Property : 50,000 min or 20% of loss (*)

Third Party Bodily Injury : 50,000

(*) – whichever is the greater

Conditions

: 1. Revised Cross Liability Clause/ As per Asia's standard Contractors' All Risk Policy Jacket

(Inter alia)

- 2. B1 Safety Precaution Clause amended to delete the 24 hours watchman requirement.
- 3. B2 Special Conditions for Underground Services Clause
- 4. A9 Including the risks of strikes, riots and civil commotion
- 5. A6 Extra charges for overtime, night work, work on public holiday and express fright (10% of adjusted loss)
- A1 Extended to cover liability to third party property damage caused by vibration, removal or weakening of support (Limit: HK\$30,000,000 any one accident and in aggregate during any one period of insurance)
- A7 Extended to cover employer's property under the care, custody or control
 of the insured contractors under Section II (Limit: HK\$30,000,000 any one
 period in aggregate)
- 8. Yearly Declaration (CIC has to submit the actual annual turnover with details upon policy expiry)

Page 6 of 8

- 9. Burning and Welding Clause
- 60 Days Cancellation Clause, i.e. the policy may be cancelled by the Insured at any time subject to short-term premium but 60 days' advance notice by the Insurer.
- 11. Extended Maintenance Period Cover
- 12. 60 Days Non-Removal Notice by Insurer
- 13. Claim Control Clause
- 14. 72 hours Clause
- 15. HK Jurisdiction Clause
- 16. Run Off Liability Clause
- 17. Revised Arbitration Clause

Other terms and conditions as per policy wording.

Principal

: 1. Cyber Exclusion

Policy Exclusions (Inter alia)

- Total Asbestos Exclusion
 Pollution Exclusion Clause
- 4. War & Terrorism Exclusion
- 5. Date Related Performance & Functionality Clause (A) and (B)
- 6. Professional Liability Exclusion
- 7. Electromagnetic Radiation Exclusion
- 8. Products Liability Exclusion
- 9. Self-Employed Person and Sole Proprietors Exclusion
- 10. Sanction Clause

Other exclusions as per original policy.

Insurer : Asia Insurance Company Limited – 100%

Policy No. : ABK/ECA/14-60019992

Applicable : Hong Kong SAR

Jurisdiction and/or

Law Practice

2. Contractors' Own Insurance Responsibilities

- (a) The Contractor's All Risks / Third Party Liability Insurance does not cover the liability arising out of or in connection with the following:
 - i. motor vehicles and other Statutory Insurances.
 - ii. employees of the Insured Parties, sole proprietors and self-employed persons acting as sub-contractors, including labour masters and persons supplied by them, persons employed by labour only sub-contractors, self-employed persons, drivers and / or operators of plant hired to the Insured, student gaining work experience, and any other persons hired or borrowed by contractors.

"Contractors allow such persons to enter site at their own risk".

- iii. deductibles of the Policy.
- (b) The Contractor's All Risks / Third Party Liability Insurance does not cover the physical loss of or damage to construction plant tools and equipment owned or leased by the contractors or for which the contractors may be responsible.
- (c) Contractors and Subcontractors are required to arrange Employees' Compensation Insurance complying with the Employees' Compensation Ordinance (Cap 282) in respect of their employees. Such insurance is to be endorsed to cover the Construction Industry Council as an Insured Party.
- (d) The Third Party Liability Insurance cover is HK\$30,000,000. Construction Industry Council advises contractors to review its adequacy in relation to their risks and liability under the contract with the Construction Industry Council and to purchase additional limit, if required, at their own costs.
- (e) The Contractor's All Risks / Third Party Liability Insurance only covers contract within the contract details as stated in the Insurance Synopsis of Contractors' All Risks/ Third Party Liability Insurance. Should the contract not within the contract details, contractor must arrange another Contractor's All Risks / Third Party Liability Insurance, joint name with Construction Industry Council, at contractor's own cost. Minimum coverage for third party liability is HK\$30,000,000.

C. Safety Guidelines

- 1. General Duties of Contractor and Persons Employed
 - Pursuant to the Factories and Industrial Undertakings Ordinance (Cap. 59) and Occupational Safety and Health Ordinance (Cap.509), whilst executing the works under the Contract, it shall be the duty of the Contractor to ensure the health and safety at work of all persons employed by him, and it shall be the duty of every person employed to take care for the safety of himself and of other persons who may be affected by his acts or omissions at work.
- Relevant Mandatory Safety Training Certificates (please select one of the following clauses)
 All subcontractors of all tiers and employees employed by the Contractor to work in the CIC premises under the Contract shall:
 - hold valid Construction Industry Safety Training Certificates (commonly known as "Green Cards") and any other
 relevant mandatory certificates required for safe operation of the works.
 - hold valid Construction Industry Safety Training Certificates (commonly known as "Green Cards") and Specified Trade Safety Training Certificates (commonly known as "Silver Cards") and any other relevant mandatory certificates required for safe operation of the works.
- 3. Safe Means of Access and Egress

The Contractor must maintain the workplace in a safe condition and ensure that every access to and egress from the workplace is safe. The Contractor shall also ensure that all means of escape from the workplace are kept free from obstruction.

4. Personal Protective Equipment

The Contractor must supervise and ensure all his sub-contractors and employees wear appropriate personal protective equipment, e.g. protective clothing, safety helmet, safety shoes, harness, fall arresting system, eye-protector, ear protector, and mask, etc., as Construction Industry Council may consider necessary or appropriate or as legally required. Any such personal protective equipment must be provided, maintained and replaced as necessary by the Contractor at his own expenses.

- No Smoking and Fire Prevention Measures
 Smoking is not permitted in the workplace. If the works involve the use of naked flame, the Contractor must implement sufficient fire prevention measures.
- 6. Working at Height

The Contractor shall take adequate steps to prevent any person from falling from a height of 2 metres or more.

D. Consequences of Breach

If the Contractor, his sub-contractors of all tiers or employees do not comply with the relevant laws of Hong Kong Special Administrative Region and the terms and conditions of this Guidelines, or if the performance of works undertaken by the Contractor causes any damages or losses to Construction Industry Council, Construction Industry Council may at its discretion terminate this Contract and the operations of the Contractor until any non-compliance or the unfavourable operation is rectified. The Contractor shall be liable to any loss or damage so caused to Construction Industry Council. Construction Industry Council shall be entitled to recover in full from the Contractor forthwith. The Contractor shall also lose his right from submitting quotations or tenders to Construction Industry Council in the future.

Additional Information			The Contractor's Declaration
Tender Reference No.: (302) in P/AE/PUR/AGC			If the quotation is accepted, this document together with the tender or quotation will form part of the Contract and I/we hereby agree to comply with them.
Period of Validity:	From commencement date to completion date per contract		
Location of Works / Services:	CIC Kowloon Bay Training Centre, 44 Tai Yip Street, Kowloon Bay, Kowloon, Hong Kong		Name of Contractor:
No. of pages for thi	s document:	8	Signature with Company Chop:
This document was issued on: 19 May 2017		19 May 2017	Date: